

Council Agenda Information

☒ CPAC November 5, 2019



City of Port Moody

Report to Community Planning Advisory Committee

Date: October 28, 2019

Submitted by: Planning and Development Department – Development Planning

Subject: 2025 St. Johns Street

Purpose:

To present to Community Planning Advisory Committee a rezoning application for a six-storey mixed-use development, with approximately 8,000ft² of commercial space and 242 multi-family residential units at 2025 St. Johns Street.

Recommended Resolution

THAT staff and the applicant consider the comments provided during the Community Planning Advisory Committee meeting held on November 5, 2019 regarding the proposed project presented in the report dated October 28, 2019 from the Planning and Development Department – Development Planning Division regarding 2025 St. Johns Street

Applicant:

Marcon Albert (GP) Ltd.

Property Description:

The development site consists of one property, 2025 St. Johns Street, located on the southwest corner of St. Johns Street and Albert Street, as shown on the Location Map (**Attachment 1**).

The total site is approximately 8088.1m² (97,059ft²) in area and has significant grade changes on the western portion of the site before gently sloping towards the northeast corner of the property. South Schoolhouse Creek runs through the southeast portion of the property. The subject property is currently vacant, but was the site of the former Barnet Hotel.

Land Use Policy:

Official Community Plan (OCP):

The OCP designates the subject lands as Mixed Use – Moody Centre, which permits commercial and residential development ranging up to six storeys in height.

The site is located within the Westport Evergreen Line Sub-Area and Development Permit Area 2: Moody Centre, which regulates the form and character of multi-family residential developments. The site is also located within Development Permit Area 4: Environmentally Sensitive Areas related to South Schoolhouse Creek and an Environmentally Sensitive Area located on the western portion of the property.

Zoning:

The subject lots are presently zoned Automobile Sales and Leasing (C5), with a site specific allowance for a Licensee Retail Store on the subject property.

The OCP, Zoning designation, and Environmentally Sensitive Area maps are included as **Attachments 2, 3, and 4.**

Neighbourhood Context:

Surrounding development mainly consists of the following:

- North: Medium Density Townhouse Residential (RM4) lots developed as three-storey apartment buildings and Automobile Sales and Leasing (C5) occupied by Craftsman Collision.
- East: Single Detached Residential (RS1) lots, including a vacant lot and a lot developed with a single family home;
- South: Civic Service (P1) which includes the location of South Schoolhouse Creek and Port Moody Secondary School beyond that to the south; and
- West: Single Detached Residential (RS1) lots, developed with single family homes, though these properties are under application by Bold Properties for a rezoning for a six-storey multi-family project;

Proposal:

The applicant is proposing to rezone the subject site from Automobile Sales and Leasing (C5) to Six-Storey Mixed Use (CRM2). The development proposal consists of a six-storey mixed-use building over an underground parkade. The proposal includes 242 condominium units and 736m² (7,927ft²) of commercial space, located at the northeast corner of the development. The proposal has a density, or floor area ratio (FAR) of 2.23, which is within the 2.5 FAR permitted under the CRM2 Zone. The development proposes the following unit mix:

- 119 studio units;
- 49 one-bedroom units;
- 70 two-bedroom units; and
- four three-bedroom units.

Additional key elements of the proposal include:

- 22 units which are proposed to be dedicated for market-rental housing for a period of 20 years;

- a public art component, with a proposed budget of \$200,000, that would include a standalone piece that would be located at the highly visible corner of St. Johns Street and Albert Street and also a component that would be incorporated within the building façade;
- a project target of Built Green Gold equivalent; and
- retention, restoration and enhancement of the South Schoolhouse Creek riparian area and also High Value Environmentally Sensitive Area.

Reduced project plans are included as **Attachment 5**. A letter of intent provided by the project proponent is included as **Attachment 6**.

Access and Parking

Vehicle access to the site and underground parking is provided from Albert Street.

In total, 331 parking spaces would be required, with 322 currently being proposed, resulting in a shortfall of 9 spaces, though depending on the amount and type of rental housing incorporated the required amount of parking may be reduced.

In accordance with the Zoning Bylaw, 100% of all residential parking spaces (268 spaces) will have electric vehicle charging infrastructure and 20% of commercial spaces (4 spaces) shall have Level 2 energized charging capability.

A total of 364 long-term residential bicycle parking spaces and are provided, which meets the Zoning Bylaw requirements.

Amenity Space

The proposal provides a total of 848.4m² (9,132ft²) of common amenity space, which is comprised of an indoor amenity room 220.5m² (2,373ft²) in size and an outdoor amenity space with an area of 627.9m² (6,759ft²). This meets and exceeds the Zoning Bylaw requirement for apartment buildings of 3.0m² (32ft²) per unit under the CRM2 Zone. The ground floor indoor amenity space consists of a gym, meeting room, seating and lounge areas, with outdoor space consisting of an open turf area and a children's play space. On the 6th floor there is an amenity room along with a kitchen, dining spaces, seating area and activity space which is connected to a rooftop patio, with an outdoor barbeque and dining area and community garden beds. In addition to the indoor and outdoor common amenity spaces, each individual unit has its own balcony or patio space.

South Schoolhouse Creek

The Zoning Bylaw setback for South Schoolhouse Creek requires a 20-meter Riparian Management Zone measured from the top of bank, which includes:

- a 15-meter Riparian Protection and Enhancement Area (RPEA), a 'no touch/no build' area that should not be impacted by any construction-related activities (apart from enhancement work); and

- a 5-meter Riparian Transition Area (RTA), an area where certain features or activities may be permitted including construction-related activities (e.g., work zones), landscaping, stormwater management, and trails.

The proposal is requesting a setback variance to the RTA for a 70m² (753ft²) portion of the building at the southwest corner of Building 2 (South). A map detailing the proposed conditions is included as part of **Attachment 5**.

Sustainability Report Card

The completed Sustainability Report Card for the development proposal is included as **Attachment 7** and the following table summarizes the initial scoring. The scoring may be revised throughout the review process of the project.

<div> <div>Sustainability Pillar</div> <div>Application</div> </div>	Cultural	Economic	Environmental	Social	Overall Total
2025 St. Johns Street	50% (7 out of 14)	46% (6 out of 13)	70% (40 out of 57)	45% (17 out of 38)	57%

Implementation

For the proposal to proceed the following would be required:

- a rezoning of the property to CRM2;
- adoption of a housing agreement bylaw to secure any rental component; and
- issuance of a Development Permit for form and character and environmentally sensitive areas.

Stage of the Application in the Review Process:

The development application procedures allow CPAC comments and consideration early in the review process. As part of the first review of the application, CPAC is being asked to comment on the proposal.

Items for Further Review:

Based on the present submission, the project is consistent with the Official Community Plan designation and the design generally complies with the applicable development permit area guidelines for the regulation of the form and character of mixed-use development. However, the following topics will be further reviewed by staff:

- proposed amount of commercial space;
- proposed unit mix;

- traffic considerations; and
- proposed rental housing provision;


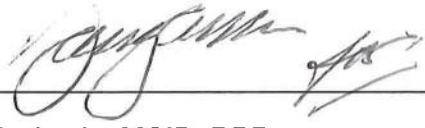

Prior to Council consideration, staff will ensure that the technical reports address the environmental aspects associated with the proposal.

Concluding Comments:

The proposed development is for a six-storey mixed-use building, which is consistent with the land use direction identified in the OCP and at a density that complies with the applicable CRM2 zone for such a building.

Attachment(s)


1. Location Plan.
2. OCP Designation Map.
3. Zoning Map.
4. Environmental Sensitive Areas Map
5. Reduced Project Plans.
6. Letter of Intent
7. Sustainability Report Card.


Prepared by:	Reviewed by:
 Kevin Jones, MCIP, RPP Senior Planner	 Chris Jarvie, MCIP, RPP Manager of Development Planning  André Boel, MCIP, RPP General Manager of Planning and Development


LOCATION MAP - 2025 St. Johns Street

 **SUBJECT PROPERTY**



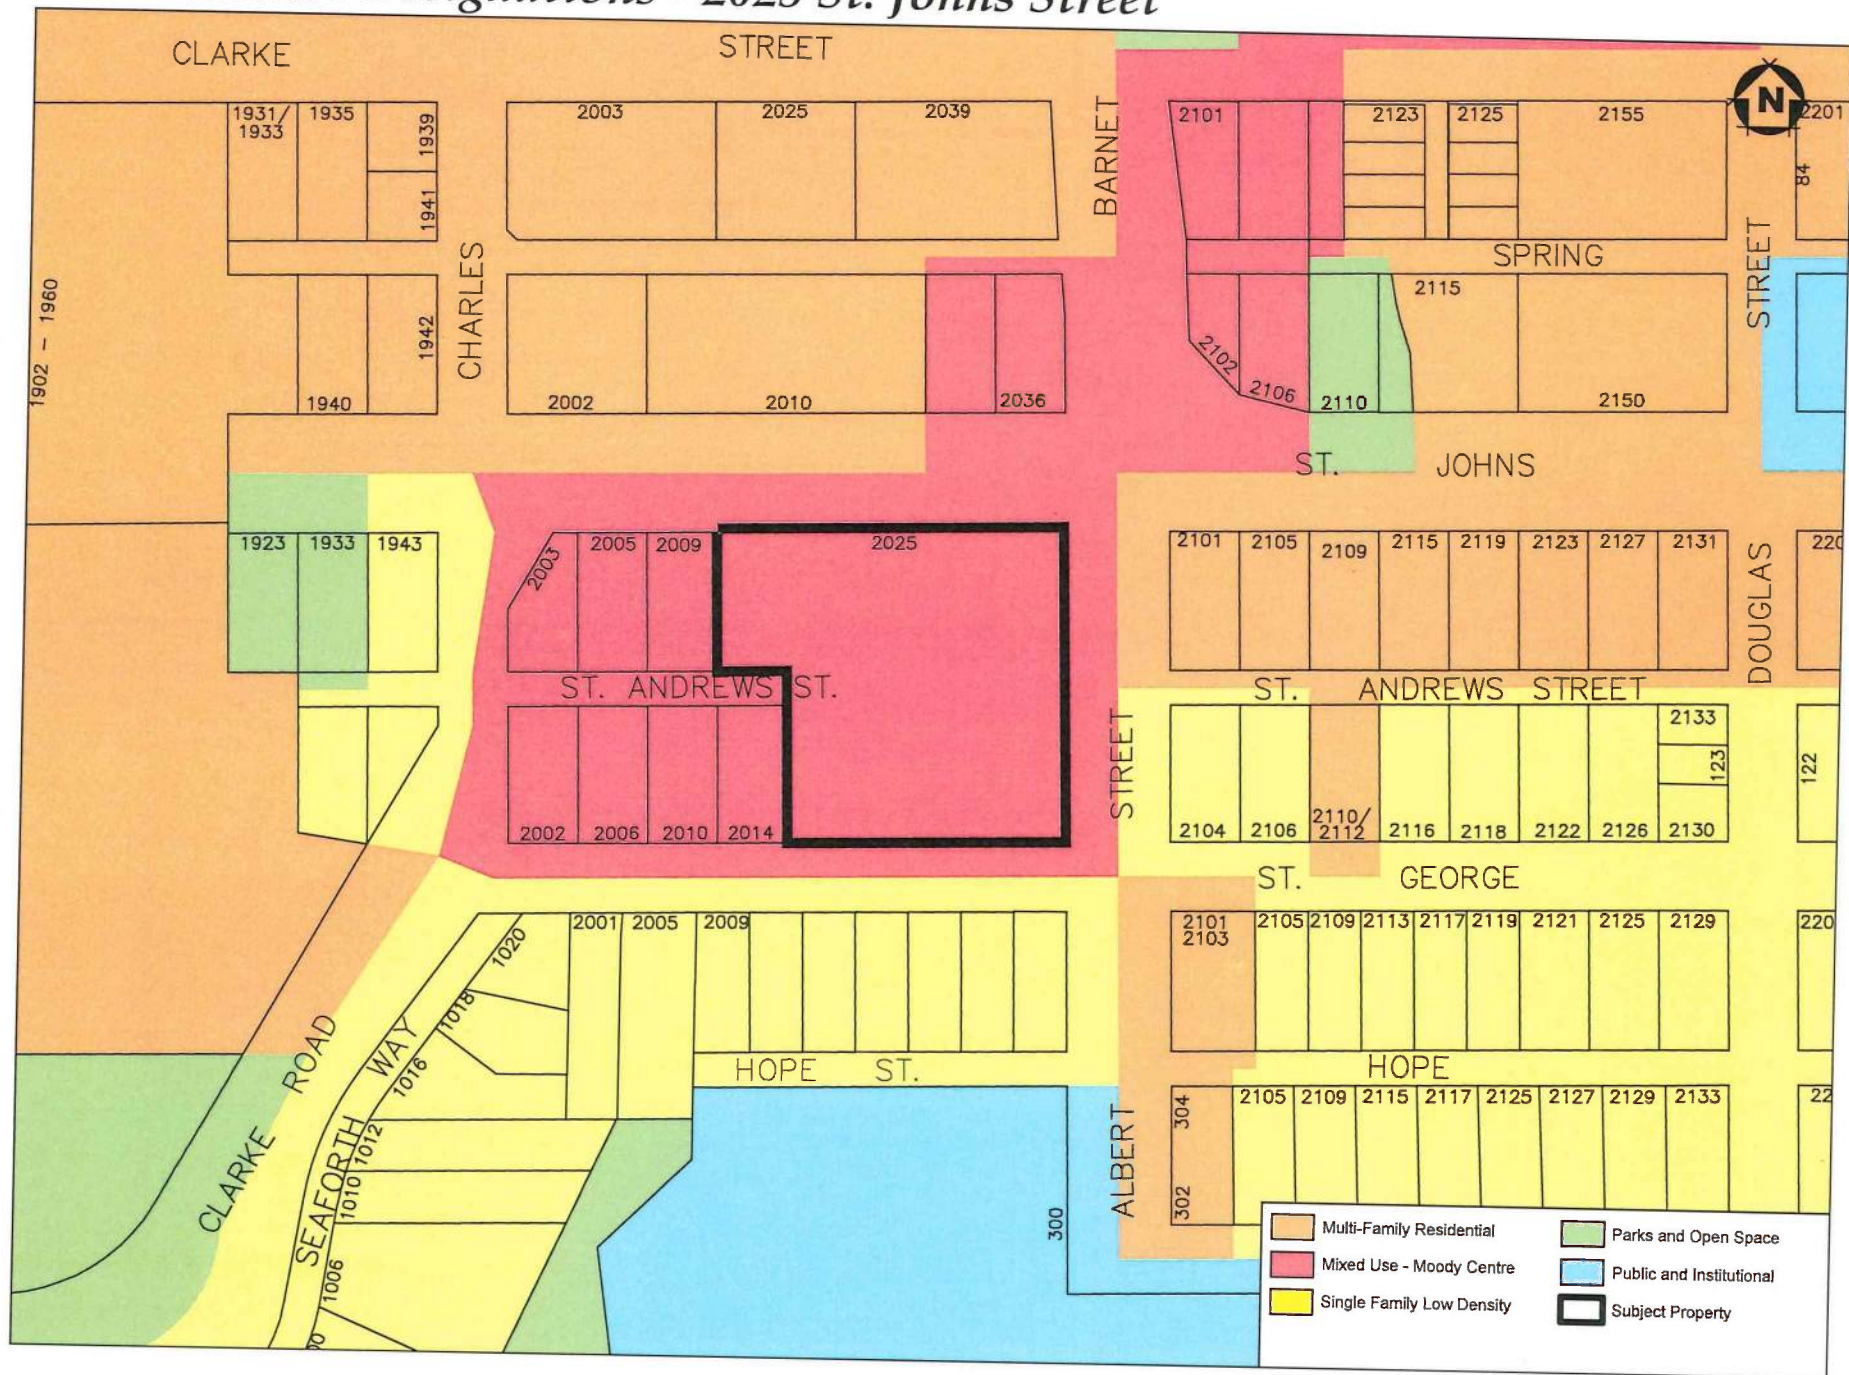

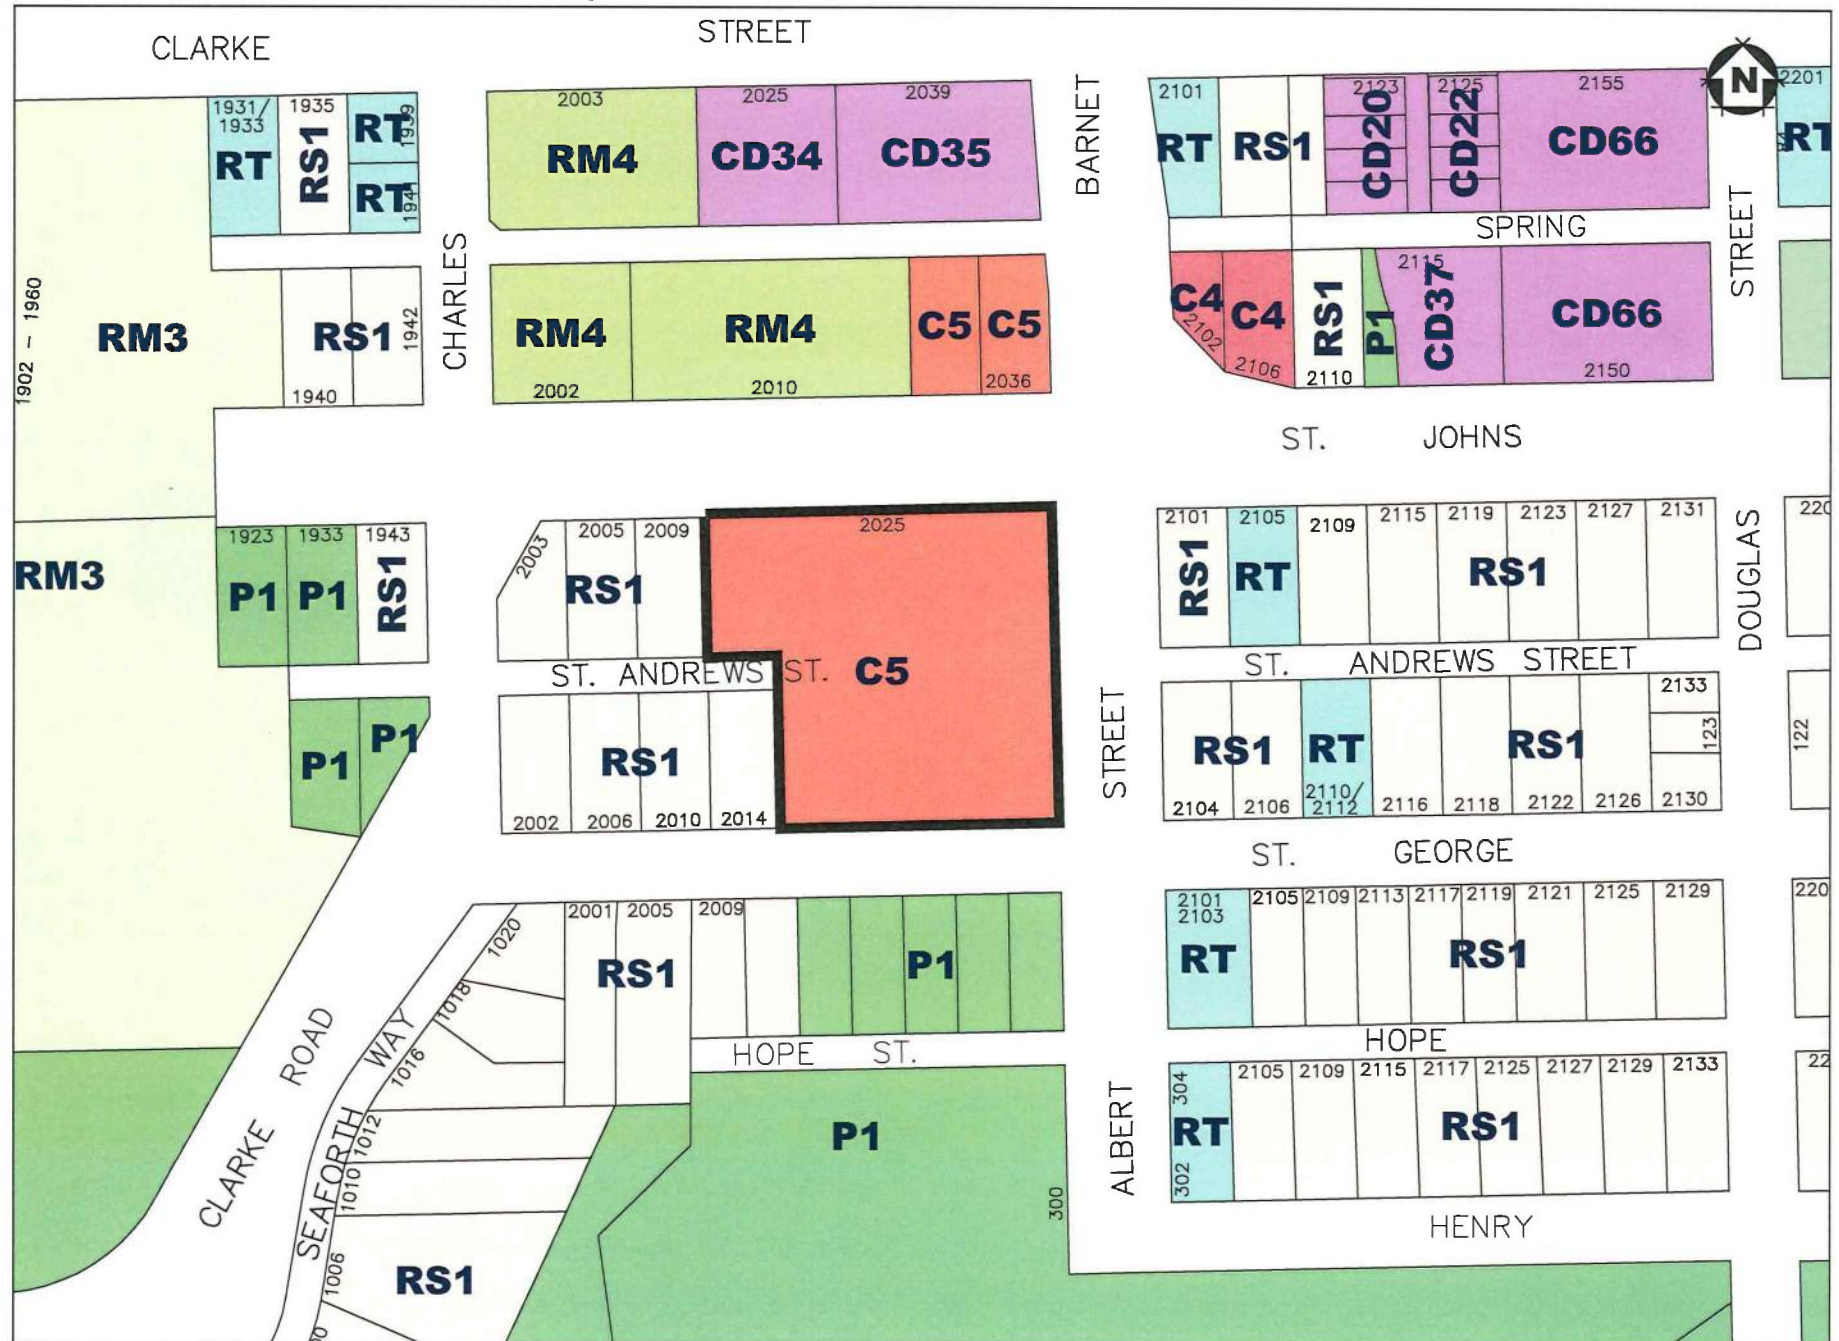ZONING MAP - 2025 St. Johns Street**☐ SUBJECT PROPERTY**

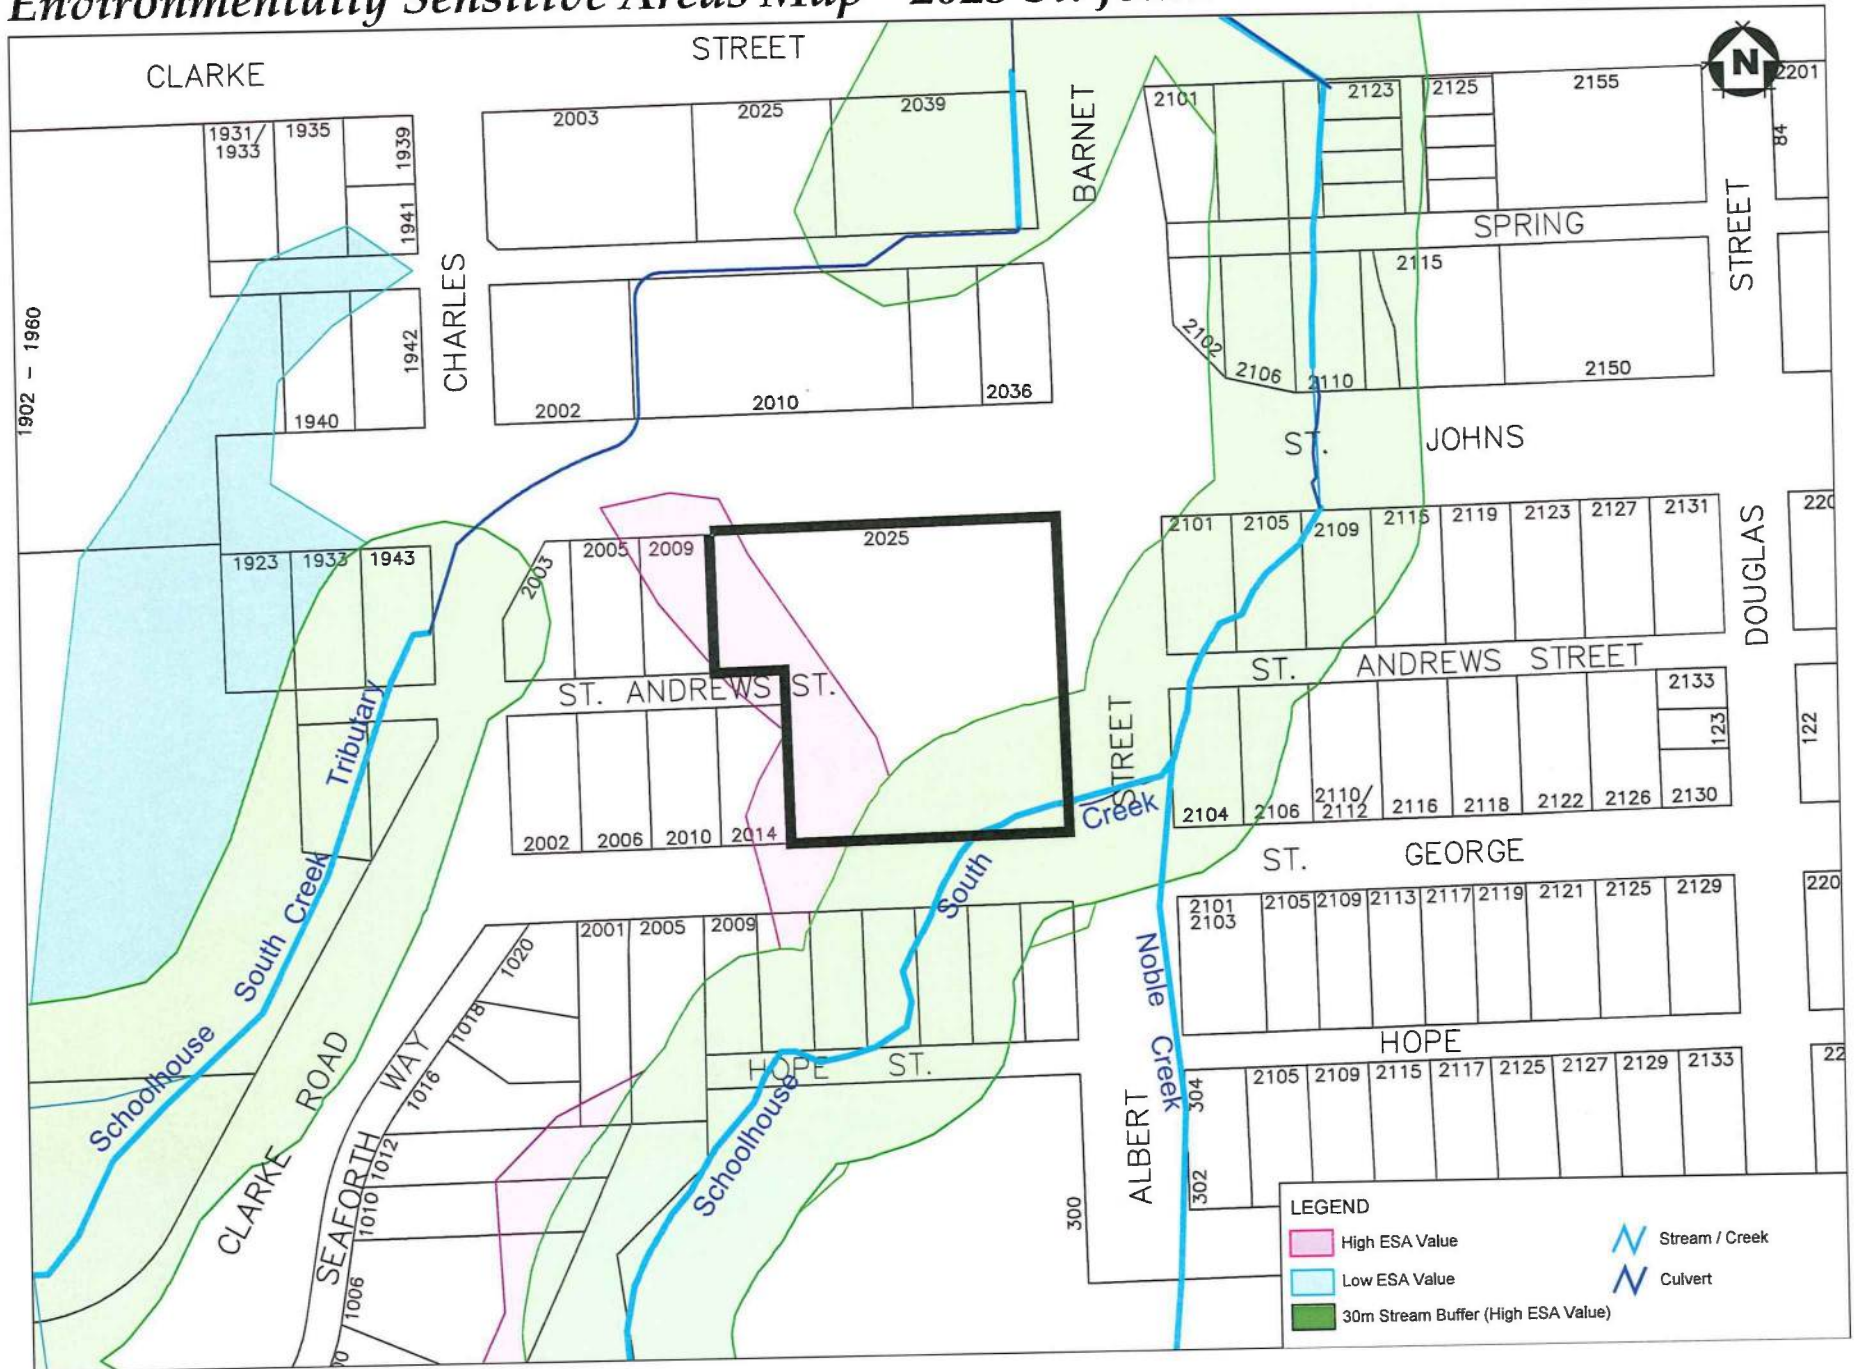
Environmentally Sensitive Areas Map - 2025 St. Johns Street

ALBERT STREET RESIDENTIAL DEVELOPMENT

This architectural rendering depicts a modern, multi-story residential development. The building features a light-colored facade and numerous balconies with vibrant, multi-colored glass railings in shades of blue, red, yellow, and green. A central vertical element, possibly a staircase or a decorative screen, is visible on the building's facade. The ground floor is dedicated to commercial use, with storefronts for a 'Medical Clinic', a business offering 'Family Practices | Walk-In | Specialists', and an 'INSURANCE BROKER'. The building is surrounded by lush greenery, including trees and a landscaped area with a playground structure. In the foreground, a paved road with a yellow curb and a crosswalk is shown, with a few pedestrians and a white car. The scene is set under a clear blue sky.

VIEW FROM INTERSECTION OF ALBERT & ST. JOHN'S STREET TO SOUTHWEST

DRAWING LIST

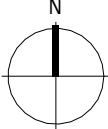

2025 ST. JOHNS STREET

BICYCLES	Bicycle - Long Term		Horizontal Stalls		Vertical Stalls		Lockers		Bicycle - Short Term	
	Required	Provided	Maximum	Provided	Maximum	Provided	Required	Provided	Required	Provided
Residential	363	364	N/A	274	N/A	90	N/A		12	12
Visitor	N/A		N/A		N/A		N/A			
Commercial	1									6
Total Parking	364	364		274		90			12	18

BUILDING HEIGHT				
Allowable	6 Stories			
Proposed				
Building 1	6 Stories	60.67 ft	or	18.49 m
Building2	6 Stories	64.53 ft	or	19.67 m

BALCONY SUMMARY		
FSR Area		194,195.1 sq. ft.
Proposed	9.78%	18,990.0 sq. ft.

PUBLIC ART CONSULTANT

BALLARD FINE ART
1243 Duchess Avenue, West Vancouver, BC, V7T 1H3
(604) 992.6843

FSR 0.00	FSR SUMMARY
FSR 1.00	ALL OVERLAYS
FSR 1.01	FSR OVERLAY L1
FSR 1.03	FSR OVERLAY L3
FSR 1.04	FSR OVERLAY L4
FSR 1.05	FSR OVERLAY L5
FSR 1.06	FSR OVERLAY L6
FSR 1.07	FSR OVERLAY P1
Grand total: 8	

A3.02	LEVEL 2
A3.03	LEVEL 3
A3.04	LEVEL 4
A3.05	LEVEL 5
A3.06	LEVEL 6
A3.07	ROOF PLAN
A3.11	B1 - LEVEL 1
A3.12	B1 - LEVEL 2-6 - TYPICAL
A3.17	B1 - ROOF PLAN
A3.21	B2 - NORTH - LEVEL 1
A3.22	B2 - NORTH - LEVEL 2-5 - TYPICAL
A3.26	B2 - NORTH - ROOF PLAN
A3.31	B2 - SOUTH - LEVEL 1
A3.32	B2 - SOUTH - LEVEL 2-5 - TYPICAL
A3.36	B2 - SOUTH - LEVEL 6
A3.37	B2 - SOUTH - ROOFPLAN
A4.01	STREETSCAPES
A4.02	MATERIALS SCHEME
A4.11	B1 - ELEVATIONS
A4.12	B1 - ELEVATIONS
A4.21	B2 - NORTH - ELEVATIONS
A4.22	B2 - NORTH - ELEVATIONS
A4.23	B2 - SOUTH - ELEVATIONS
A4.24	B2 - SOUTH - ELEVATIONS
A5.01	BUILDING SECTIONS

A	2019/09/06	ISSUED FOR RZ/DP
No.	Date	Revision Notes

2025 Saint Johns Street
Port Moody, BC

5645 199 Street
Langley, BC V3A 1H9

Sheet Title
COVER SHEET

Drawn By	Author
Reviewed by	Approver

Project
1805

<i>Plot Date</i>	<i>Issue Date</i>
2019/08/30	2019/09/06

Scale	Issue/Revision
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As indicated **A**

Sheet Number

A0.00



	GRIDLINE REFERENCE		CEILING TAG
	LEVEL / ELEVATION REFERENCE		MATERIAL TAG
	SECTION DETAIL REFERENCE TAG		SPOT ELEVATION TAG
	BUILDING SECTION / WALL SECTION TAG		BUILDING GRADE TAG
	BUILDING ELEVATION TAG		INTERPOLATED BUILDING GRADE TAG
	PLAN REFERENCE CALLOUT TAG		SURVEY GRADE TAG
	ROOF TAG		AREA DRAIN TAG
	FLOOR TAG		CATCH BASIN DRAIN TAG
	WALL TAG		DECK DRAIN TAG
	WINDOW/CURTAIN WALL TAG		FLOOR DRAIN TAG
			PLANTER DRAIN TAG
			ROOF DRAIN TAG
			SLAB DRAIN TAG

AD	Acoustic Ceiling Tile	FTG	Footing	PROP	Proposed
AD	Area Drain	FURN	Furnishing/Furniture	PT	Pressure treated
AFF	Above Finished Floor			PTD	Painted
AGG	Aggregate	GA	Gauge	PVC	Polyvinyl chloride
AHU	Air Handling Unit	GALV	Galvanized	PWR	Power
AL or ALUM	Aluminum	GEN	Generator		
ANNUN	Annunciator	GI	Galvanized Iron	QTY	Quantity
ANOD	Anodized	GL	Glass	QU	Square
APPROX	Approximate/Approximately	GLB	Glass Block or GL BLK		
ARCH	Architecture/Architectural	GRD/FL	Ground Floor	RB	Rubber Base
AUTO	Automatic	GWB	Gypsum Wall Board	RCD	Reflected Ceiling Plan
AUX	Auxiliary	GWG	Georgian Wire Glass	ROF	Roof Drain
		GYP	Gypsum	RECIRC	Recirculate
BD	Board			RECT	Rectangle
BALC	Balcony	HB	Hose Bibb	REF	Reference
BF	Barrier Free	HC	Handicapped	REFR	Refrigerator
BG	Building Grade	HDR	Header	REINF	Reinforced
BLDG	Building	HDWD	Hardwood	REINF/CONC	Reinforced Concrete
BLK	Block	HM	Hollow Metal	REINF/ST	Reinforced Steel
BM	Bench Mark	HOR	Horizontal	REPL	Replace
BOW	Bottom of Wall	HSG	Housing	REQD	Required
BR	Bedroom	HT	Height	RET	Return
BSMT	Basement	HW	Hot water	REV	Reverse
		HWY	Highway	RFG	Roofing
C/W	Complete With	HYD	Hydrant	RI	Rigid Insulation
C to C	Centre to Centre	HZ	Horizontal	RM	Room
CAB	Cabinet			RND	Round
CAV	Cavity	IBG	Interpolated Building Grade	RO	Rough Opening
CB	Catch Basin	ID	Inside Diameter	RTU	Roof Top Unit
CEIL	Ceiling	ILLUM	Illuminate	RUB	Rubber
CER	Ceramic	INCL	Include/Including	RWL	Rainwater Leader
CIP	Cast in place	INFO	Information		
CL	Construction/Control Joint	INSUL	Insulate/ion	S	South
CL	Centre Line	IRR	Irregular	S/ST	Stainless Steel
CLOS	Closet			SAMT	Self-Adhered Membrane
CLR	Clear/Clearance	JB	Junction Box	SAN	Sanitary
CMP	Composite Metal Panel	JT	Joint	SCHED	Schedule
CMU	Concrete Masonry Unit			SCHEM	Schematic
COAX	Coaxial	K/D	Kiln/Dried	SCUP	Scupper
COL	Column			SD	Shower Drain
COMM	Communication	L	Length	SD/BL	Sand Blast
COMP	Composite	LAB	Laboratory	SECT.	Section
CONC	Concrete	LAM	Laminate/Laminated	SGL	Survey Grade
CONST	Construction	LAV	Lavatory	SGL	Single
CONT	Continuous	LEV	Level	SK	Sketch
CONTR	Contractor	LG	Laminated Glass	SP	Sandrel
CORR	Corrugated	LIN	Linear	SPEC	Specification
CPT	Carpet	LINO	Linoleum Floor	SPHER	Spherical
CRS	Cabinet	LINO/B	Linoleum Base	SS	Stainless Steel
CRU	Commercial Retail Unit	LINO/FL	Linoleum Floor	ST	Street
CT	Ceramic Tile	LR	Living Room	ST	Steel of STL
CTR	Centre	LTG	Lighting	STD	Standard
CW	Cold Water	LWR	Lower	STOR	Storage
CWP	Composite Wood Panel			STRUCT	Structural
		MAINT	Maintenance	SUB	Substitute
DBL	Double	MATL	Material	SUSP	Suspend
DET	Detail	MAX	Maximum	SYM	Symmetrical
DD	Deck Drain	MECH	Mechanical	SYS	System
DF	Drinking Fountain	MED	Medium		
DIA	Diameter	MEMB	Membrane		
DIAG	Diagonal	MER	Meridian	T&G	Tongue and Groove
DIM.	Dimension	MEZZ	Mezzanine	T/O or T.O.	Top Of
DN	Down	MFR	Manufacture	TB	Tile Base
DPT	Department	MH	Manhole	TEL	Telephone
DWG	Drawing	MIN	Minimum	TEL COMM	Telecommunication
		MISC	Miscellaneous	TEMP	Temperature
E/W	East/West or E-W	MSNRY.	Masonry	TG	Tempered Glass
EG	For Example	MT	Metal	THR	Threshold
EL	Elevation (Above Datum)	MUN	Municipality	TLG	Tempered and Laminated Glass
ELC	Electrical			TOC	Top of Concrete
ELEV	Elevation (View)	N	North	TOF	Top of Finish
ELEV.	Elevator	N/S	North/South	TOFF	Top of Finished Floor
EMERG	Emergency	NEG	Negative	TOL	Tolerance
EMR	Elevator Machine Room	NIC	Not in Contract	TOW	Top of Wall
ENC	Enclosure	NO.	Number or #	TV	Television
ENG	Engineering	NOM	Nominal	TYP	Typical
EQ	Equal	NTS	NTS		
EQUIV	Equivalent			U/G	Underground
EQUIPT	Equipment	O/A	Overall	U/S	Underse
ESCL	Escalator	OBS	Obsolete	ULT	Ultimate
EST	Estimate	OC	On Centre	UNFIN	Unfinished
EXIST.	Existing	OCT	Octagon	UNIV	Universal
EXP	Exposure	OD	Outside Diameter	UNO	Unless Noted Otherwise
EXT.	Exterior	OF5	Overflow Scupper		
		OPNG	Opening	VB	Vapor Barrier
FG	Frosted Glass	OPP	Opposite	VCT	Vinyl Composite Tile
F to F	Face to Face	ORIG	Original	VENT	Ventilate
F/F or FF	Fire Fighters			VERT	Vertical
F/S or FS	Fire Stop	PD	Parallel	VEST	Vestibule
FZ5	Finish Two sides	PAR	Planter Drain	VEST	Vestibule
FAB	Fabricate	PWDR	Powder	VFL	Vinyl Sheet Flooring
FCP	Fibre Cement Panel	PH	Penthouse	VOL	Volume
FD	Floor Drain	PKG	Package	W	West
FE	Fire Extinguisher	PL	Plate	W/	With
FF	Finished Floor	PLAM			

SHIFT

ARCHITECTURE

200,1000 West 3rd Street
North Vancouver, BC V7P 3J6
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No.	Date	Revision Notes
A	2019/09/06	ISSUED FOR RZ/DP

No.	Date	Revision Notes

PROJECT TITLE

MARCON ALBERT STREET

2025 Saint Johns Street
Port Moody, BC

Client/Owner

MARCON ALBERT (GP) LTD.

5645 199 Street
Langley, BC V3A 1H9

Sheet Title

ABBREVIATIONS

Drawn By

Reviewed by

Author

Approver

Project Number

1805

Plot Date

2019/08/30

Issue Date

2019/09/06

Scale

12" = 1'-0"

Issue/Revision

A

Sheet Number

A0.01

ISSUED FOR RZ/DP - 06 SEPT 2019

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ISSUED FOR RZ/DP - 06 SEPT 2019

Project Title

ALBERT STREET

2025 Saint Johns Street
Port Moody, BC

MARCON

Client/Owner
MARCON ALBERT (GP) LTD.

5645 199 Street
Langley, BC V3A 1H9

Sheet Title
SITE PLAN

Drawn By	Author
Reviewed by	Approver

Project Number
1805

<i>Plot Date</i>	<i>Issue Date</i>
2019/08/30	2019/09/06

Scale Issue/Revision
1" = 30' 0" **A**

Sheet Number

A1.00

14/09/19 6:11:42 AM

C:\REVIT 2019\LOCAL FILES\1805 ALBERT BUILDING (Central)_shiftarchitecture.rvt



VIEW FROM NW (SAINT JOHNS ST.)



VIEW FROM SE (ALBERT STREET)

SHIFT
ARCHITECTURE

200,1000 West 3rd Street
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No.	Date	Revision Notes

A	2019/09/06	ISSUED FOR RZ/DP
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Project Title
ALBERT STREET

2025 Saint Johns Street
Port Moody, BC

MARCON

Client/Owner
MARCON ALBERT (GP) LTD.

5645 199 Street
Langley, BC V3A 1H9

Sheet Title
PERSPECTIVES

Drawn By	Author
Reviewed by	Approver

Project Number
1805

Plot Date	Issue Date
2019/08/30	2019/09/06

Scale	Issue/Revision
	A

Sheet Number
A0.032

[illegible]

MATERIAL LEGEND

- | | |
|---------------|--|
| RF-01 | ALUMINUM SOFFIT - GENTEK - 16" 4 PANEL SOLID 'RAINWARE WHITE': 'SOFFIT VENT TO BE WHITE' |
| RF-02 | PAINTED ALUMINUM SOFFIT - GENTEK - 16" 4 PANEL SOLID 'RAINWARE WHITE': TO MATCH BM 2017-60 'PALE DAFFODIL' |
| RF-03 | PAINTED ALUMINUM SOFFIT - GENTEK - 16" 4 PANEL SOLID 'RAINWARE WHITE': TO MATCH BM 2012-60 'CREAMY PEACH' |
| RF-04 | PAINTED ALUMINUM SOFFIT - GENTEK - 16" 4 PANEL SOLID 'RAINWARE WHITE': TO MATCH BM 2048-60 'JAMAICAN AQUA' |
| RF-05 | PAINTED ALUMINUM SOFFIT - GENTEK - 16" 4 PANEL SOLID 'RAINWARE WHITE': TO MATCH BM 2067-60 'WINDMILL WINGS' |
| RF-06 | WOODLIKE CEMENTITIOUS SOFFIT - WOODTONE RUSTIC SERIES 5.25" 'SUMMER WHEAT' - 'SOFFIT VENT TO BE BLACK' |
| RG-01 | GUARDRAIL (ALUMINUM) - POWDER COAT - RAL 7016' ANTHRACITE GREY' WITH CLEAR GLAZING PANELS |
| RG-02 | GUARDRAIL (ALUMINUM) - POWDER COAT - RAL 7016' ANTHRACITE GREY' WITH TEMPERED TRANSPARENT GLAZING PANELS (ORANGE: SAHARA SUN, GOLDEN LIGHT, RUBY RED) |
| RG-03 | GUARDRAIL (ALUMINUM) - POWDER COAT - RAL 7016' ANTHRACITE GREY' WITH TEMPERED TRANSPARENT GLAZING PANELS (RED: RUBY RED x2, TANGERINE) |
| RG-04 | GUARDRAIL (ALUMINUM) - POWDER COAT - RAL 7016' ANTHRACITE GREY' WITH TEMPERED TRANSPARENT GLAZING PANELS (MARINE: AQUAMARINE x2) |
| RG-05 | GUARDRAIL (ALUMINUM) - POWDER COAT - RAL 7016' ANTHRACITE GREY' WITH TEMPERED TRANSPARENT GLAZING PANELS (BLUE: SAPPHIRE, RUBY RED, SAPPHIRE CORAL ROSE) |
| TMP-01 | PAINTED FASCIA - TO MATCH BM CC-117 'SIMPLY WHITE' |
| TMP-02 | PAINTED FASCIA - TO MATCH BM 2133-30 'DAY'S END' |
| TMP-03 | PREFINISHED ALUMINUM GUTTER - GENTEK 'SLATE' 523 TO MATCH BM 2133-30 'DAY'S END' |
| TMP-04 | PREFINISHED ALUMINUM RWL 3 DIA. - GENTEK 'SLATE' 523 |



ISSUED FOR RZ/DP - 06 SEPT 2019

2025 Saint Johns Street
Port Moody, BC

MARCON

5645 199 Street
Langley, BC V3A 1H9

Drawn By	Author
Reviewed by	Approver


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Plot Date	Issue Date
2019/08/30	2019/09/06

Scale	Issue/Revision
1 2 3 4 5	A

Sheet Number




A4.11

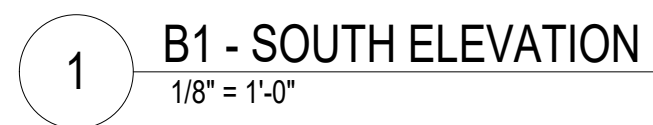

MATERIAL LEGEND

- | | |
|---------------|---|
| RF-01 | ALUMINUM SOFFIT - GENTEK - 16" 4 PANEL SOLID 'RAINWARE WHITE' - 'SOFFIT VENT TO BE WHITE' |
| RF-02 | PAINTED ALUMINUM SOFFIT - GENTEK - 16" 4 PANEL SOLID 'RAINWARE WHITE' - TO MATCH BM 2017-60 'PALE DAFFODIL' |
| RF-03 | PAINTED ALUMINUM SOFFIT - GENTEK - 16" 4 PANEL SOLID 'RAINWARE WHITE' - TO MATCH BM 2012-60 'CREAMY PEACH' |
| RF-04 | PAINTED ALUMINUM SOFFIT - GENTEK - 16" 4 PANEL SOLID 'RAINWARE WHITE' - TO MATCH BM 2048-60 'JAMAICAN AQUA' |
| RF-05 | PAINTED ALUMINUM SOFFIT - GENTEK - 16" 4 PANEL SOLID 'RAINWARE WHITE' - TO MATCH BM 2067-60 'WINDMILL WINGS' |
| RF-06 | WOODLIKE CEMENTITIOUS SOFFIT - WOODTONE RUSTIC SERIES 5.25" 'SUMMER WHEAT' - 'SOFFIT VENT TO BE BLACK' |
| RG-01 | GUARDRAIL (ALUMINUM) - POWDER COAT - RAL 7016 'ANTHRACITE GREY' WITH CLEAR GLAZING PANELS |
| RG-02 | GUARDRAIL (ALUMINUM) - POWDER COAT - RAL 7016 'ANTHRACITE GREY' WITH TEMPERED TRANSPARENT GLAZING PANELS (ORANGE: SAHARA SUN, GOLDEN LIGHT, RUBY RED) |
| RG-03 | GUARDRAIL (ALUMINUM) - POWDER COAT - RAL 7016 'ANTHRACITE GREY' WITH TEMPERED TRANSPARENT GLAZING PANELS (RED: RUBY RED x2, TANGERINE) |
| RG-04 | GUARDRAIL (ALUMINUM) - POWDER COAT - RAL 7016 'ANTHRACITE GREY' WITH TEMPERED TRANSPARENT GLAZING PANELS (MARINE: AQUAMARINE x2) |
| RG-05 | GUARDRAIL (ALUMINUM) - POWDER COAT - RAL 7016 'ANTHRACITE GREY' WITH TEMPERED TRANSPARENT GLAZING PANELS (BLUE: SAPPHIRE, RUBY RED, SAPPHIRE, CORAL ROSE) |
| TMP-01 | PAINTED FASCIA - TO MATCH BM OC-117 'SIMPLY WHITE' |
| TMP-02 | PAINTED FASCIA - TO MATCH BM 2133-30 'DAY'S END' |
| TMP-03 | PREFINISHED ALUMINUM GUTTER - GENTEK 'SLATE' S23 TO MATCH BM 2133-30 'DAY'S END' |
| TMP-04 | PREFINISHED ALUMINUM RWL 3 DIA. - GENTEK 'SLATE' S23 |



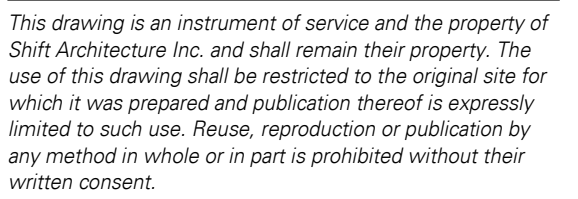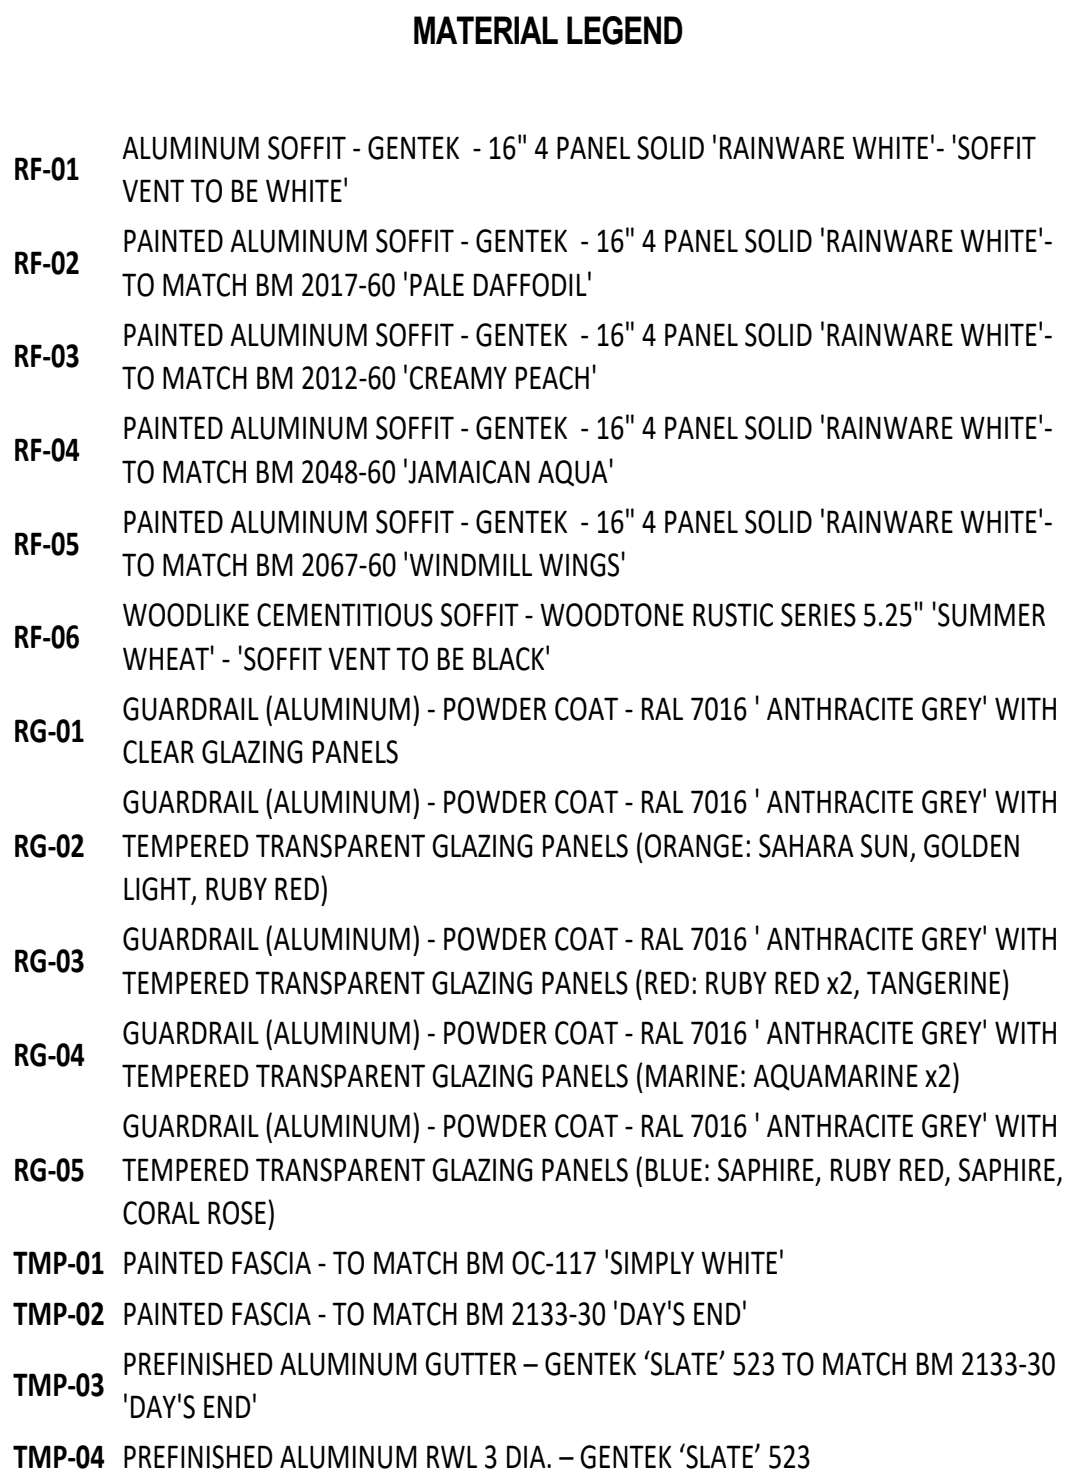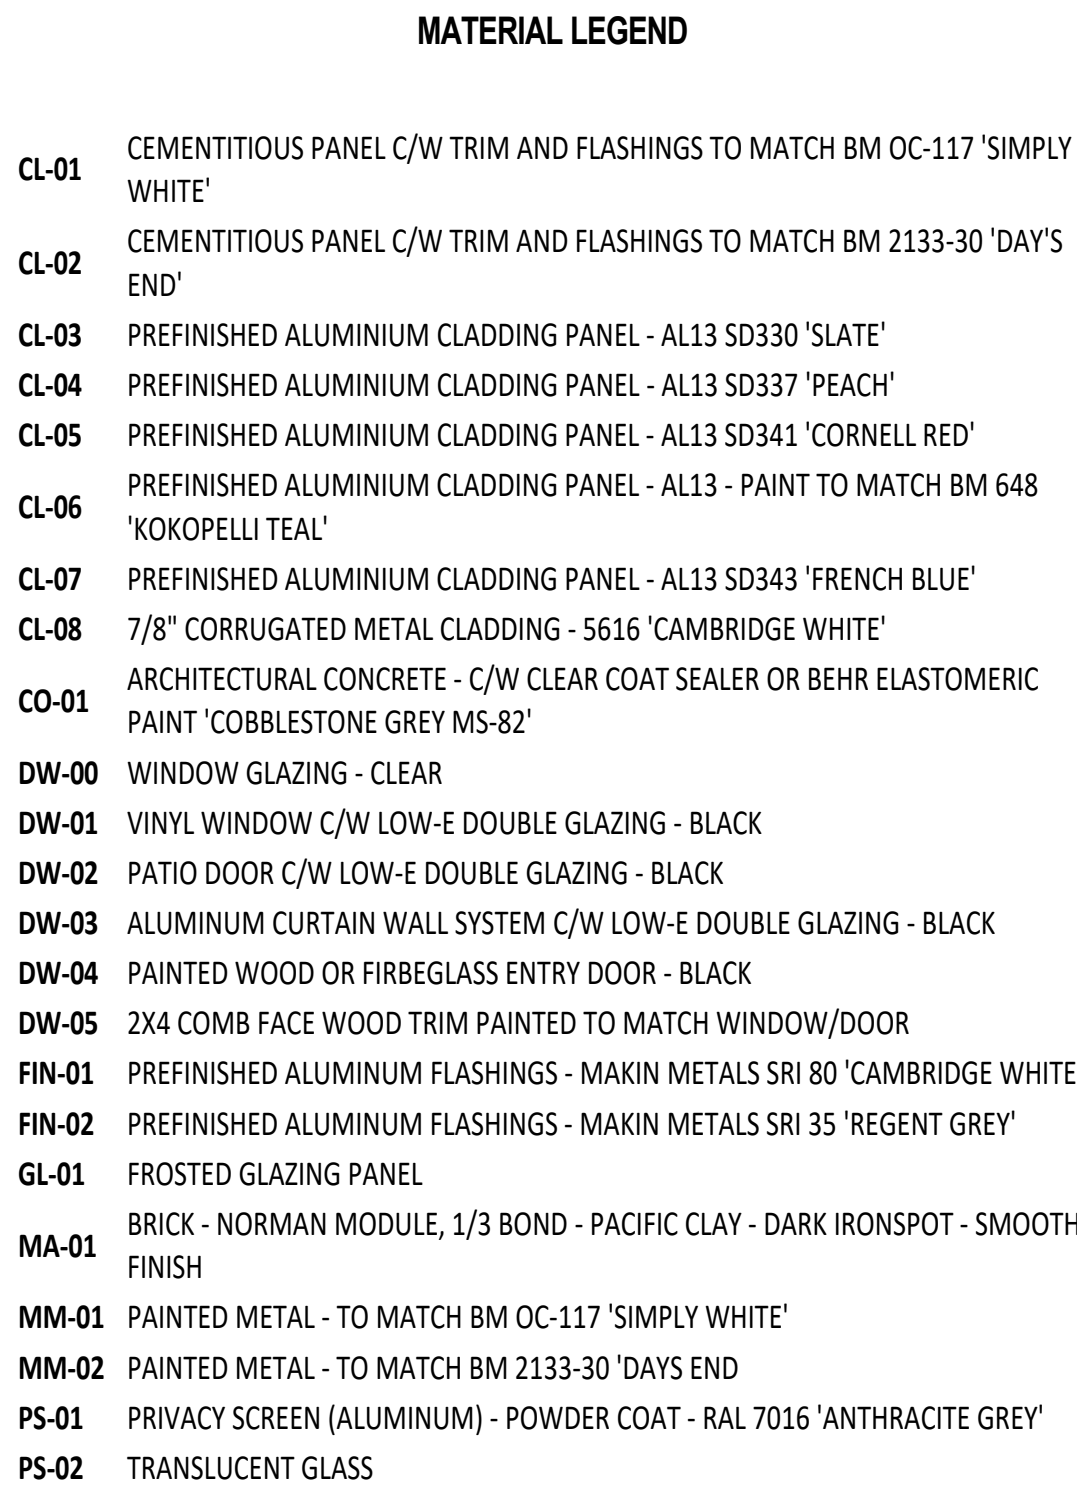

No.	Date	Revision Notes
A	2019/09/06	ISSUED FOR RZ/DP
No.	Date	Revision Notes

No.	Date	Revision Notes
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[illegible]

2 B2 - EAST ELEVATION (NORTH)
1/8" = 1'-0"

Project Title

ALBERT STREET

2025 Saint Johns Street
Port Moody, BC

MARCON

Client/Owner
MARCON ALBERT (GP) LTD.

5645 199 Street
Langley, BC V3A 1H9

Sheet Title

B2 - NORTH - ELEVATIONS

Drawn By	Author
Reviewed by	Approver

Project Number
1805

<i>Plot Date</i>	<i>Issue Date</i>
2019/08/30	2019/09/06

Scale Issue/Revision

1/8" = 1' 0" **A**

Sheet Number

[illegible]

MATERIAL LEGEND

- | | |
|--------|---|
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| TMP-01 | PAINTED FASCIA - TO MATCH BM OC-117 'SIMPLY WHITE' |
| TMP-02 | PAINTED FASCIA - TO MATCH BM 2133-30 'DAY'S END' |
| TMP-03 | PREFINISHED ALUMINUM GUTTER - GENTEK 'SLATE' 523 TO MATCH BM 2133-30 'DAY'S END' |
| TMP-04 | PREFINISHED ALUMINUM RWL 3 DIA. - GENTEK 'SLATE' 523 |



Client/Owner
MARCON ALBERT (GP) LTD.
5645 199 Street
Langley, BC V3A 1H9

Drawn By	Author
Reviewed by	Approver


Project Number
1805

<i>Plot Date</i>	<i>Issue Date</i>
2019/08/30	2019/09/06

Scale	Issue/Revision
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Sheet Number

A4.23

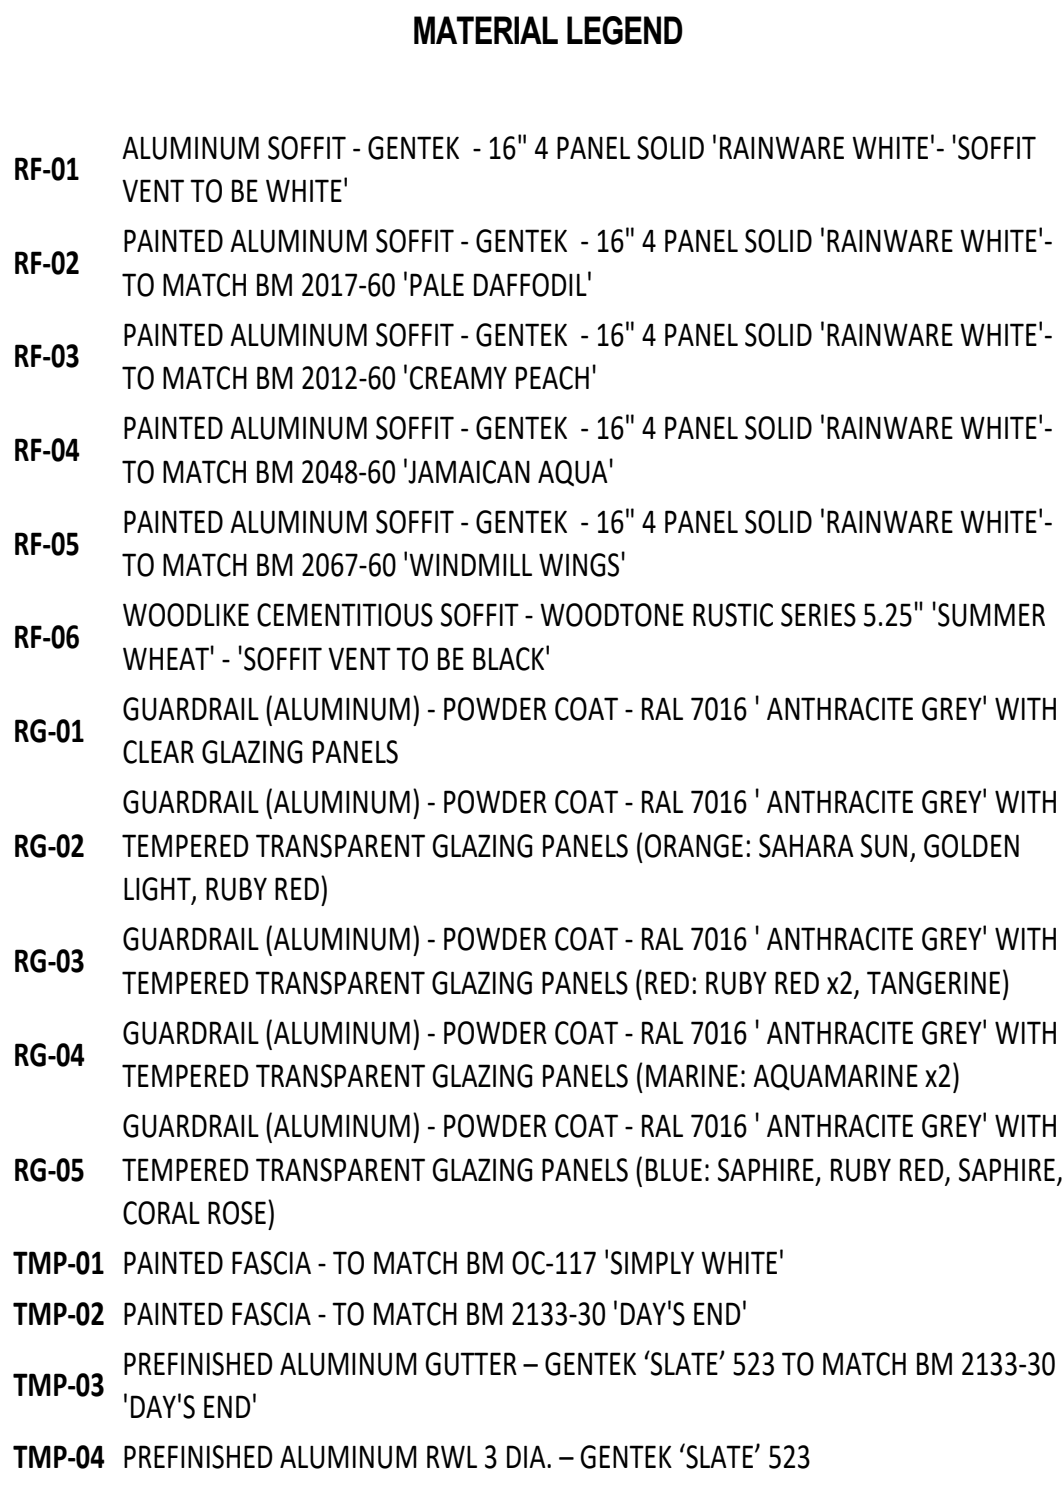

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No.	Date	Revision Notes
A	2019/09/06	ISSUED FOR RZ/DP
No.	Date	Revision Notes

ISSUED FOR RZ/DP - 06 SEPT 2019

Project Title

ALBERT STREET

2025 Saint Johns Street
Port Moody, BC

MARCON

Client/Owner
MARCON ALBERT (GP) LTD.

5645 199 Street
Langley, BC V3A 1H9

Sheet Title
B2 - SOUTH - ELEVATIONS

Drawn By	Author
Reviewed by	Approver

Project Number
1805

<i>Plot Date</i>	<i>Issue Date</i>
2019/08/30	2019/09/06

Scale Issue/Revision

1/8" = 1' 0" **A**

Sheet Number

A4.24

Albert Street Residential Development

Landscape Set: ISSUED FOR RZ/DP

September 6, 2019

LANDSCAPE DRAWING LIST

- L0.0 COVER SHEET
- L0.1 TREE MANAGEMENT PLAN
- L1.0 LAYOUT & MATERIALS - LEVEL 1
- L1.1 LAYOUT & MATERIALS - ROOF
- L1.2 ENLARGEMENT - COURTYARD LAYOUT
- L1.3 ENLARGEMENT - ROOF LAYOUT
- L2.0 GRADING PLAN - LEVEL 1
- L3.0 PLANT MATERIALS
- L5.0 DETAILS - SOFTSCAPE
- L5.1 DETAILS - HARDSCAPE
- L5.2 DETAILS - FENCES & WALLS
- L5.3 DETAILS - PLAY AREA
- L5.4 DETAILS - FURNISHINGS
- L5.5 DETAILS - PLANTERS

PROJECT TEAM

OWNER/DEVELOPER

MARCON ALBERT (GP) LTD.

5645-199th Street, Langley, BC V3A 1H9

604.530.5646

ARCHITECT

SHIFT ARCHITECTURE INC.

200-100 W 3 Street, North Vancouver, BC V7P 3J6

604.988.7501

GENERAL NOTES

ALL LANDSCAPE ARCHITECTURAL DRAWINGS IN THIS PACKAGE SHALL BE READ IN CONJUNCTION WITH ALL OTHER DRAWINGS, DETAILS, SPECIFICATIONS, AND/OR OTHER CORRESPONDANCE THAT MAY BE ISSUED DURING THE COURSE OF THE CONTRACT.

IF A DISCREPANCY OCCURS BETWEEN THE DRAWINGS AND THE SPECIFICATIONS OR ANY OTHER DOCUMENT ASSOCIATED WITH THE PROJECT, THE CONFLICT SHALL BE REPORTED IN WRITING TO THE LANDSCAPE ARCHITECT TO OBTAIN CLARIFICATION AND APPROVAL BEFORE PROCEEDING WITH WORKS.

ALL EXISTING INFORMATION IS BASED ON AVAILABLE RECORDS AND SHALL NOT BE CONSTRUED TO BE COMPLETE OR ACCURATE. THE CONTRACTOR SHALL VISIT THE SITE TO VERIFY THE TRUE EXISTING CONDITIONS. ANY UNCLEAR ISSUES SHALL BE CLARIFIED WITH THE CONSULTANT TEAM. NO CLAIM SHALL BE ALLOWED FOR EXTRAS WHICH MAY ARISE THROUGH NEGLECT OF THIS ADVICE.

THE CONTRACTOR IS RESPONSIBLE FOR DETERMINING THE EXISTENCE, LOCATION, AND ELEVATION OF ALL UTILITIES AND CONCEALED STRUCTURES, AND IS RESPONSIBLE FOR NOTIFYING THE APPROPRIATE COMPANY, DEPARTMENT OR PERSON(S) OF ITS INTENTION TO CARRY OUT ITS OPERATIONS.

ALL PLANTING SHALL BE IN ACCORDANCE WITH THE CANADIAN LANDSCAPE STANDARD, LATEST EDITION.

LAYOUT OF HARDSCAPE, SITE FURNITURE, SOIL, PLANTING, AND ALL OTHER MATERIALS IS TO BE STAKED OUT FOR APPROVAL BY THE LANDSCAPE ARCHITECT PRIOR TO INSTALLATION.

FINAL SELECTION AND LAYOUT OF ALL SITE WORKS (INCLUDING, BUT NOT LIMITED TO: HARDSCAPES, SITE FURNITURE, GROWING MEDIA, TREES, AND PLANTING) IS TO BE APPROVED BY THE CITY OF VANCOUVER PRIOR TO MATERIAL ACQUISITION AND STAKED OUT AND APPROVED BY THE LANDSCAPE ARCHITECT PRIOR TO INSTALLATION.

FINAL SIDEWALK LOCATION AND BOULEVARD DESIGN TO BE DETERMINED BY THE GENERAL MANAGER OF ENGINEERING SERVICES PRIOR TO BUILDING OCCUPANCY.

THIS PLAN IS NOT FOR CONSTRUCTION OF ANY PUBLIC PROPERTY FACILITIES. PRIOR TO THE START OF ANY CONSTRUCTION ON PUBLIC PROPERTY A LANDSCAPE PLAN MUST BE SUBMITTED TO ENGINEERING SERVICES AND BE ISSUED AS "FOR CONSTRUCTION". EIGHT WEEKS NOTICE IS REQUESTED. NO WORK ON PUBLIC PROPERTY MAY BEGIN UNTIL PLANS RECEIVE "FOR CONSTRUCTION" APPROPVAL AND RELATED PERMITS ARE ISSUED. PLEASE CONTACT KEVIN CAVELL AT 604-873-7773 FOR DETAILS.



ALBERT STREET

2025 Saint Johns Street
Port Moody, BC

Scale:	1:250
Drawn:	KD
Reviewed:	DS
Project No.	06-653

COVER SHEET
& DRAWING LIST

L0.0

CONNECT LANDSCAPE ARCHITECTURE INC.
DOES NOT GUARANTEE THE EXISTENCE,
LOCATION, AND ELEVATION OF UTILITIES AND /
OR CONCEALED STRUCTURES AT THE PROJECT
SITE.


THE CONTRACTOR IS RESPONSIBLE FOR
DETERMINING THE EXISTENCE, LOCATION, AND
ELEVATION OF ALL UTILITIES AND / OR
CONCEALED STRUCTURES, AND IS
RESPONSIBLE FOR NOTIFYING THE
APPROPRIATE COMPANY, DEPARTMENT OR
PERSON(S) OF ITS INTENTION TO CARRY OUT ITS
OPERATIONS.

TREE RETENTION / REMOVAL LEGEND



EXISTING TREE TO BE REMOVED
TO BE CONFIRMED PER ARBORIST ON-SITE
WITH CITY OF PORT MOODY ARBORIST PRIOR
TO REMOVAL



EXISTING TREE TO BE RETAINED

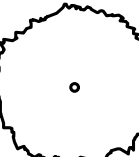

TREE PROTECTION FENCING
TREE PROTECTION FENCING TO BE INSTALLED
PER CITY OF PORT MOODY STANDARDS AND
INSPECTED BY ARBORIST PRIOR TO
CONSTRUCTION ACTIVITY

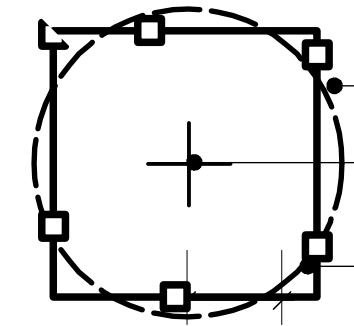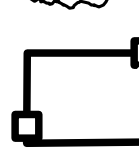

PROTECTION BARRIER

EXISTING TREE CENTERED
WITHIN TREE PROTECTION

DISTANCE 6X FROM TRUNK
OR PLACE AT CURB EDGE/
SIDEWALK EDGE

EXISTING TREE CENTERED
WITH TREE PROTECTION


PROTECTION BARRIER
6X FROM TRUNK

50 x 100 WOOD POSTS SET 31
DEEP INTO FINISHED GRADE
SPACING OF POSTS 2m, USE
ADDITIONAL POSTS AS REQU

PLASTIC MESH SECURED
TO WOOD FRAME

TREE PROTECTION NOTES

1. REFER TO CERTIFIED ARBORIST REPORT TO VERIFY INFORMATION REGARDING EXISTING TREES TO BE RETAINED/REMOVED AND TREE RETENTION VIABILITY.
2. INSTALL TREE PROTECTION BARRIER AROUND ALL TREES TO BE PRESERVED TO CITY OF PORT MOODY STANDARDS AND SPECIFICATIONS, SUBJECT TO REVIEW BY PROJECT ARBORIST.
3. INFORM ARBORIST WHEN ALL TREE BARRIERS HAVE BEEN INSTALLED. ARBORIST TO PROVIDE WRITTEN INSPECTION AND APPROVAL OF ALL BARRIERS AND SUBMIT INSPECTION REPORT TO CITY OF VANCOUVER STAFF FOR REVIEW AND APPROVAL PRIOR TO DEMOLITION / MOBILIZATION CONSTRUCTION ACTIVITY.
4. DO NOT REMOVE OR RELOCATE ANY TREE, EXCEPT AS INDICATED ON PLANS.
5. DO NOT ALTER EXISTING GRADE OR STORE MATERIALS UNDER THE DRIP LINE OR WITHIN TREE PROTECTION ZONE. EXCAVATION WITHIN DRIP LINES OF TREES ONLY WHERE INDICATED ON PLANS.
6. ALL RETAINED TREES ARE TO BE PRUNED AND PROTECTED BY CITY OF PORT MOODY TREE PROTECTION BY-LAWS.
7. FOR CARE AND PROTECTION OF EXPOSED ROOTS AND ROOT CURTAIN SYSTEM CONSULT PROJECT ARBORIST.
8. TUNNEL UNDER AND AROUND ALL SIGNIFICANT ROOTS BY HAND DIGGING. DO NOT CUT MAIN LATERAL ROOTS.
9. TRENCHING FOR UTILITY CONNECTIONS TO BE COORDINATED WITH ENGINEERING DEPARTMENT TO ENSURE SAFE ROOT ZONES OF RETAINED TREES. METHODS OF TREE PROTECTION FOR STREET TREES TO BE APPROVED BY CITY OF VANCOUVER.
10. CONTRACTOR TO CONTACT PROJECT ARBORIST, CITY ARBORIST AND/OR LANDSCAPE ARCHITECT 48 HOURS PRIOR TO ANY CONSTRUCTION WORK AFFECTING THE DRIP LINE OF TREES.
11. THIS PLAN IS NOT FOR CONSTRUCTION OF ANY PUBLIC PROPERTY FACILITIES. PRIOR TO THE START OF ANY CONSTRUCTION ON PUBLIC PROPERTY A LANDSCAPE PLAN MUST BE SUBMITTED TO ENGINEERING SERVICES AND BE ISSUED AS "FOR CONSTRUCTION".
12. ALL SIDEWALKS BETWEEN THE CURB AND PROPERTY LINE ARE TO BE RECONSTRUCTED FULLY AT THE APPLICANT'S EXPENSE.

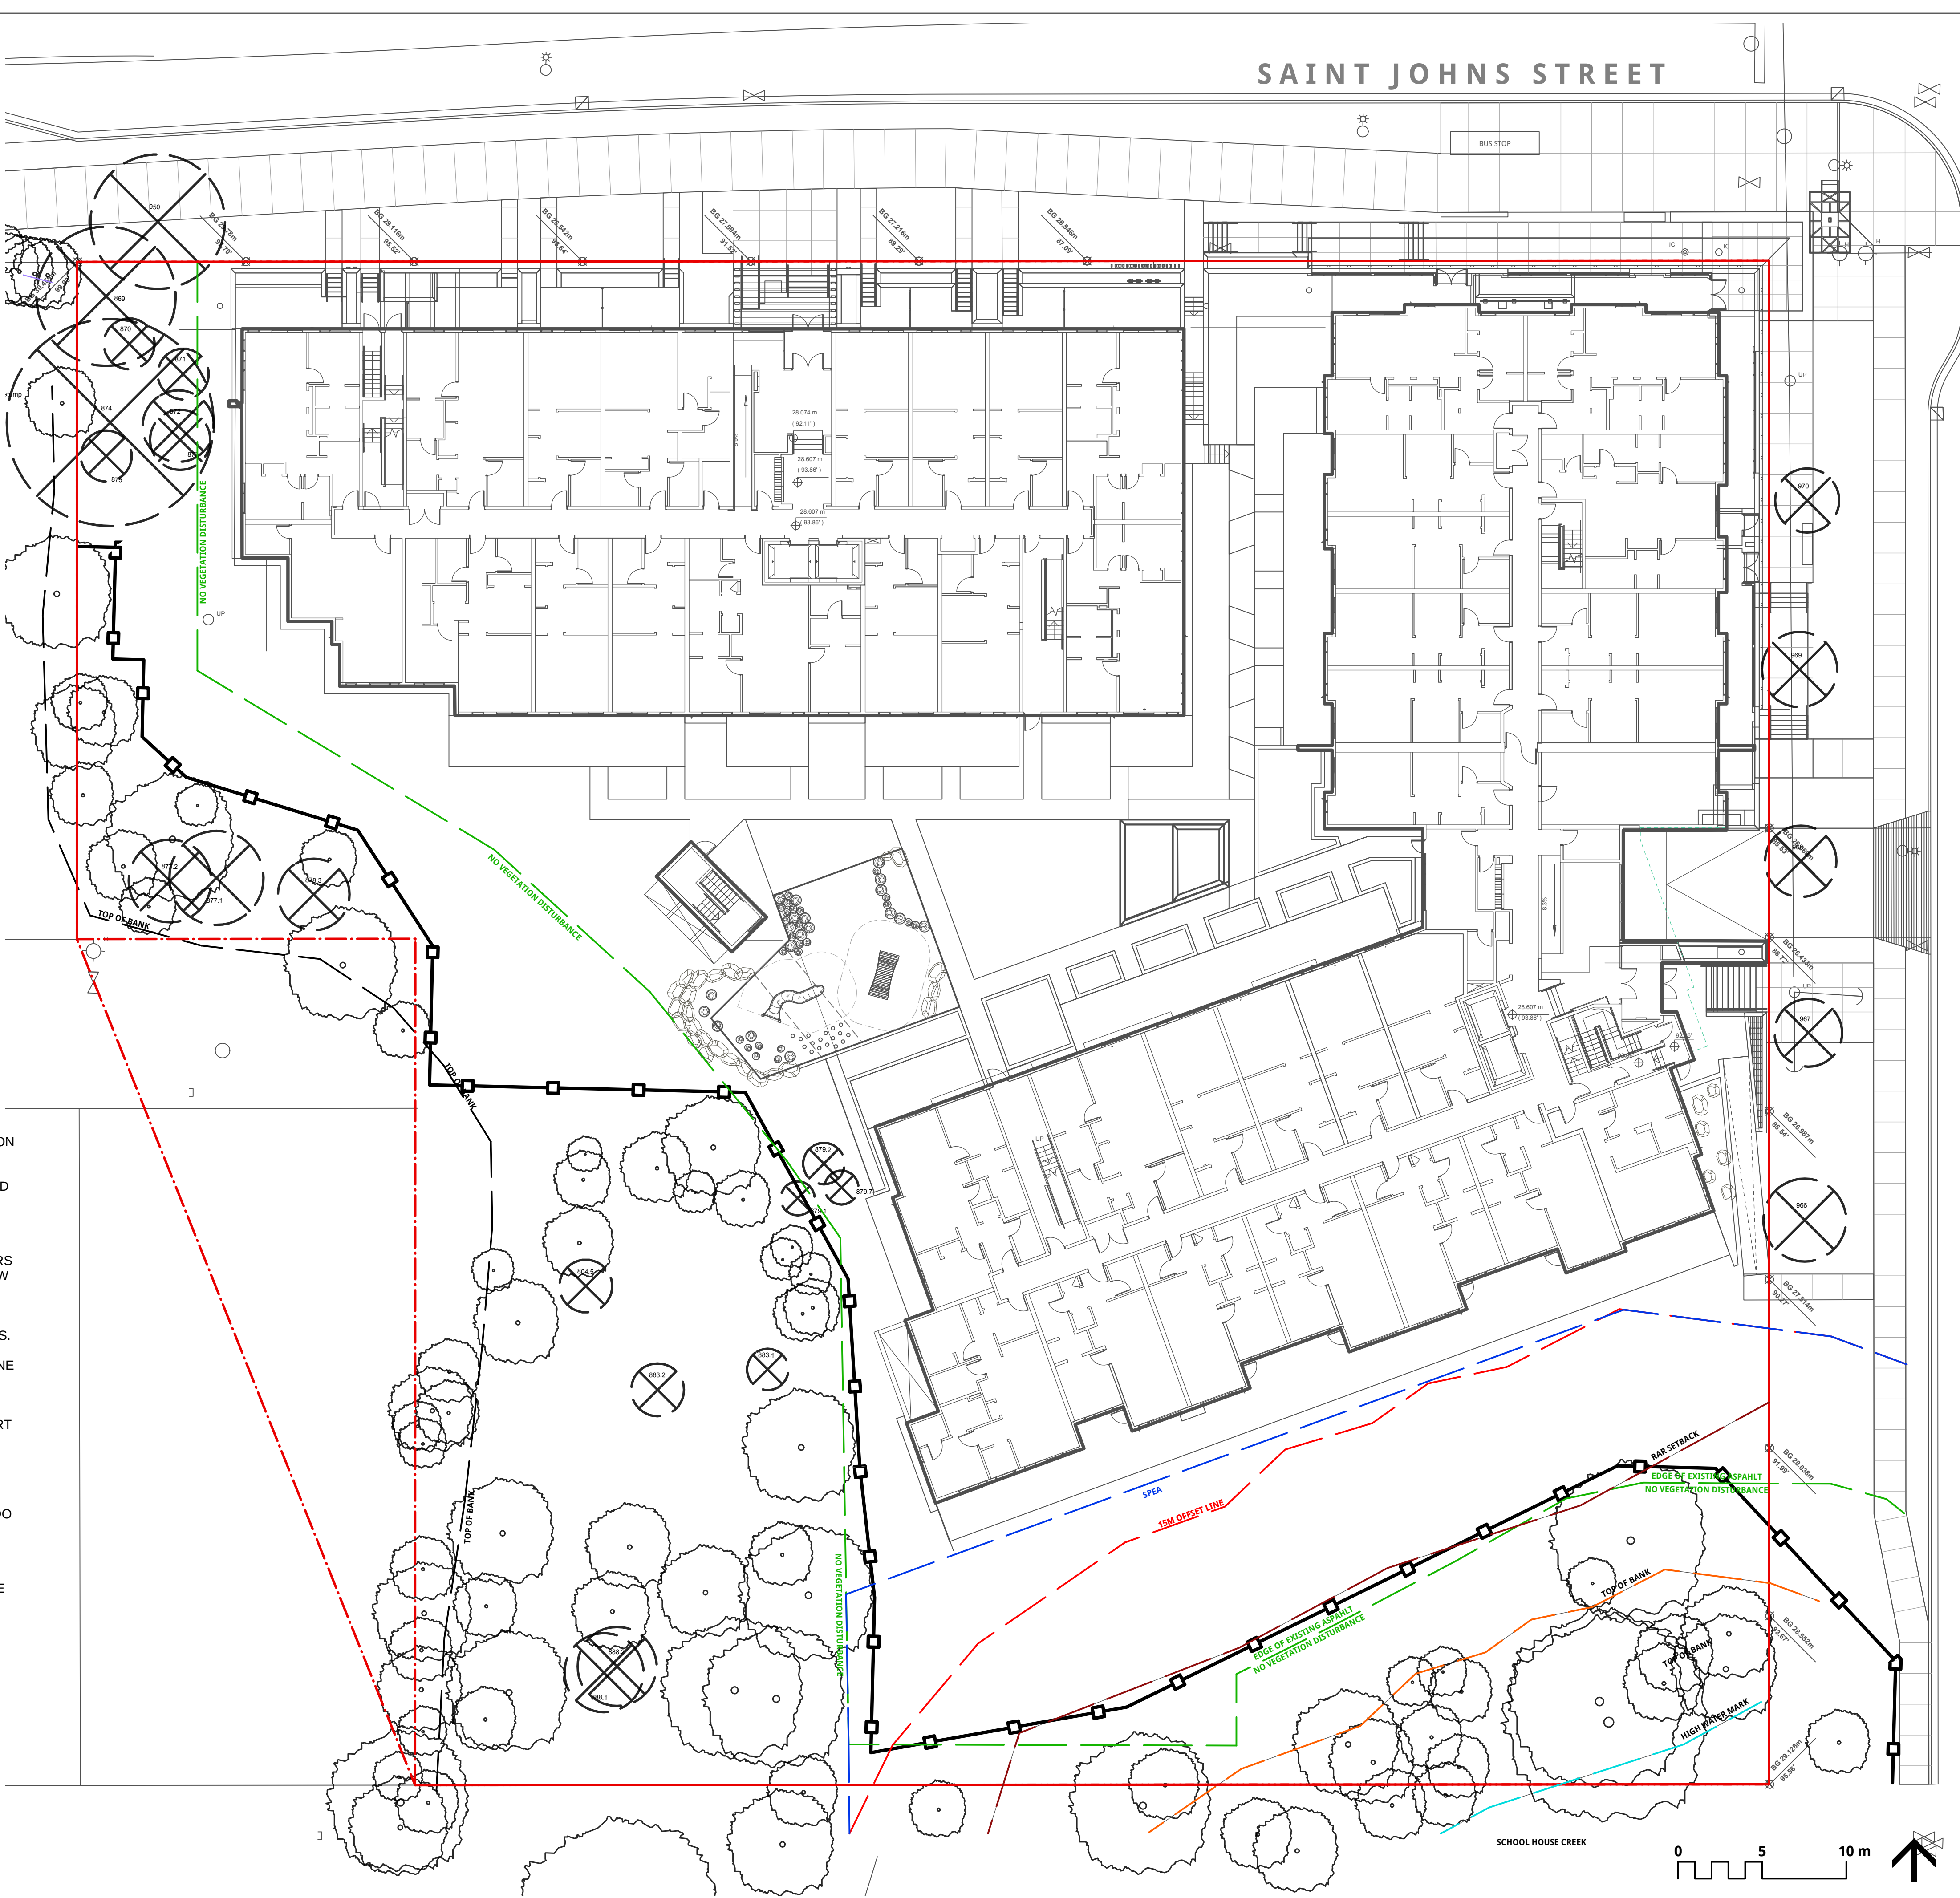

ALBERT STREET

ALBERT STREET

2025 Saint Johns Street
Port Moody, BC

Scale:	1:200
Drawn:	KD
Reviewed:	DS
Project No.	06-653

TREE MANAGEMENT

CONNECT LANDSCAPE ARCHITECTURE INC.
DOES NOT GUARANTEE THE EXISTENCE,
LOCATION, AND ELEVATION OF UTILITIES AND /
OR CONCEALED STRUCTURES AT THE PROJECT
SITE.

THE CONTRACTOR IS RESPONSIBLE FOR
DETERMINING THE EXISTENCE, LOCATION, AND
ELEVATION OF ALL UTILITIES AND / OR
CONCEALED STRUCTURES, AND IS
RESPONSIBLE FOR NOTIFYING THE
APPROPRIATE COMPANY, DEPARTMENT OR
PERSON(S) OF ITS INTENTION TO CARRY OUT ITS
OPERATIONS.

1	ISSUED FOR RZ/DP	19-09-06
REVISIONS		

ALBERT STREET

2025 Saint Johns Street
Port Moody, BC


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Drawn:	KD
Reviewed:	DS
Project No.	06-653




LAYOUT & MATERIALS LEVEL 1

L1.0

LAYOUT & MATERIAL LEGEND



CIP CONCRETE WALKWAY PER PLANS & DETAILS	
FEATURE UNIT PAVING PER PLANS & DETAILS	
PERMEABLE UNIT PAVING PER PLANS & DETAILS	
PRIVATE PATIO SLAB PAVING PER PLANS & DETAILS	
WOOD DECK PER PLANS & DETAILS	
GRAVEL EDGING 450MM TYP. PER PLANS & DETAILS	
CIP CONCRETE RETAINING WALL PER ARCHITECTURE	
TREE PROTECTION FENCING PER CITY STANDARDS	
METAL GUARD PER ARCHITECTURE	
WOOD GUARD PER PLANS & DETAILS	
6' WOOD PRIVACY SCREEN PER PLANS & DETAILS	
EXISTING PLANTING TO REMAIN UNDISTURBED	
PROPOSED PLANTING PER PLANS & DETAILS	
PROPOSED LAWN PER PLANS & DETAILS	
CUSTOM WOOD BENCH PER PLANS & DETAILS	
BIKE RACK PER PLANS & DETAILS	
OUTDOOR FURNITURE LOCATION PER PLAN PER MARCON/INTERIORS	
EXISTING TREE TO REMAIN PER ARBORIST REPORT	
PROPOSED TREE PER PLANS & DETAILS	
PLAY AREA SURFACING PER PLANS & DETAILS	
NATURE PLAY ELEMENTS PER PLANS & DETAILS	
BOULDER RETAINING PER PLANS & DETAILS	

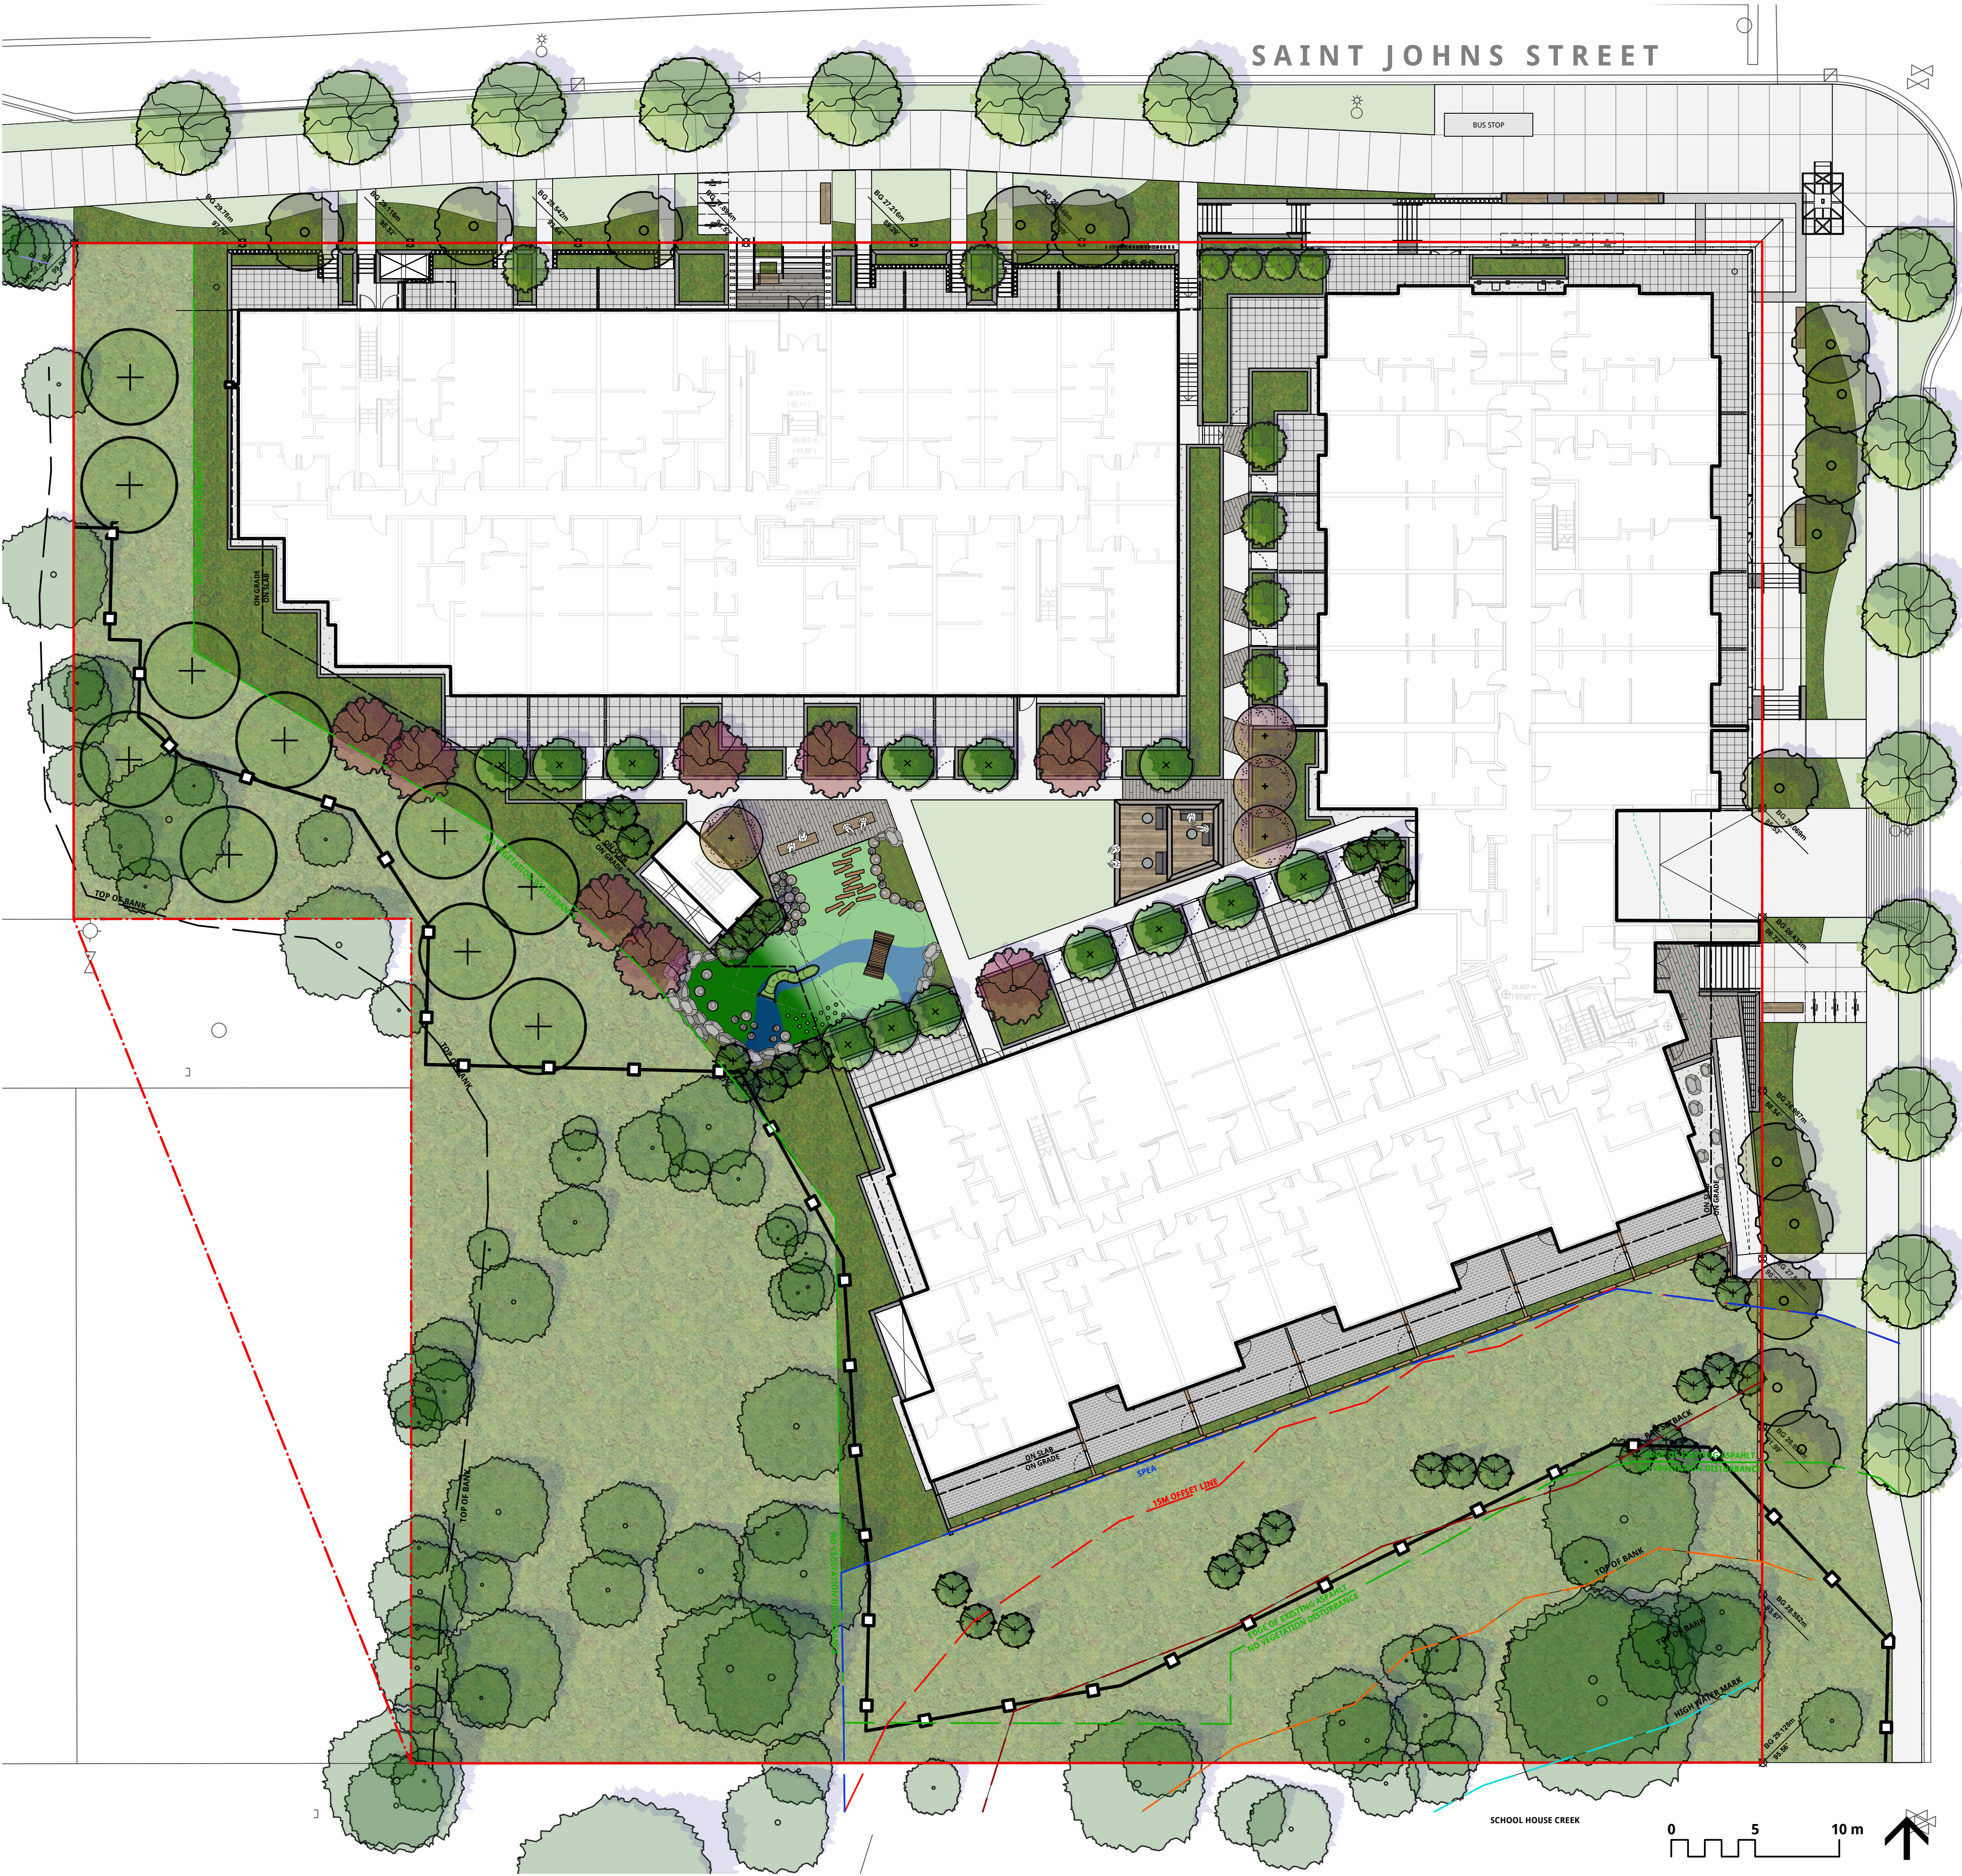

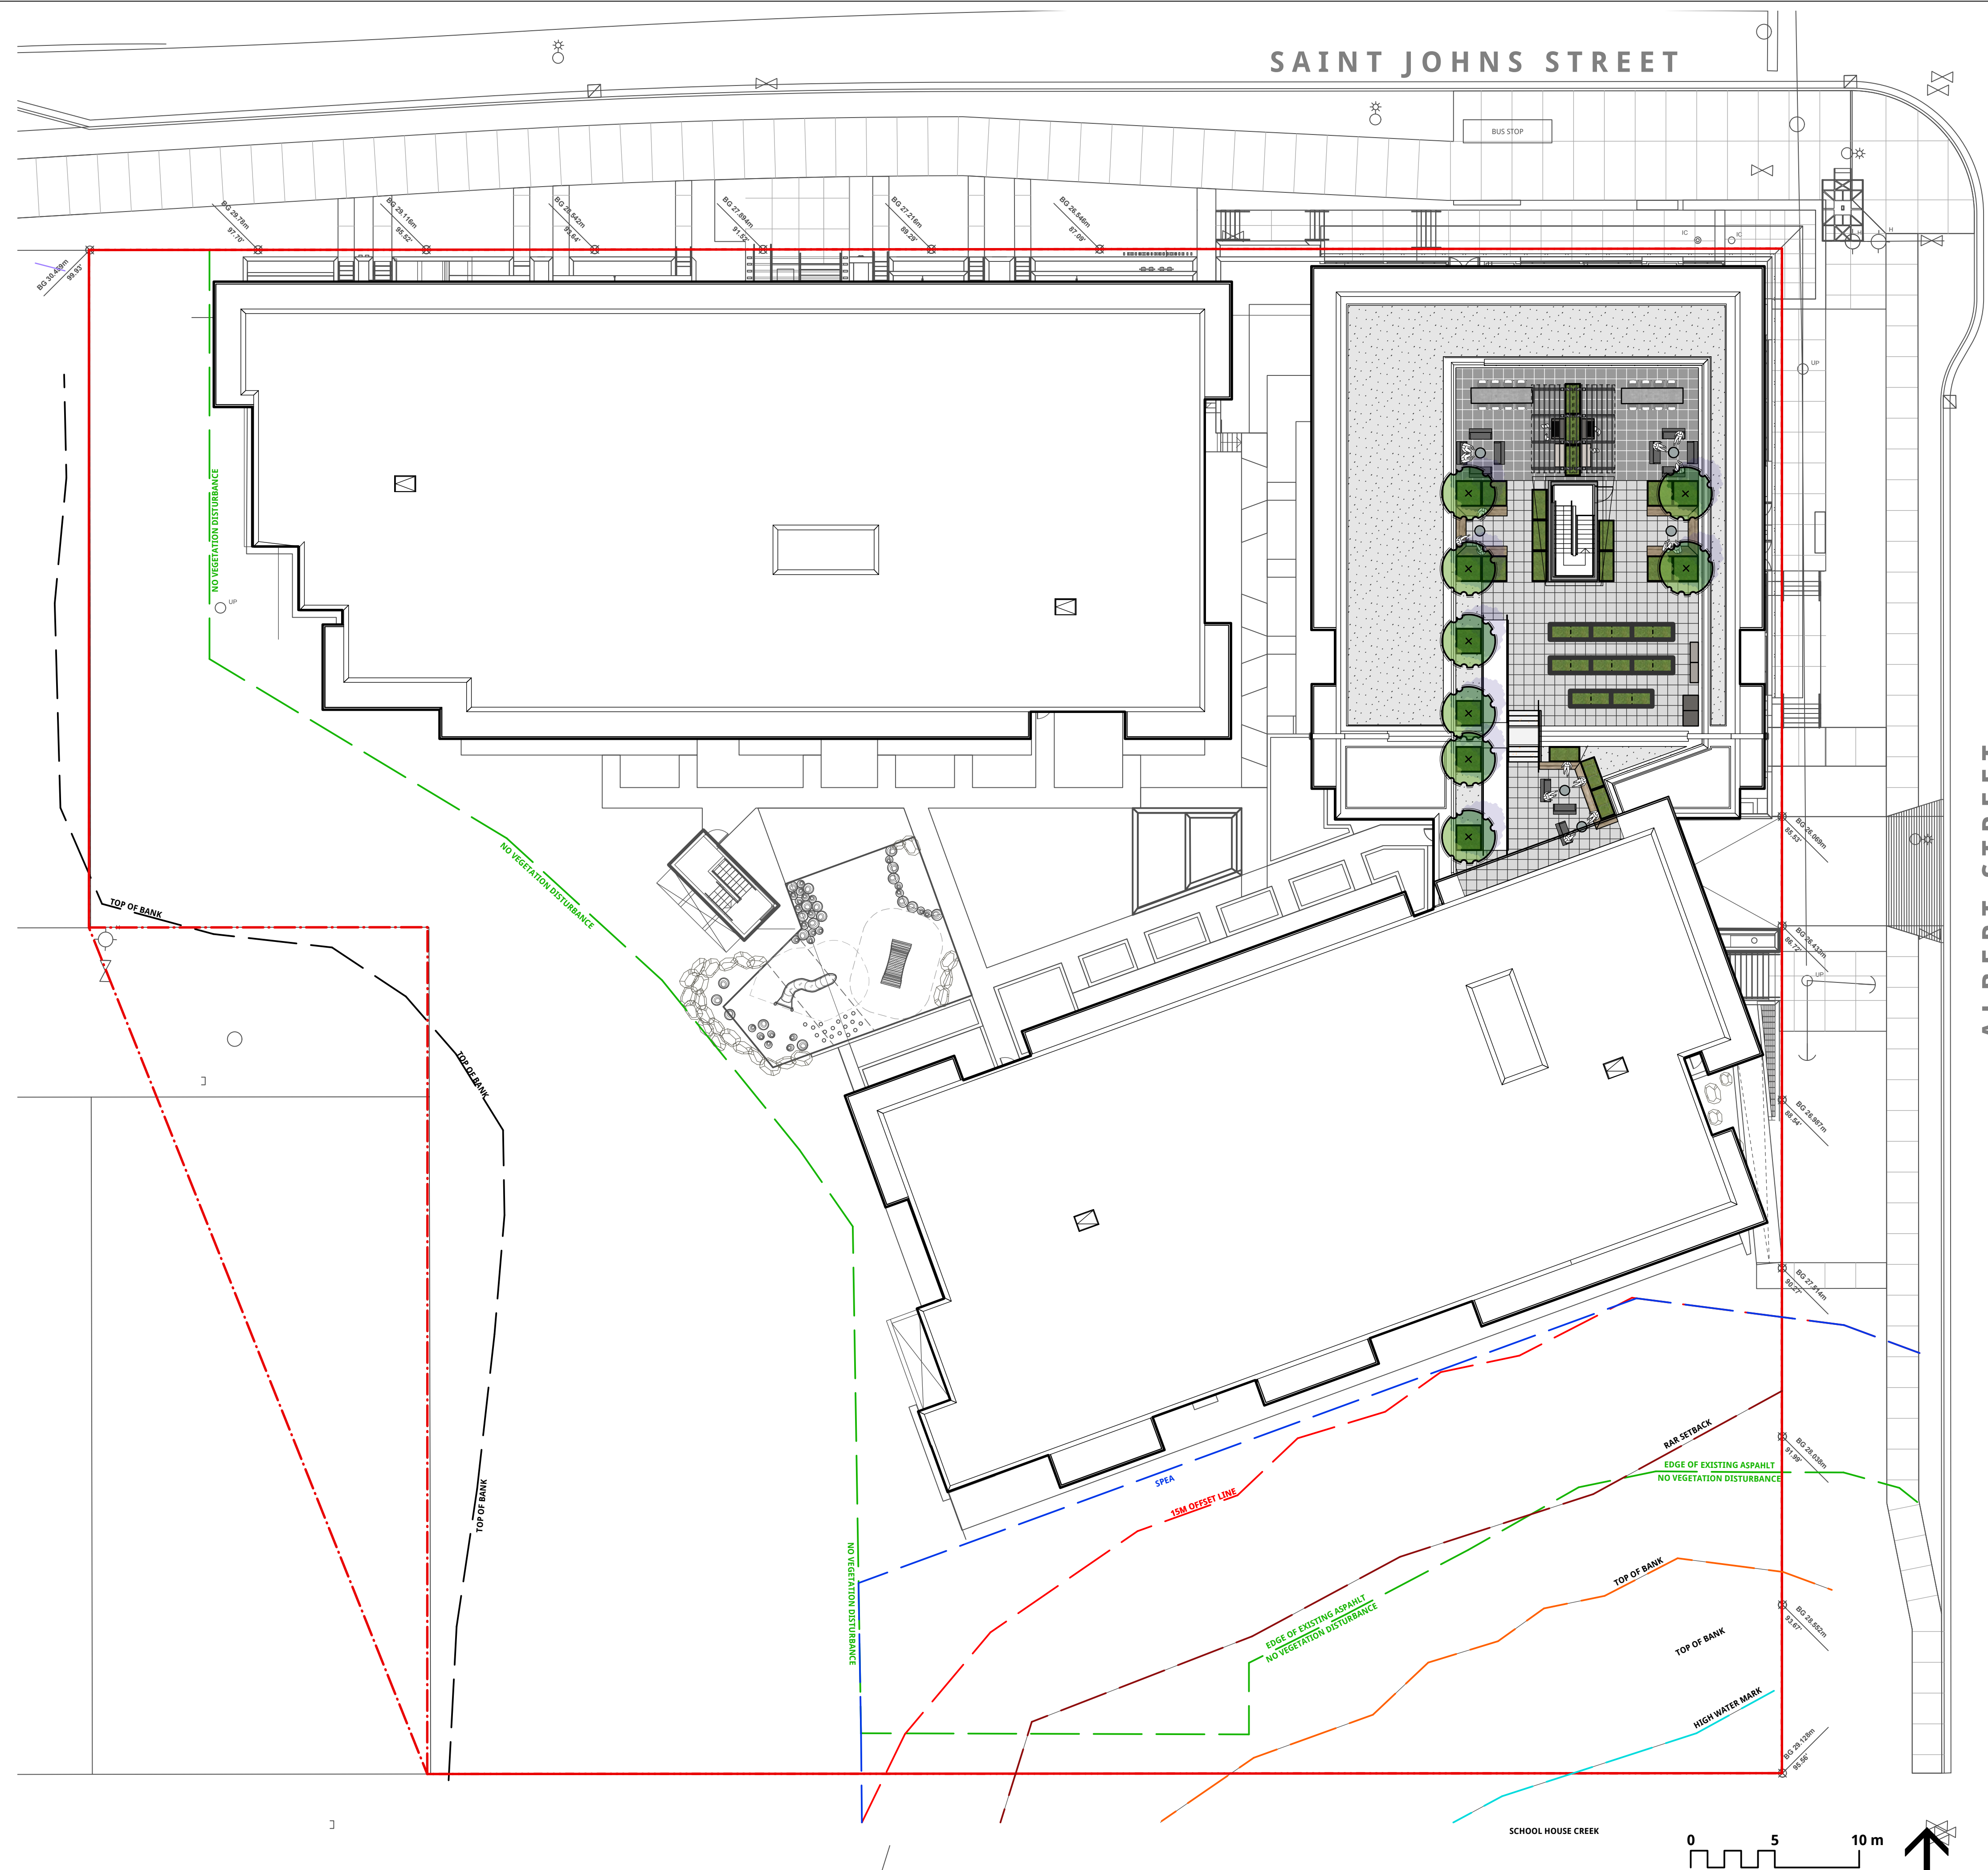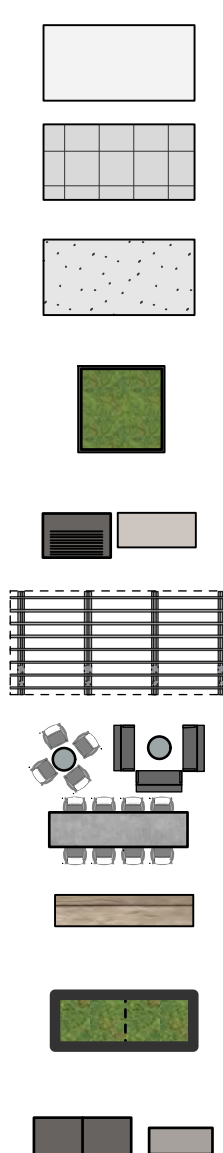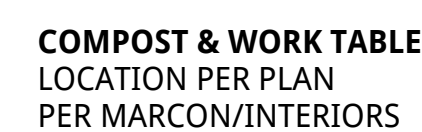

Item 4.1
Attachment 5

CONNECT LANDSCAPE ARCHITECTURE INC.
DOES NOT GUARANTEE THE EXISTENCE,
LOCATION, AND ELEVATION OF UTILITIES AND / OR
CONCEALED STRUCTURES, AND IS
RESPONSIBLE FOR NOTIFYING THE
APPROPRIATE COMPANY, DEPARTMENT OR
PERSON(S) OF ITS INTENTION TO CARRY OUT ITS
OPERATIONS.

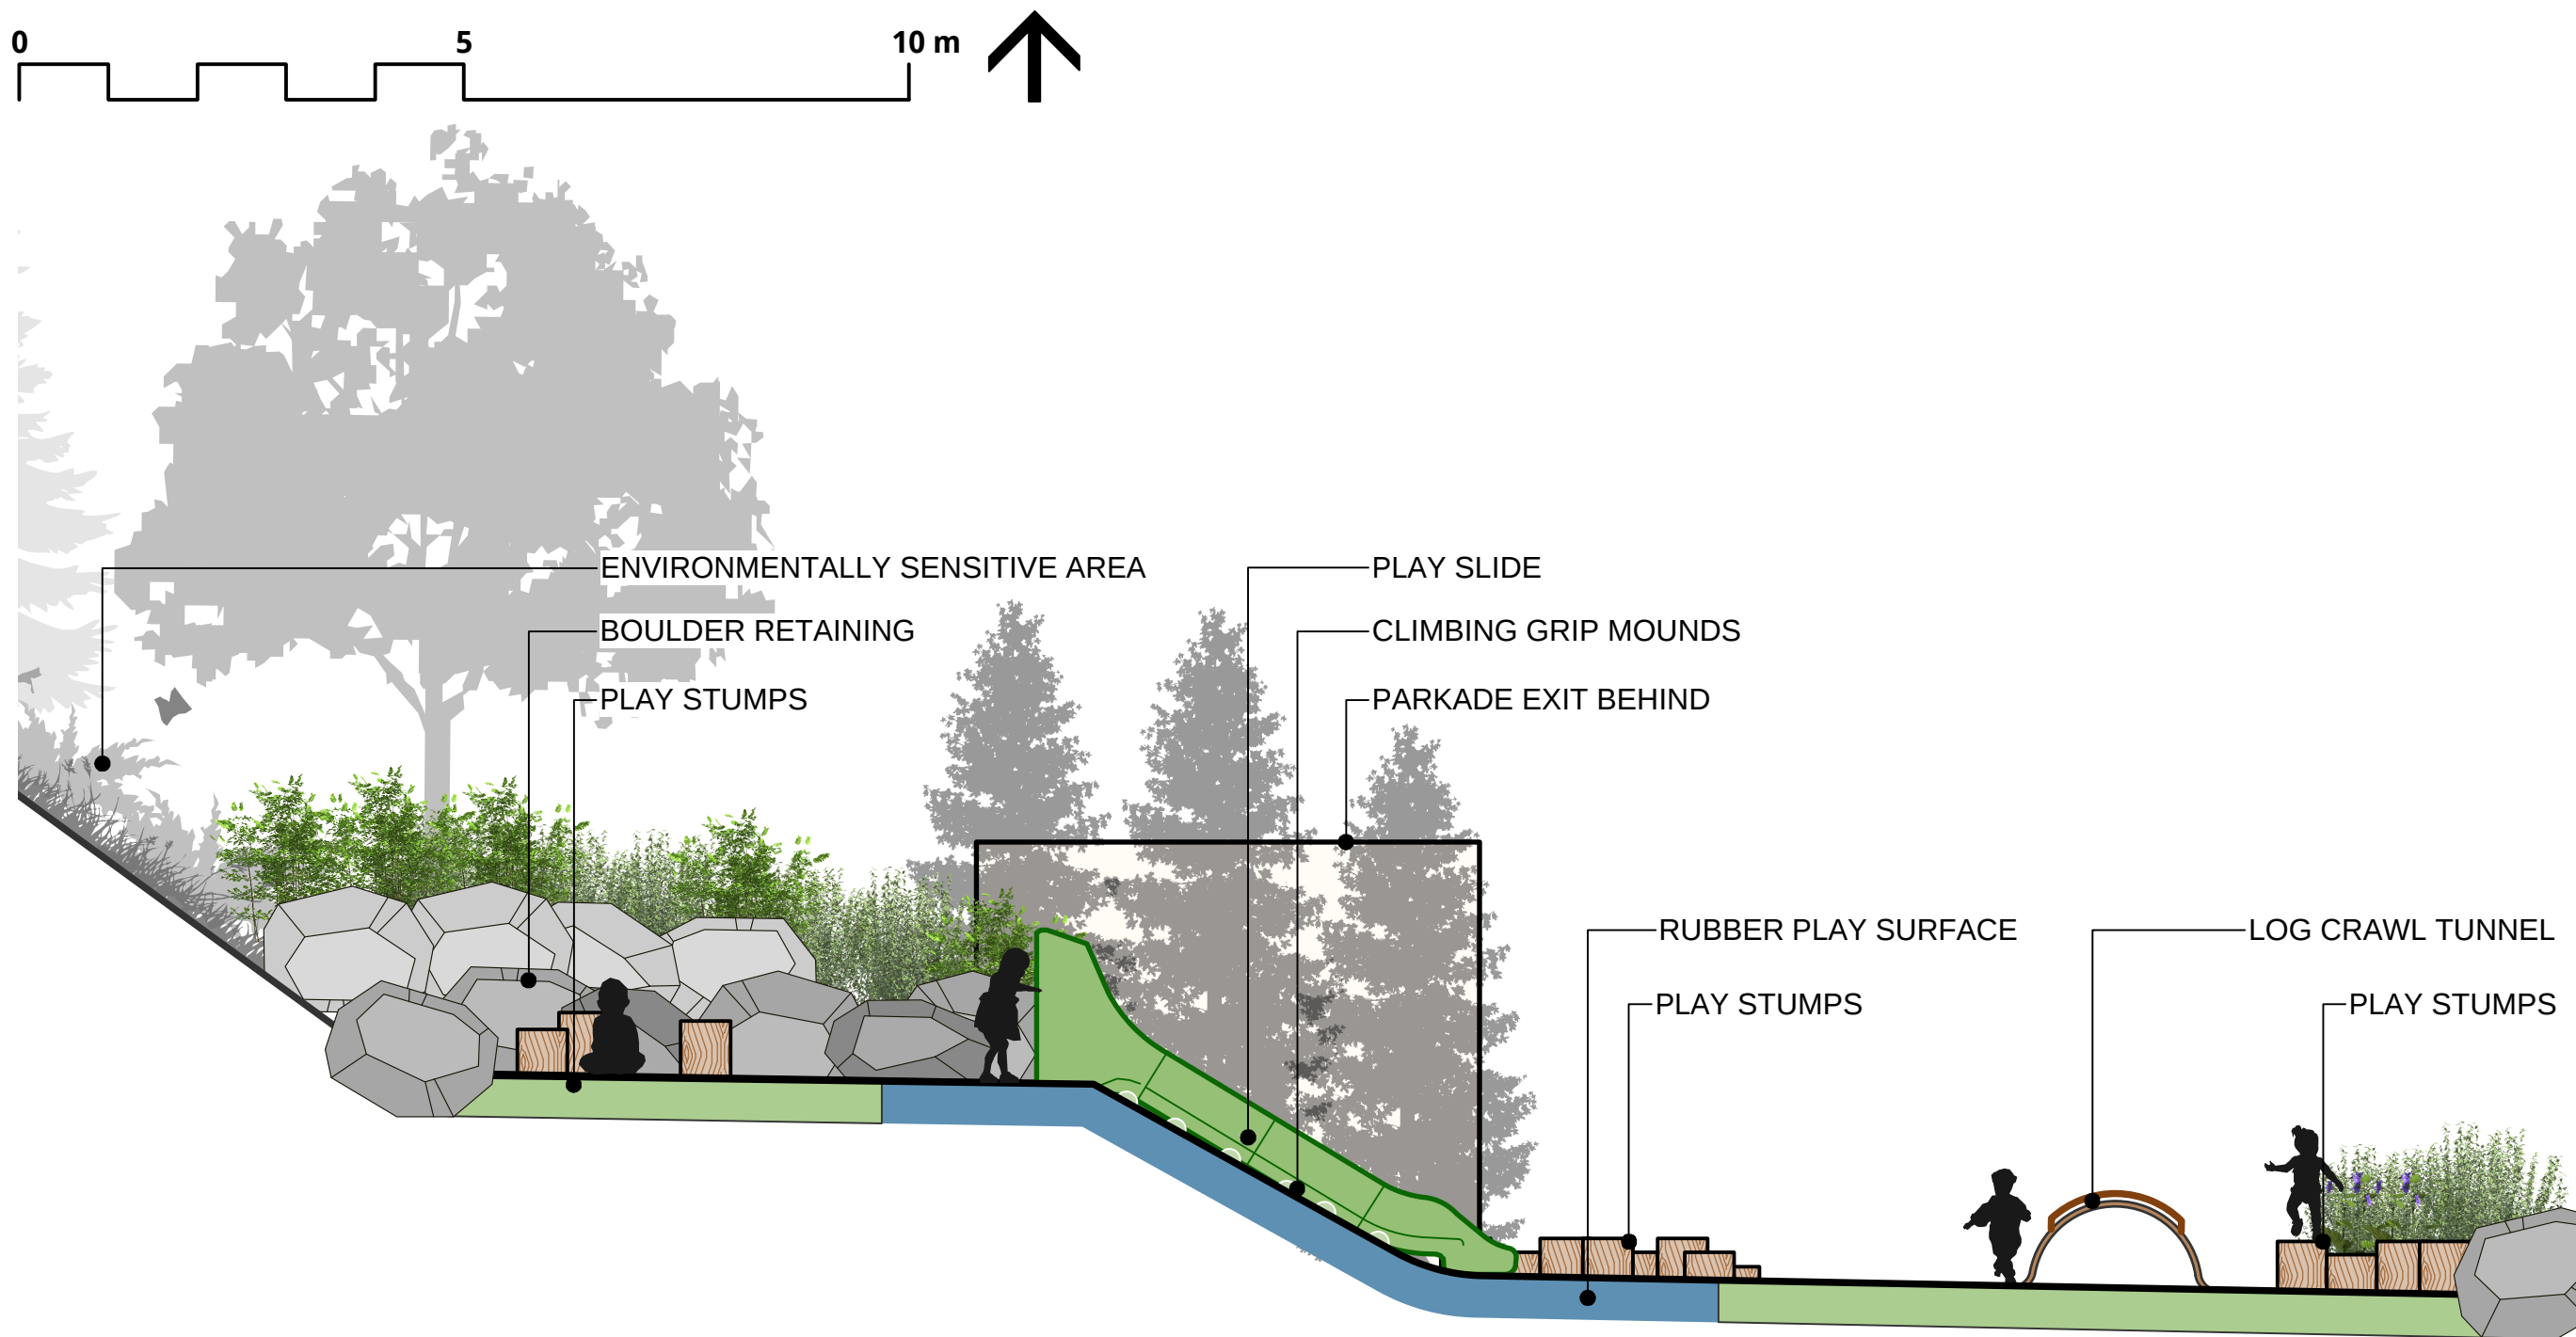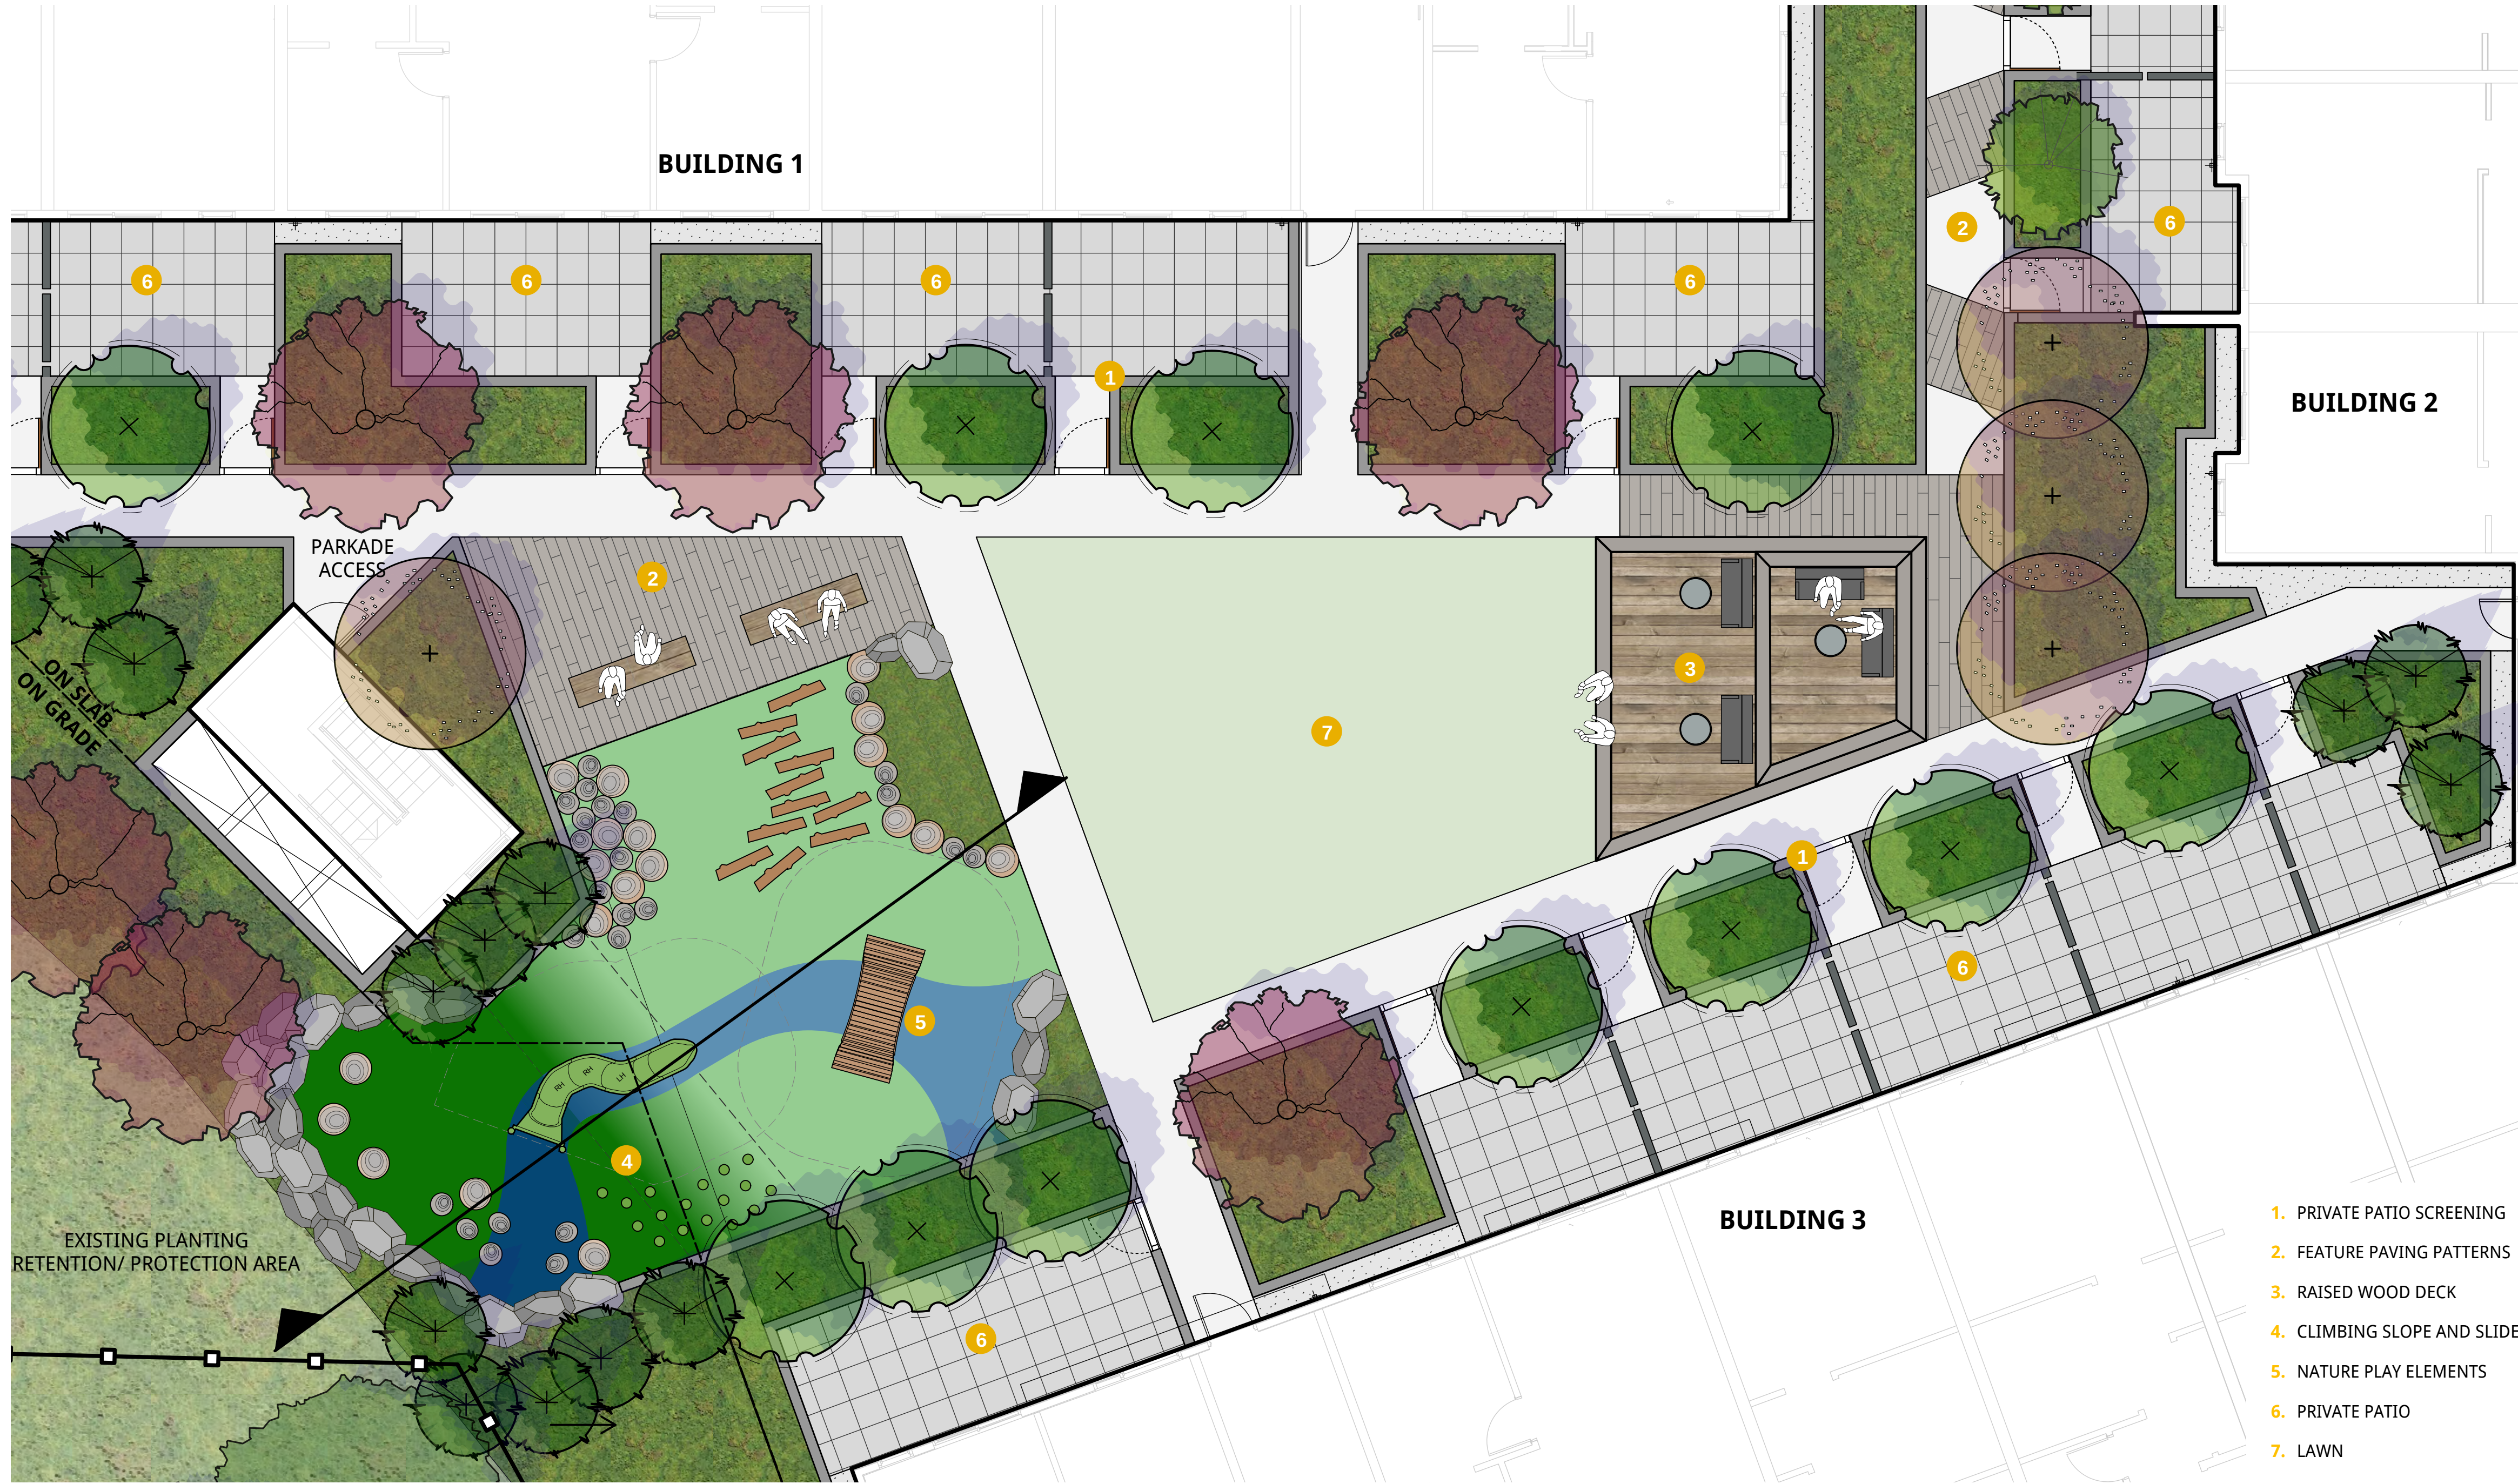

ALBERT STREET

2025 Saint Johns Street
Port Moody, BC

Scale:	1:75
Drawn:	KD
Reviewed:	DS
Project No.	06-653

ENLARGEMENT COURTYARD LAYOUT

L1.2

CONNECT LANDSCAPE ARCHITECTURE INC.
DOES NOT GUARANTEE THE EXISTENCE,
LOCATION, AND ELEVATION OF UTILITIES AND /
OR CONCEALED STRUCTURES AT THE PROJECT
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PERSON(S) OF ITS INTENTION TO CARRY OUT ITS
OPERATIONS.

1 ISSUED FOR RZ/DP 19-09-06

REVISIONS

ALBERT STREET


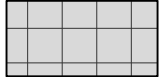



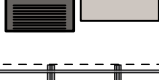



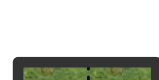
2025 Saint Johns Street
Port Moody, BC

Scale:	1:75
Drawn:	KD
Reviewed:	DS
Project No.	06-653

ENLARGEMENT
ROOF LAYOUT


L1.3

LAYOUT & MATERIAL LEGEND

CIP CONCRETE PER PLANS & DETAILS	
PATIO SLAB PAVING PER PLANS & DETAILS	
GRAVEL SURFACE PER PLANS & DETAILS	
PROPOSED PLANTING IN METAL PLANTER PER PLANS & DETAILS	
BBQ & COUNTER PER PLANS & DETAILS	
CUSTOM METAL TRELLIS PER PLANS & DETAILS	
OUTDOOR FURNITURE LOCATION PER PLAN PER MARCON/INTERIORS	
CUSTOM WOOD BENCH PER PLANS & DETAILS	
TIMBER GARDEN PLANTER PER PLANS & DETAILS	
COMPOST & WORK TABLE LOCATION PER PLAN PER MARCON/INTERIORS	




- 1. DINING AREA
- 2. OUTDOOR KITCHEN
- 3. LOUNGE AREA
- 4. ROOFTOP GARDEN

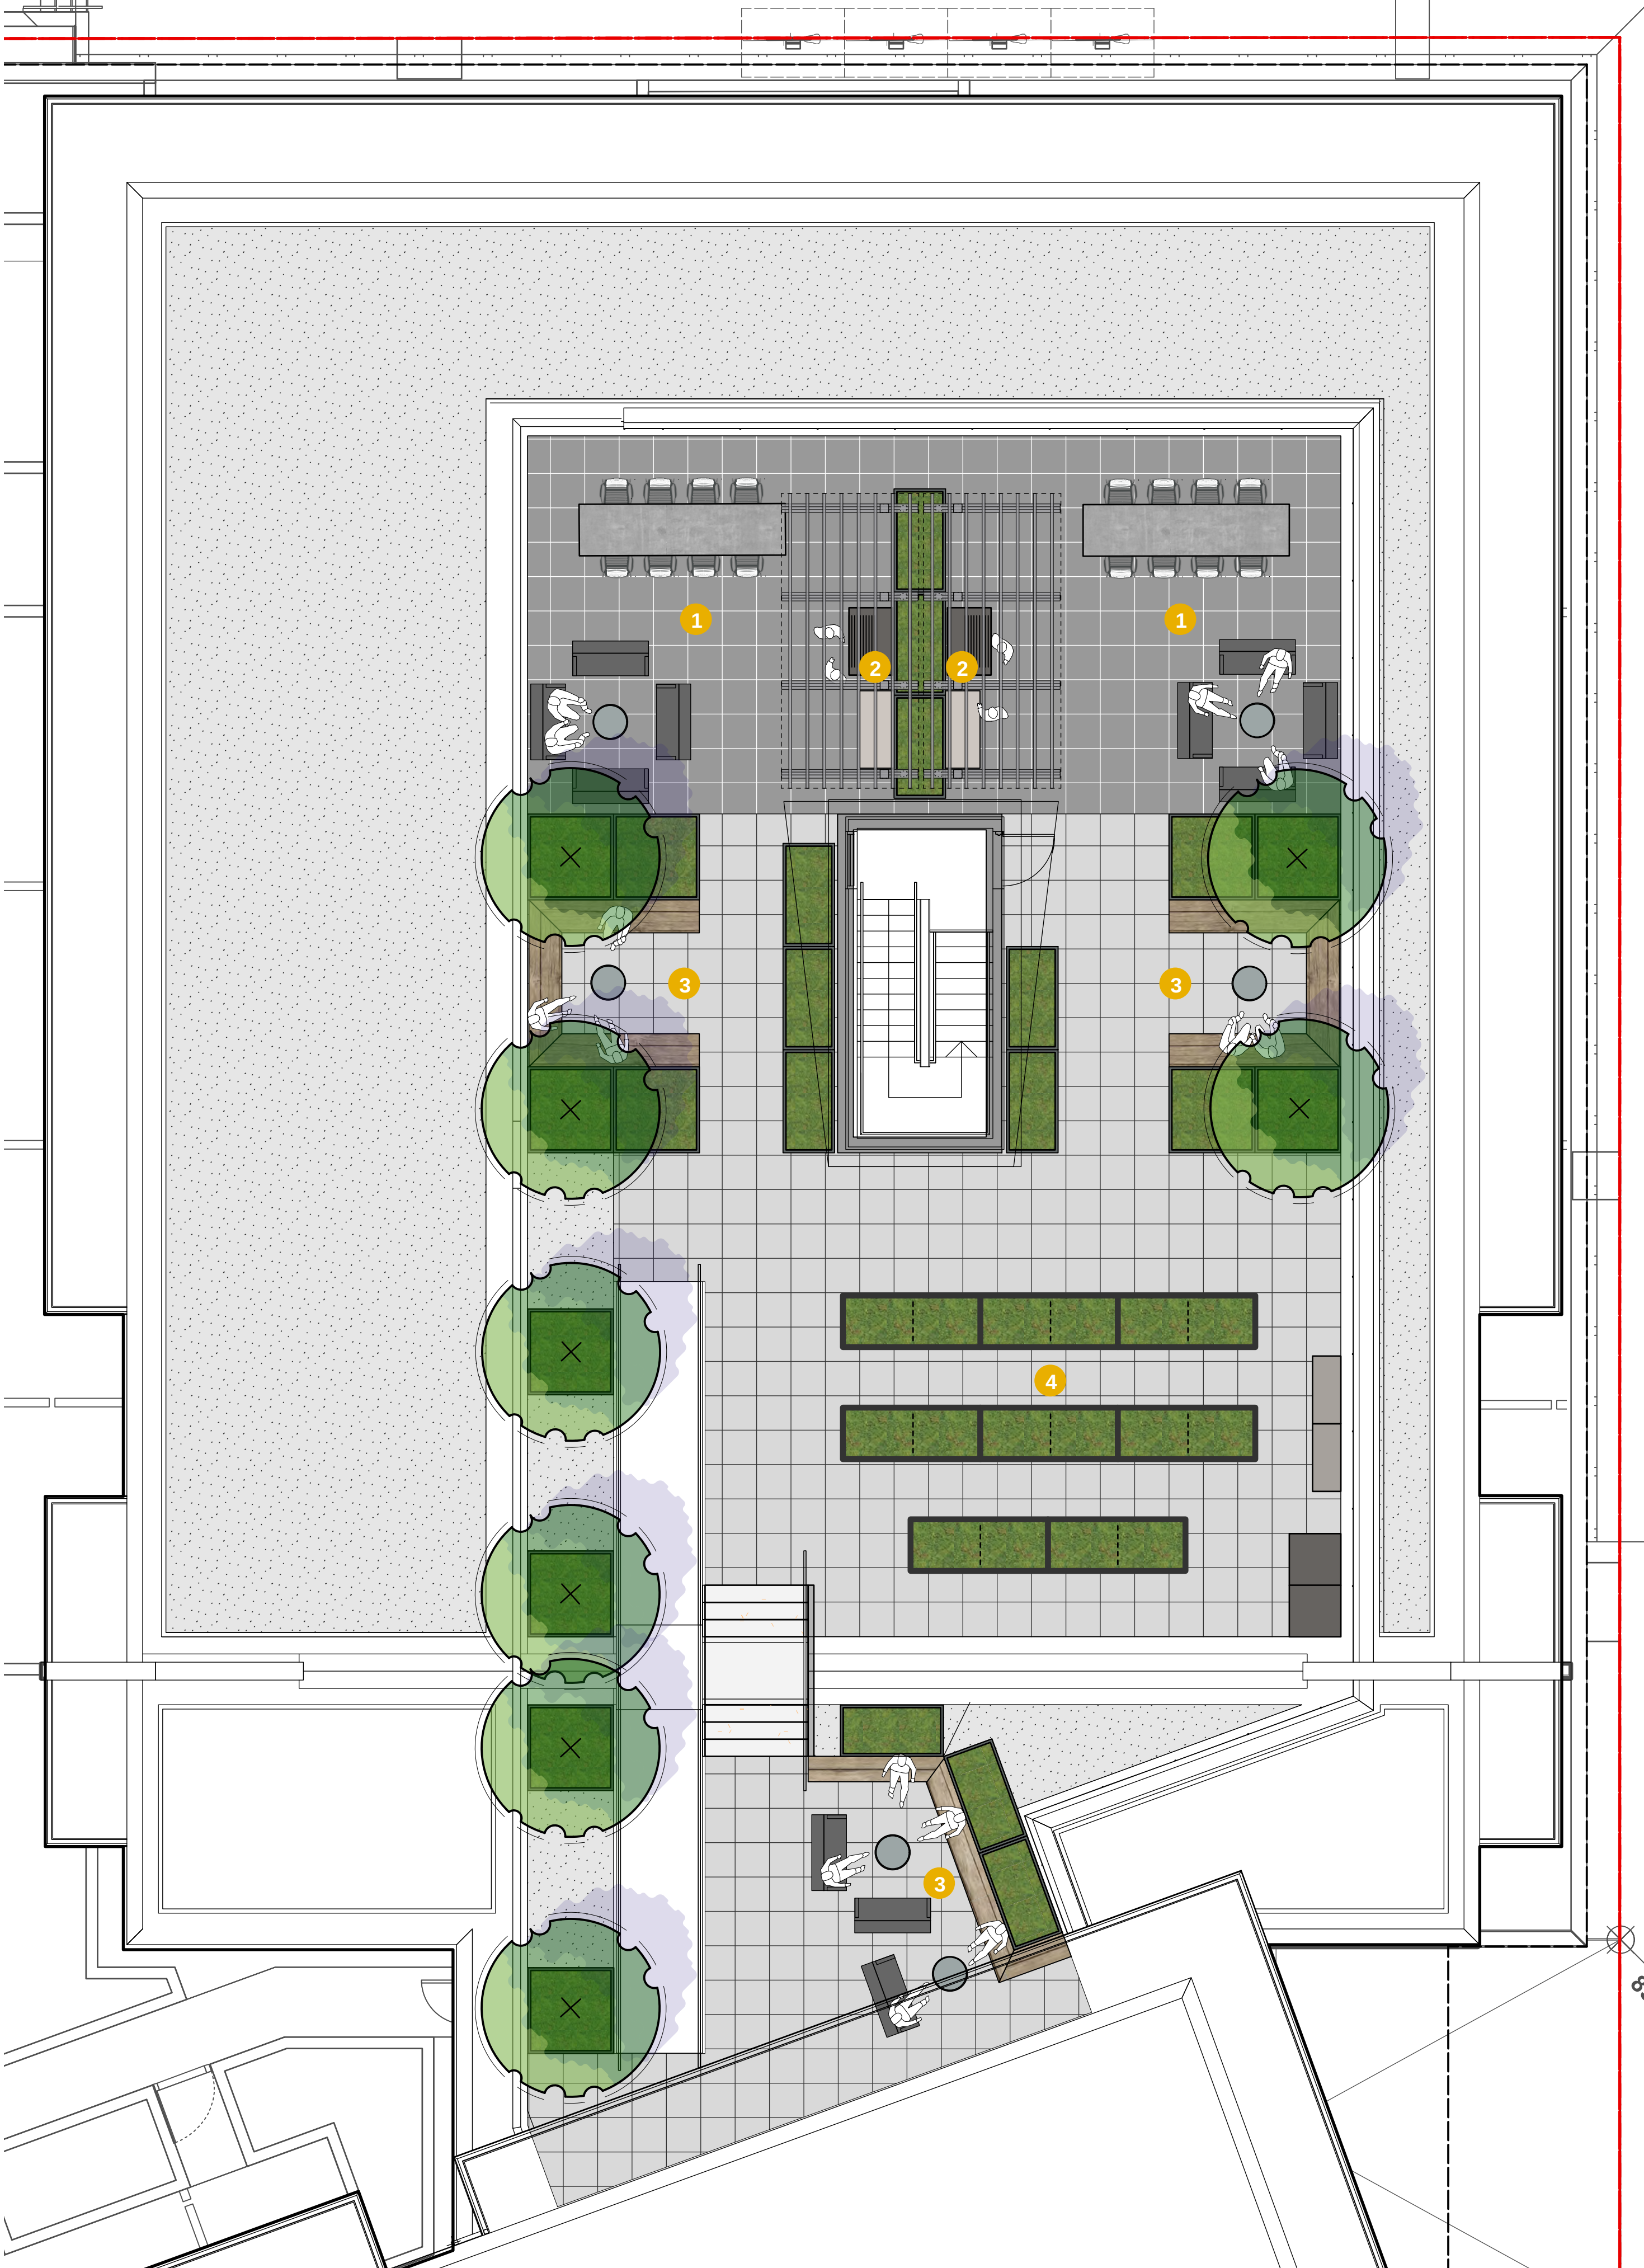

0 5 10 m



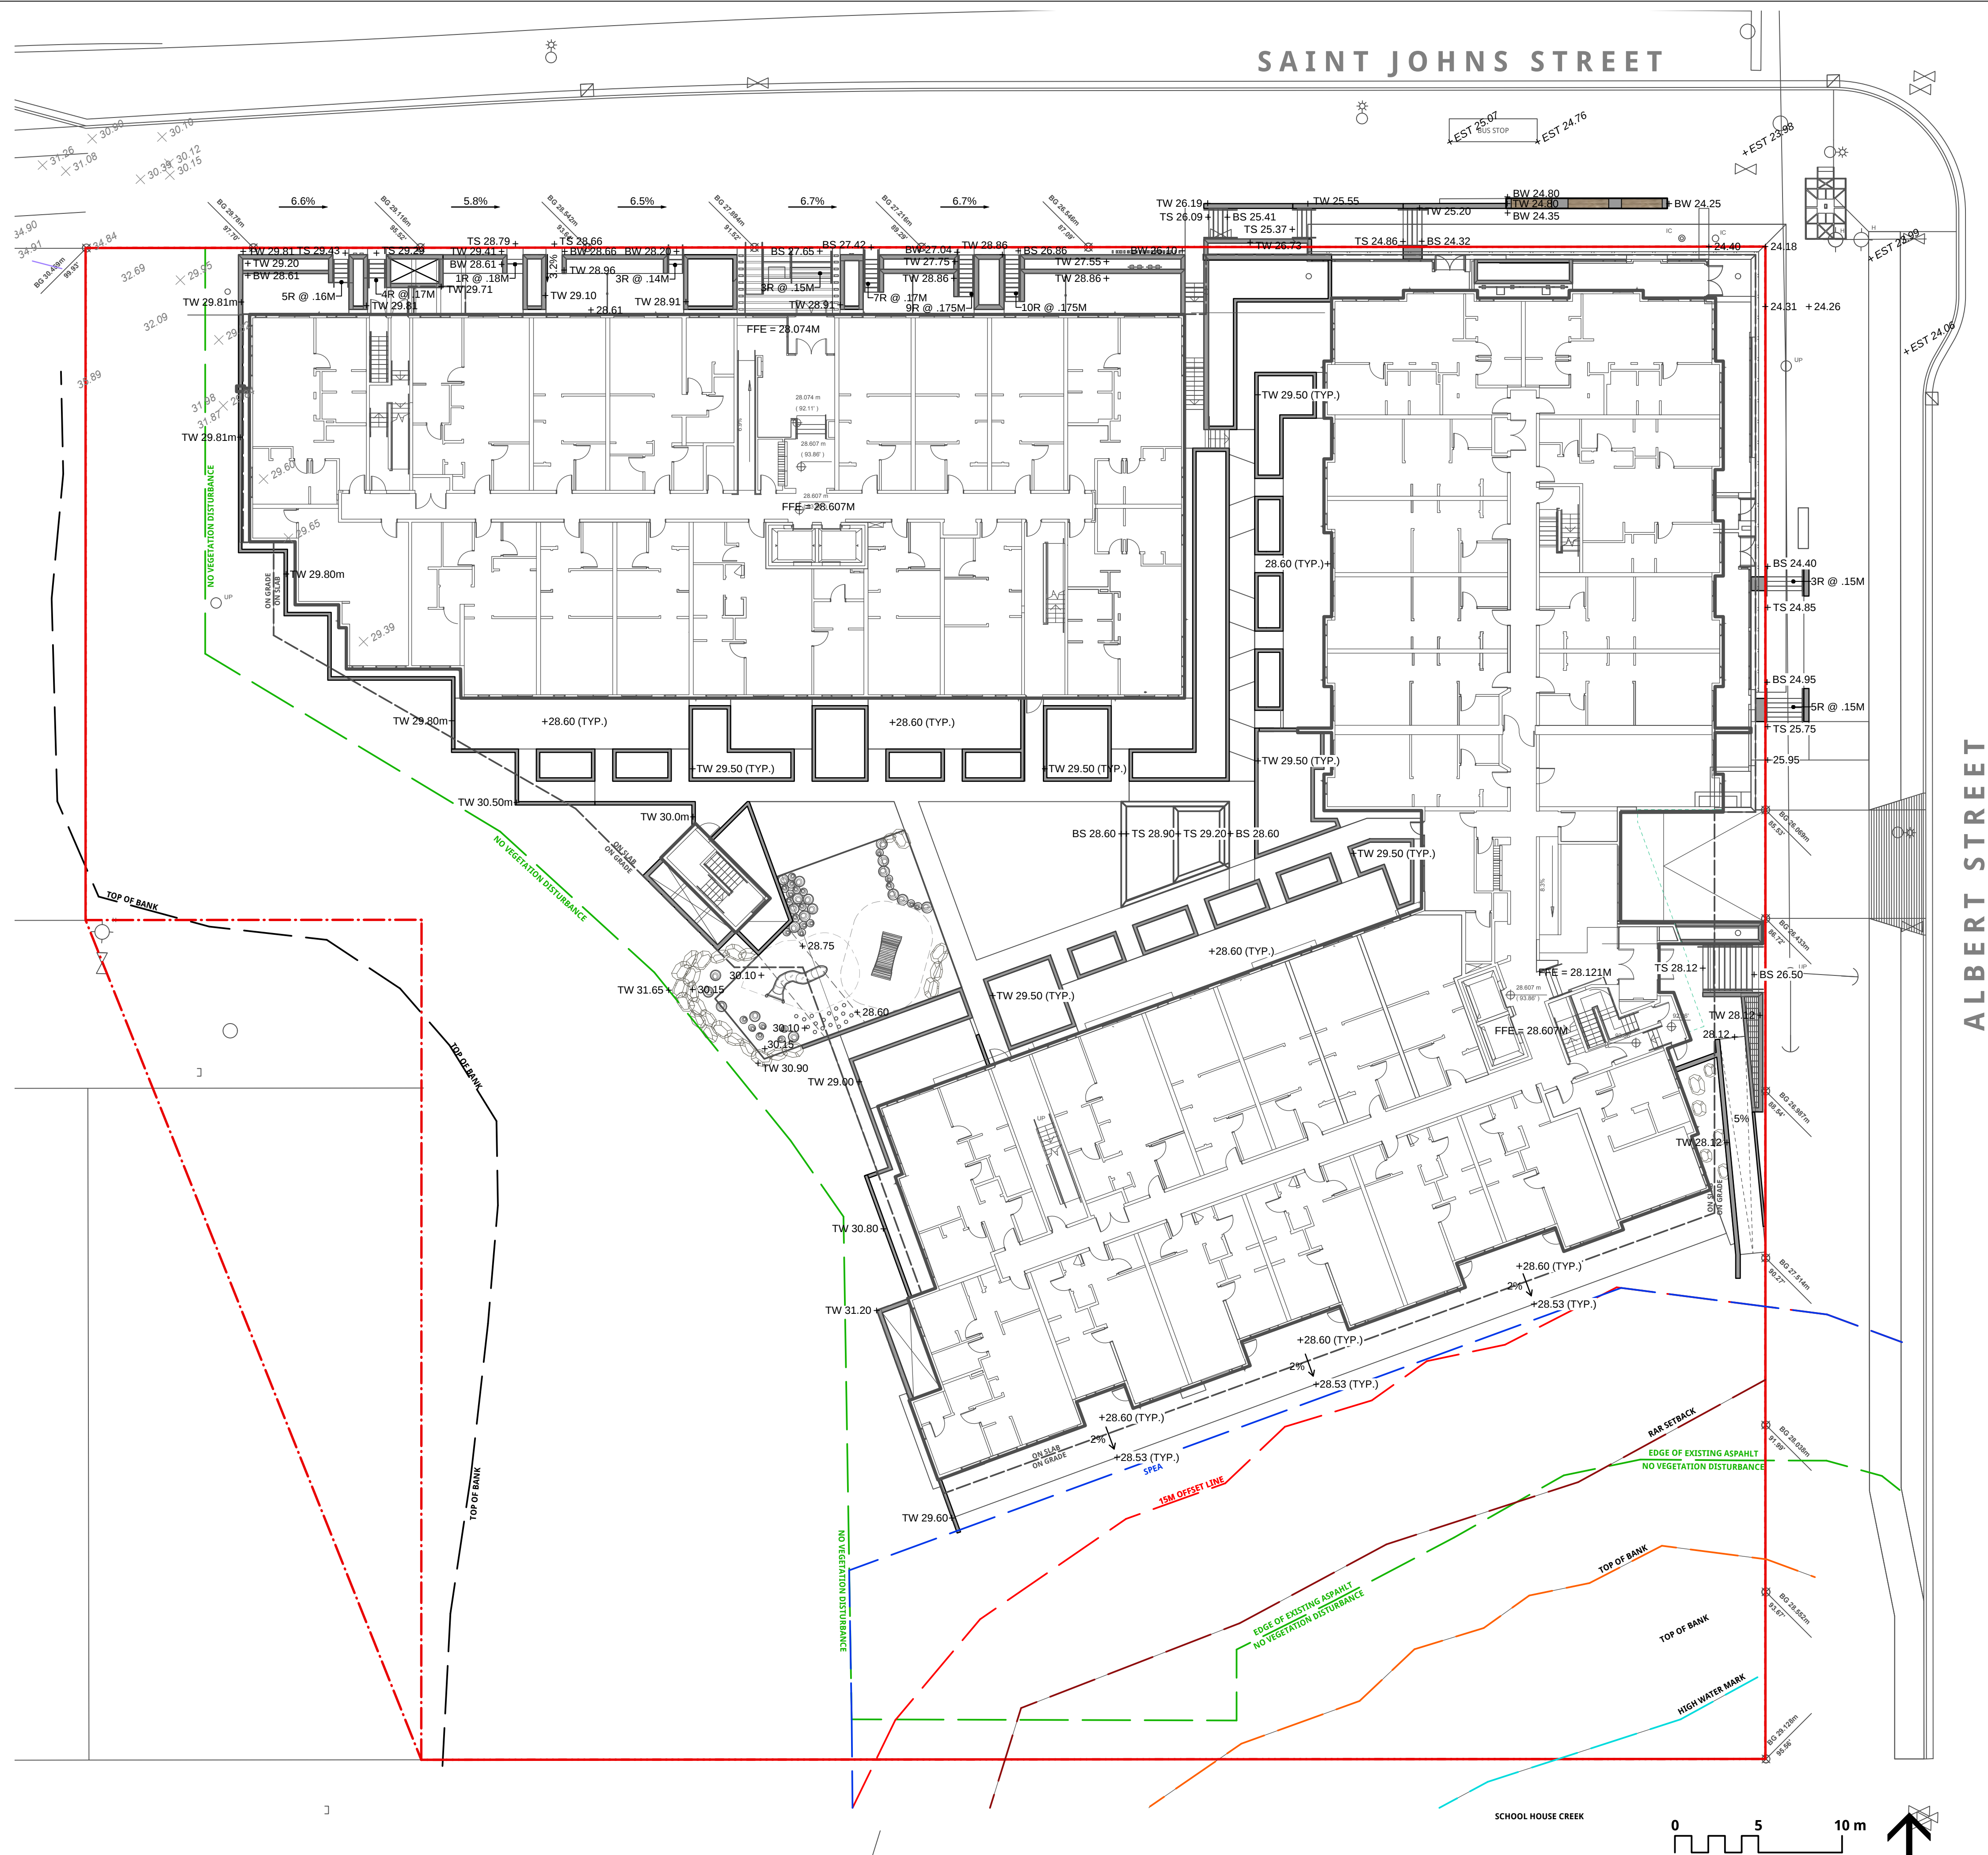

ALBERT STREET

1	ISSUED FOR RZ/DP	19-09-06
REVISIONS		

2025 Saint Johns Street
Port Moody, BC

Scale:	1:200
Drawn:	KD
Reviewed:	DS
Project No.	06-653

LANDSCAPE LEVEL 1 GRADING PLAN

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APPROPRIATE COMPANY, DEPARTMENT OR
PERSON(S) OF ITS INTENTION TO CARRY OUT ITS
OPERATIONS.



NATIVE & EVERGREEN LAYERS



Acer circinatum
Vine Maple



Iris tenax
Oregon Iris



Rosa gymnocarpa
Baldhip Rose



Taxus x media 'Hicksii'
Hick's Yew



ENVIRONMENTALLY SENSITIVE SPECIES



Amelanchier alnifolia
Saskatoon Berry



Arctostaphylos uva-ursi
Kinnikinnick



Malus fusca
Pacific Crabapple



Polystichum Munitum
Western Sword Fern

PLANT LIST


QTY.	BOTANICAL NAME	COMMON NAME	SIZE	SPACING
TREES				
13	*Acer circinatum	Vine Maple	6cm cal., B&B	as shown
8	Cercis canadensis 'Forest Pansy'	Eastern Redbud	7cm cal., B&B	as shown
15	Fraxinus pennsylvanica 'Prairie Spire'	Prairie Spire Ash	6cm cal., B&B	as shown
4	Liquidambar styraciflua 'Slender Silhouette'	Fastigiate Sweetgum	6cm cal., B&B	as shown
4	*Malus fusca	Pacific Crabapple	6cm cal., B&B	as shown
31	*Picea omorika	Serbian Spruce	3M height, B&B	as shown
6	Stewartia pseudocamellia	Japanese Stewartia	6cm cal., B&B	as shown
	Street Tree Per City of Port Moody		6cm cal., B&B	as shown
SHRUBS				
	*Amelanchier alnifolia	Saskatoon Berry	#2 pot	42" o.c
	Buxus microphylla 'Winter Beauty'	Korean Boxwood	#5 pot	18" o.c
	*Cornus stolonifera	Red Osier Dogwood	#5 pot	36" o.c
	Cotoneaster dammerii	Little-Leaf Cotoneaster	#2 pot	24" o.c
	Lavandula angustifolia 'Hidcote'	English Lavender	#2 pot	18" o.c
	*Physocarpus capitalus	Pacific Ninebark	#2 pot	36" o.c
	*Polystichum munitum	Western Sword Fern	#2 pot	24" o.c
	*Rhododendron macrophyllum	Pacific Rhododendron	#5 pot	36" o.c
	*Rosa gymnocarpa	Baldhip Rose	#2 pot	36" o.c
	Sarcococca hookerana humilis	Himalayan Sweet Box	#2 pot	24" o.c
	Skimmia japonica	Japanese Skimmia	#3 pot	24" o.c
	Stipa tenuissima	Mexican Feather Grass	#2 pot	24" o.c
	*Symphoricarpus albus	Snowberry	#2 pot	24" o.c
	Taxus X Media 'Hicksii'	Hick's Yew - 1.5M height	#3 pot	20" o.c
GROUND COVERS AND VINES				
	*Arctostaphylos uva-ursi	Kinnikinnick	4"(10cm) pot	15" o.c
	Ceanothus griseus horizontalis	Creeping California Lilac	4"(10cm) pot	15" o.c
50/50mix	Rubus calycinoides	Emerald Carpet	4"(10cm) pot	15" o.c
	Oxalis oreganum	Redwood Spurge	4"(10cm) pot	15" o.c
50/50mix	Pachysandra terminalis	Japanese Spurge	4"(10cm) pot	15" o.c
GRASSES, PERENNIALS, BULBS, AND ANNUALS				
	*Achillia millefolium	Yarrow	#1 pot	18" o.c
	*Dicentra formosa	Bleeding Heart	#1 pot	18" o.c
	*Iris tenax	Oregon Iris	#1 pot	18" o.c
ENVIRONMENTAL SENSITIVE AREA				
	*Acer macrophyllum	Broadleaf Maple	6cm cal., B&B	as shown
	*Pinus contorta var. contorta	Shore Pine	6cm cal., B&B	as shown
	*Achillia millefolium	Yarrow	#1 pot	18" o.c
	*Amelanchier alnifolia	Saskatoon Berry	#2 pot	42" o.c
	*Blechnum spicant	Deer Fern	#2 pot	24" o.c
	*Cornus stolonifera	Red Osier Dogwood	#5 pot	36" o.c
	*Gautheria shallon	Salal	#2 pot	24" o.c
	*Lonicera involucrata	Black Twinberry	#2 pot	24" o.c
	*Polystichum munitum	Western Sword Fern	#2 pot	24" o.c
	*Physocarpus capitalus	Pacific Ninebark	#2 pot	36" o.c
	*Ribes sanguineum	Red-Flowering Currant	#2 pot	36" o.c
	*Rosa gymnocarpa	Baldhip Rose	#2 pot	36" o.c
	*Symphoricarpus albus	Snowberry	#2 pot	24" o.c
* Indicates native species				

ALBERT STREET

2025 Saint Johns Street
Port Moody, BC

Scale:	N/A
Drawn:	KD
Reviewed:	DS
Project No.	06-653

LANDSCAPE MATERIALS

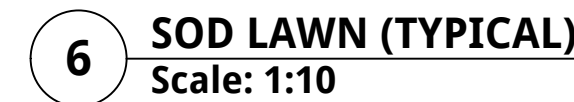


1	ISSUED FOR RZ/DP	19-09-06
REVISIONS		

2025 Saint Johns Street
Port Moody, BC


Scale:	AS SHOWN
Drawn:	KD
Reviewed:	DS
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LANDSCAPE DETAILS


SOFTSCAPE

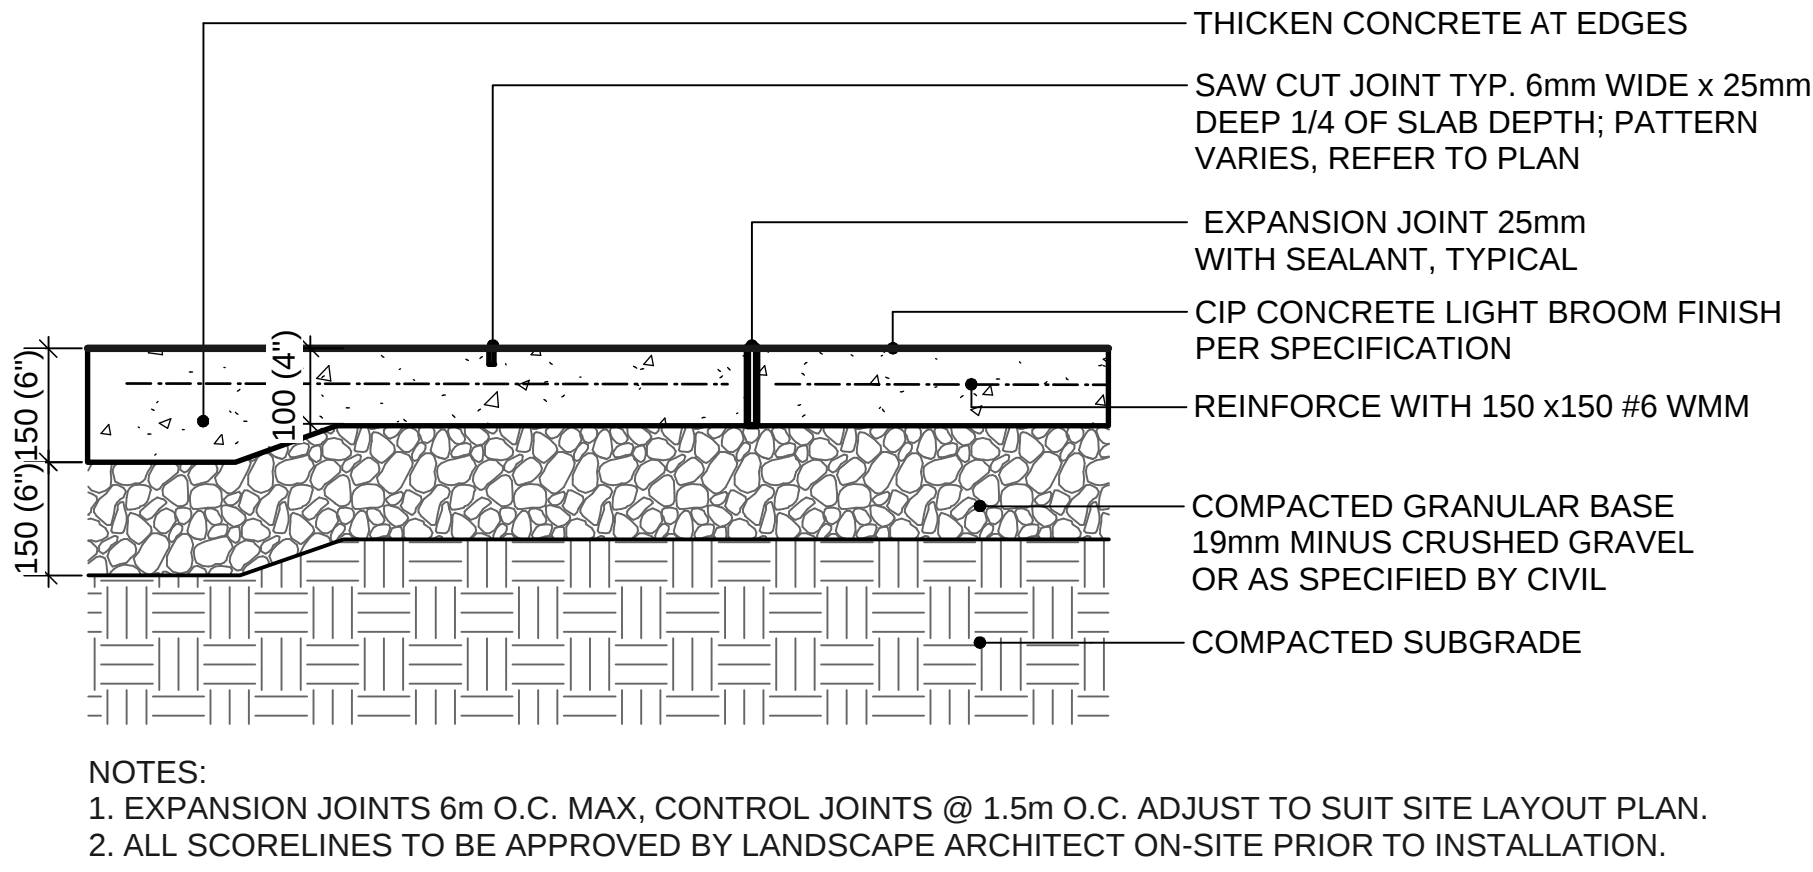


1 CIP CONCRETE ON GRADE
Scale: 1:10

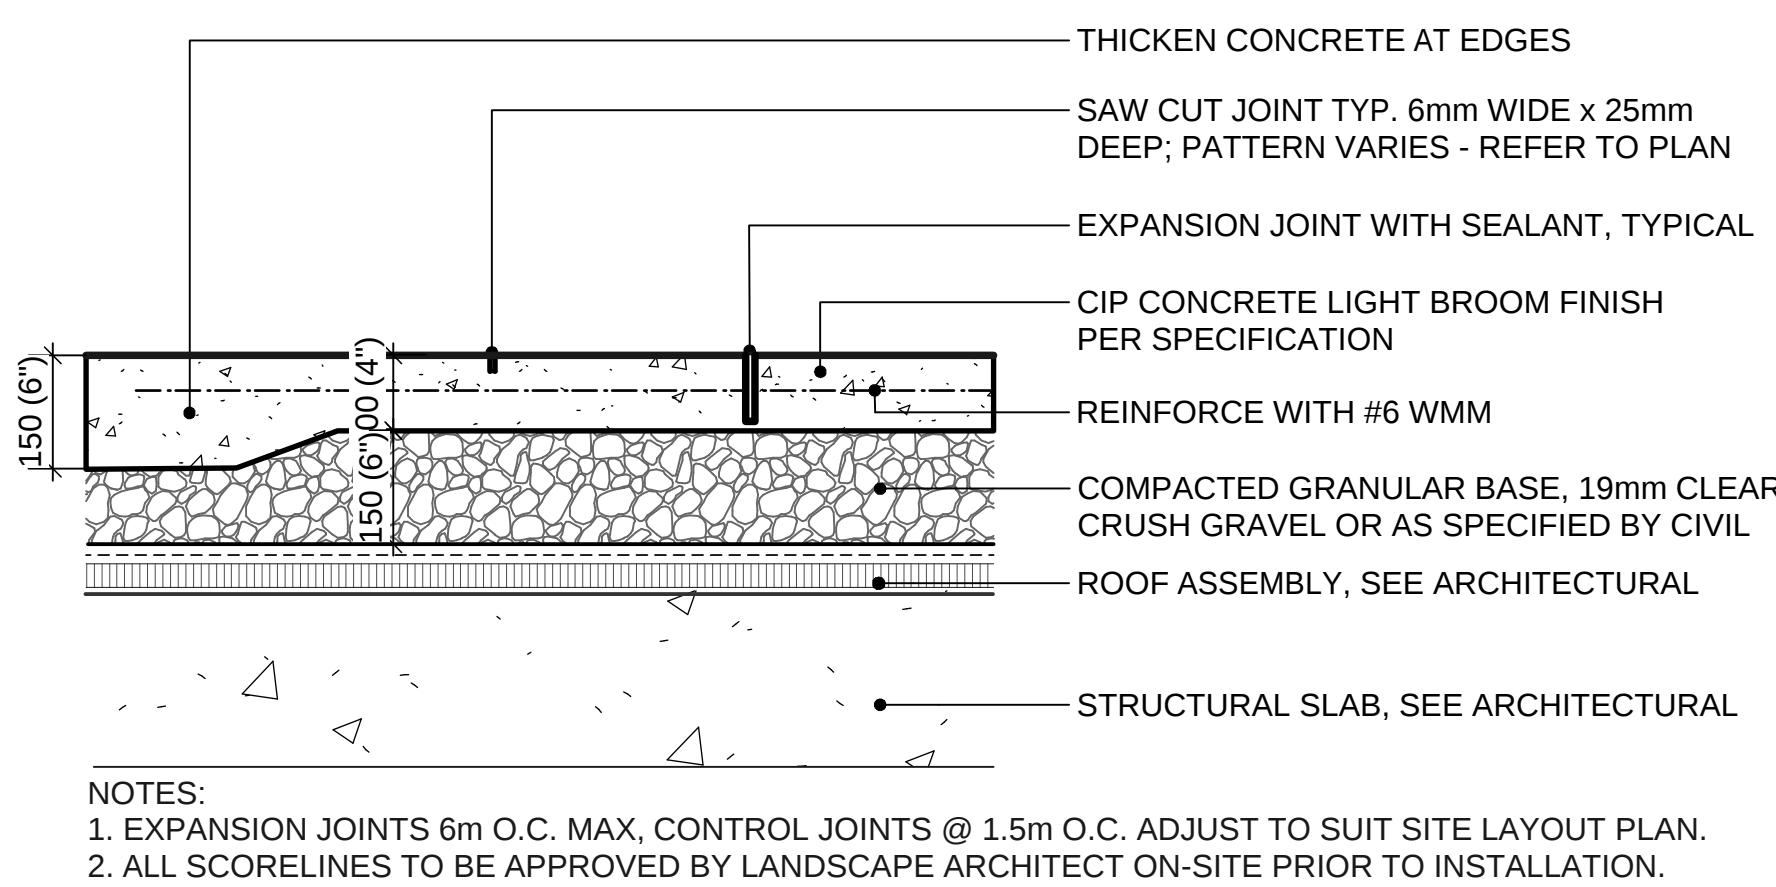


2 CIP CONCRETE ON SLAB (TYPICAL)
Scale: 1:10

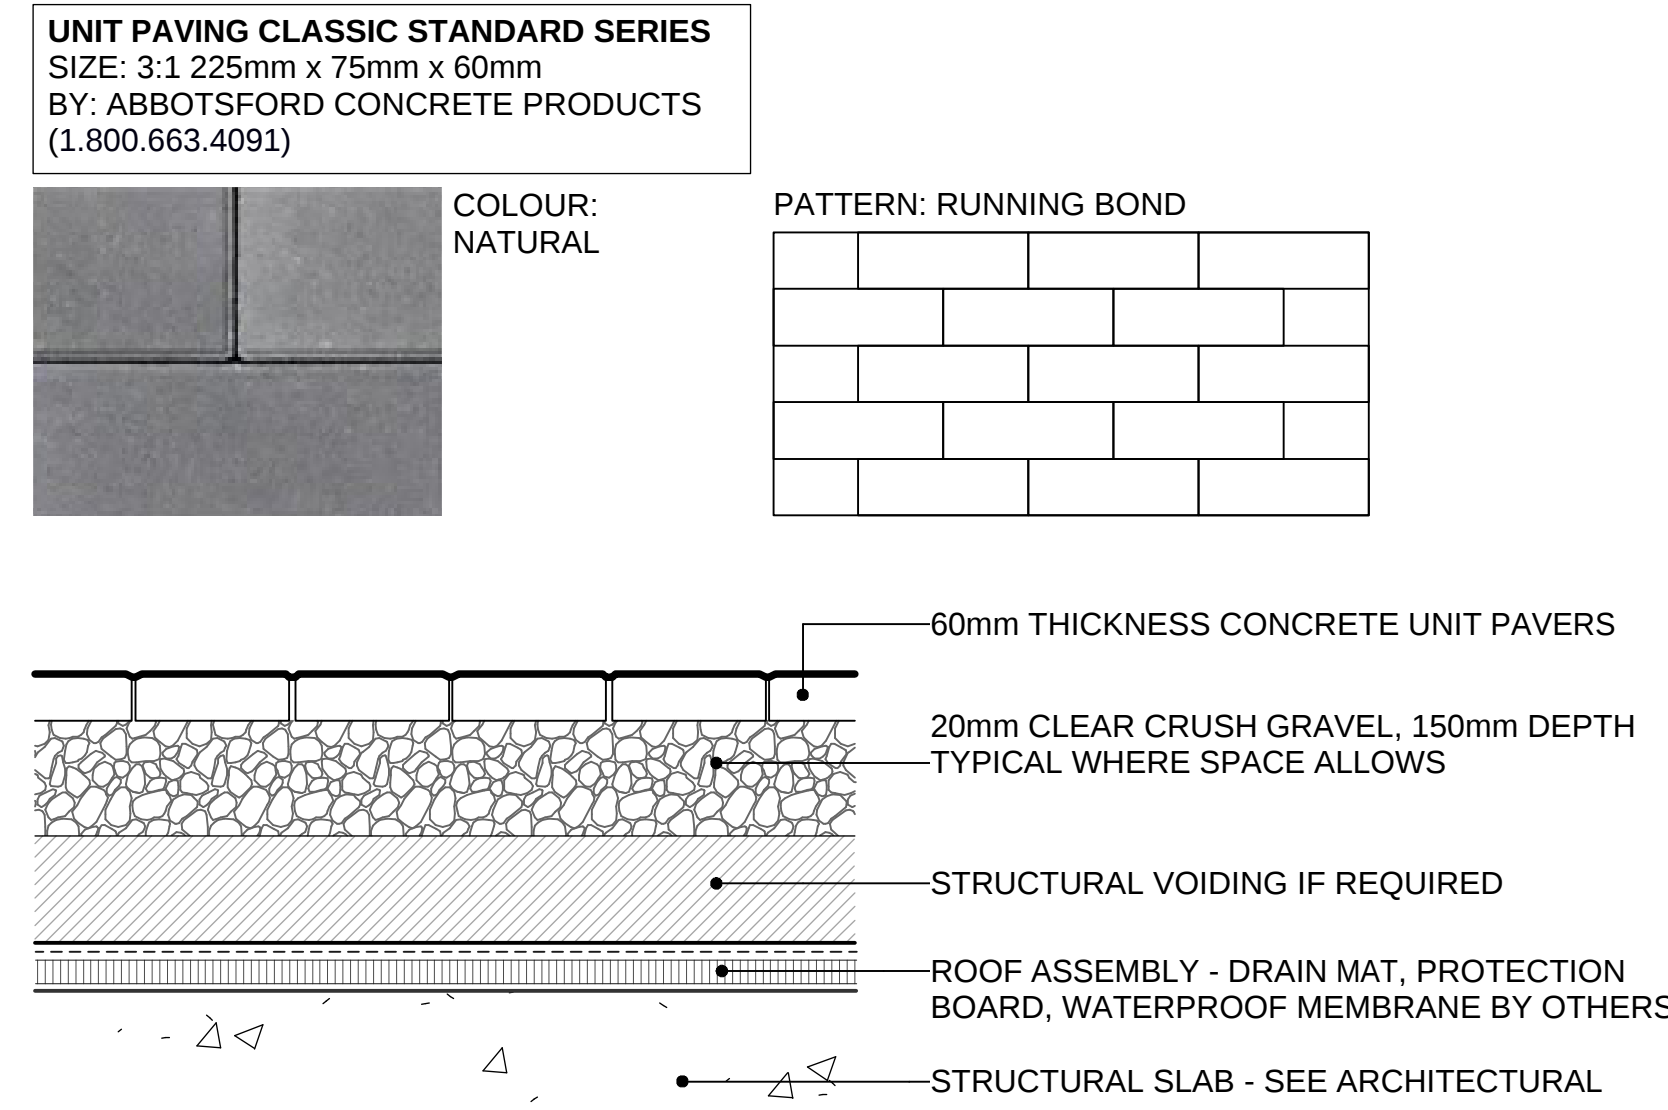


3 PEDESTRIAN UNIT PAVING ON SLAB
Scale: 1:10

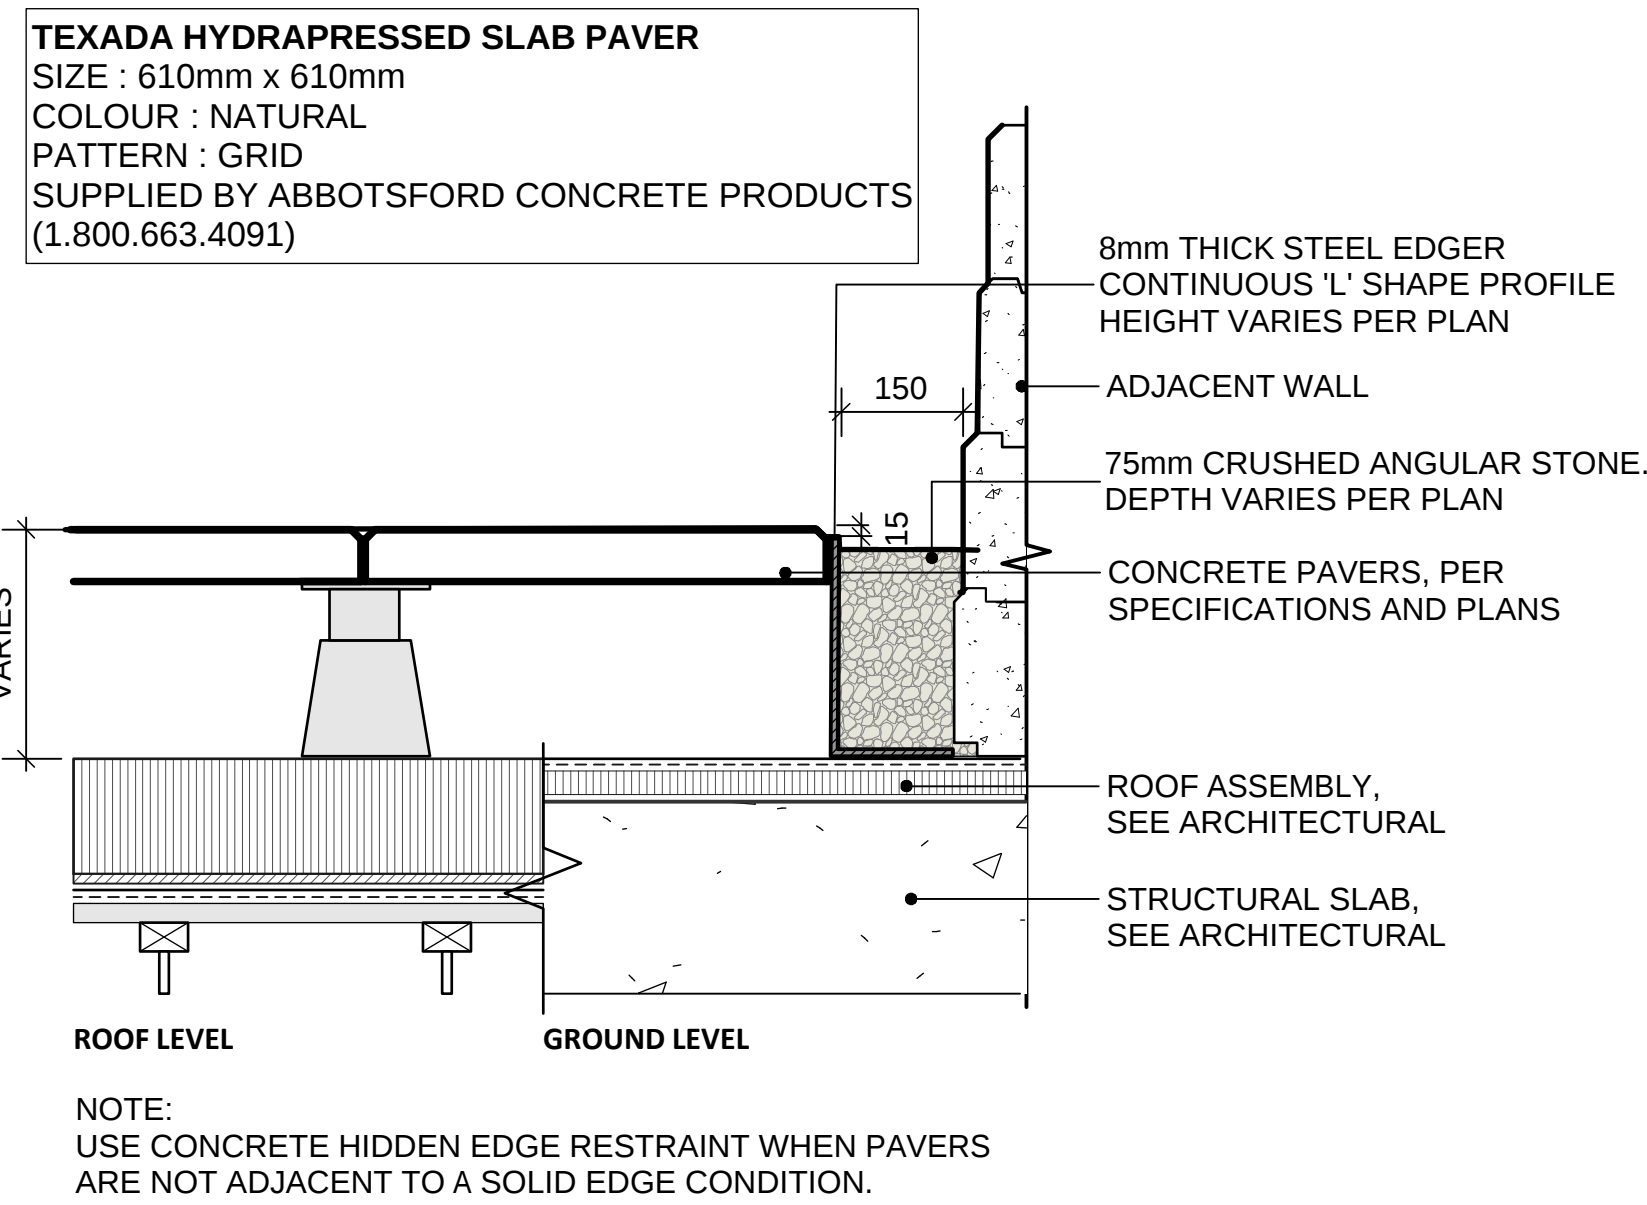

4 HYDRAPRESSED CONCRETE PAVERS ON SLAB (TYPICAL)
Scale: 1:10

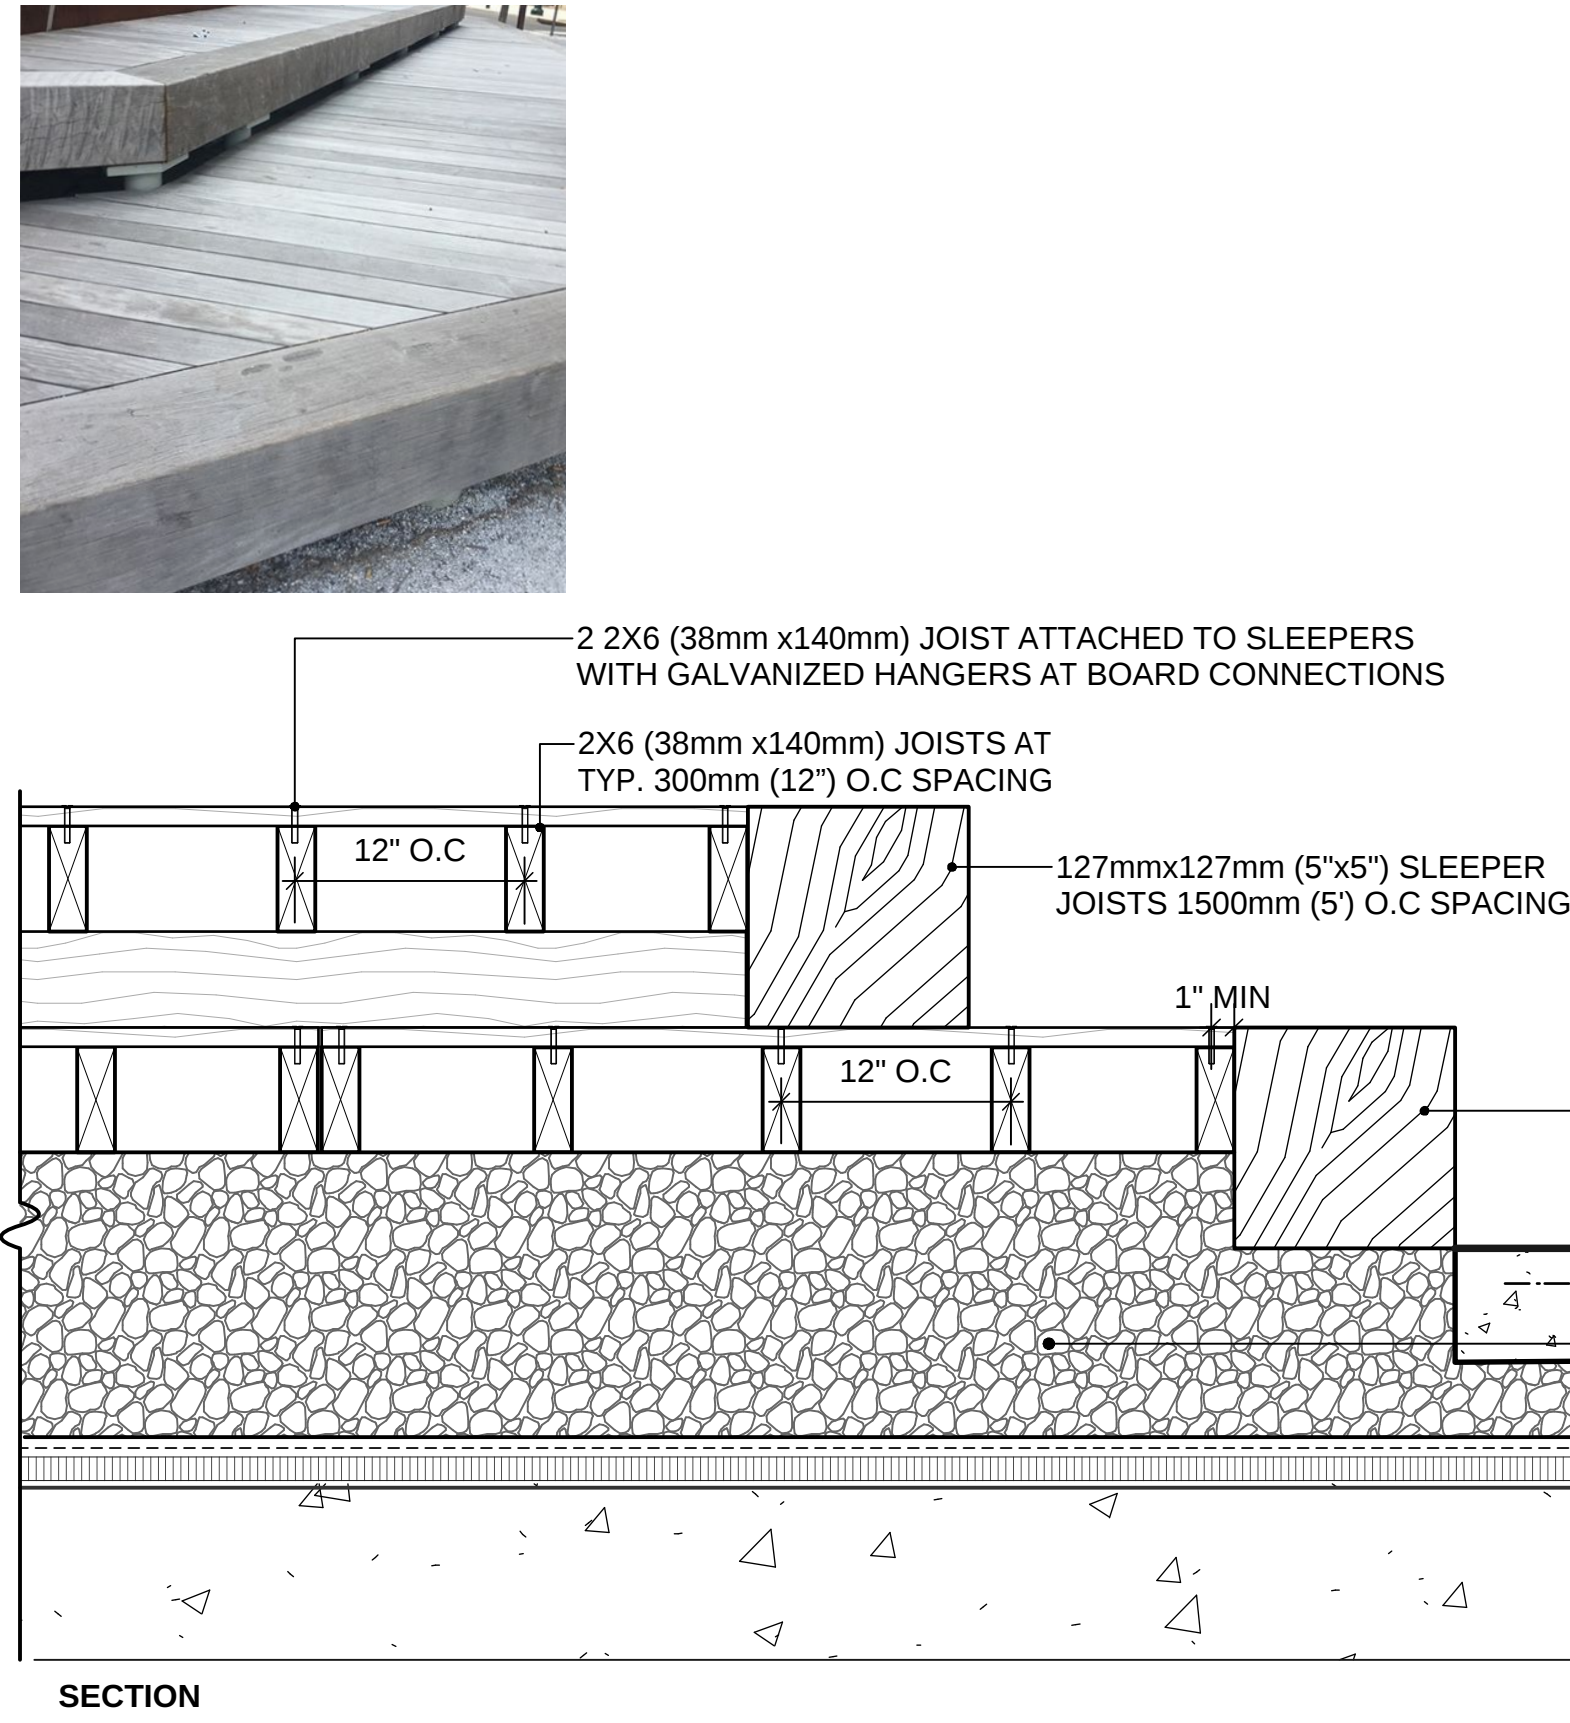


SECTION

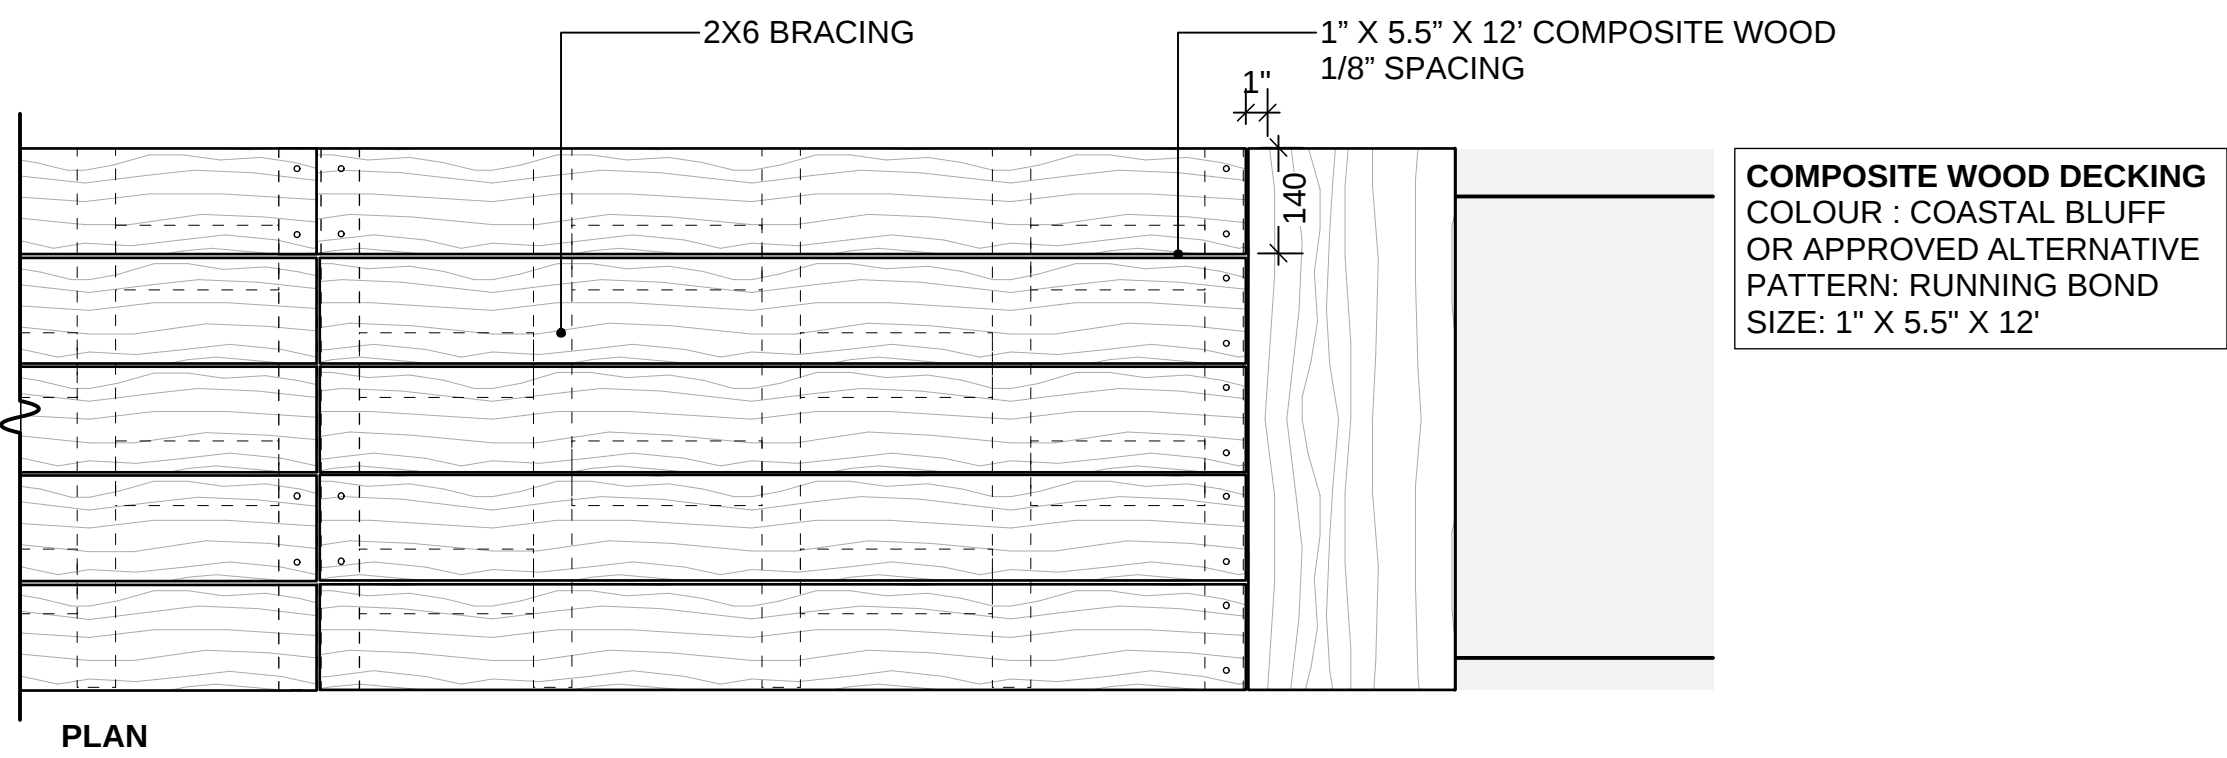


PLAN


6 RAISED WOOD DECK
Scale: 1:10

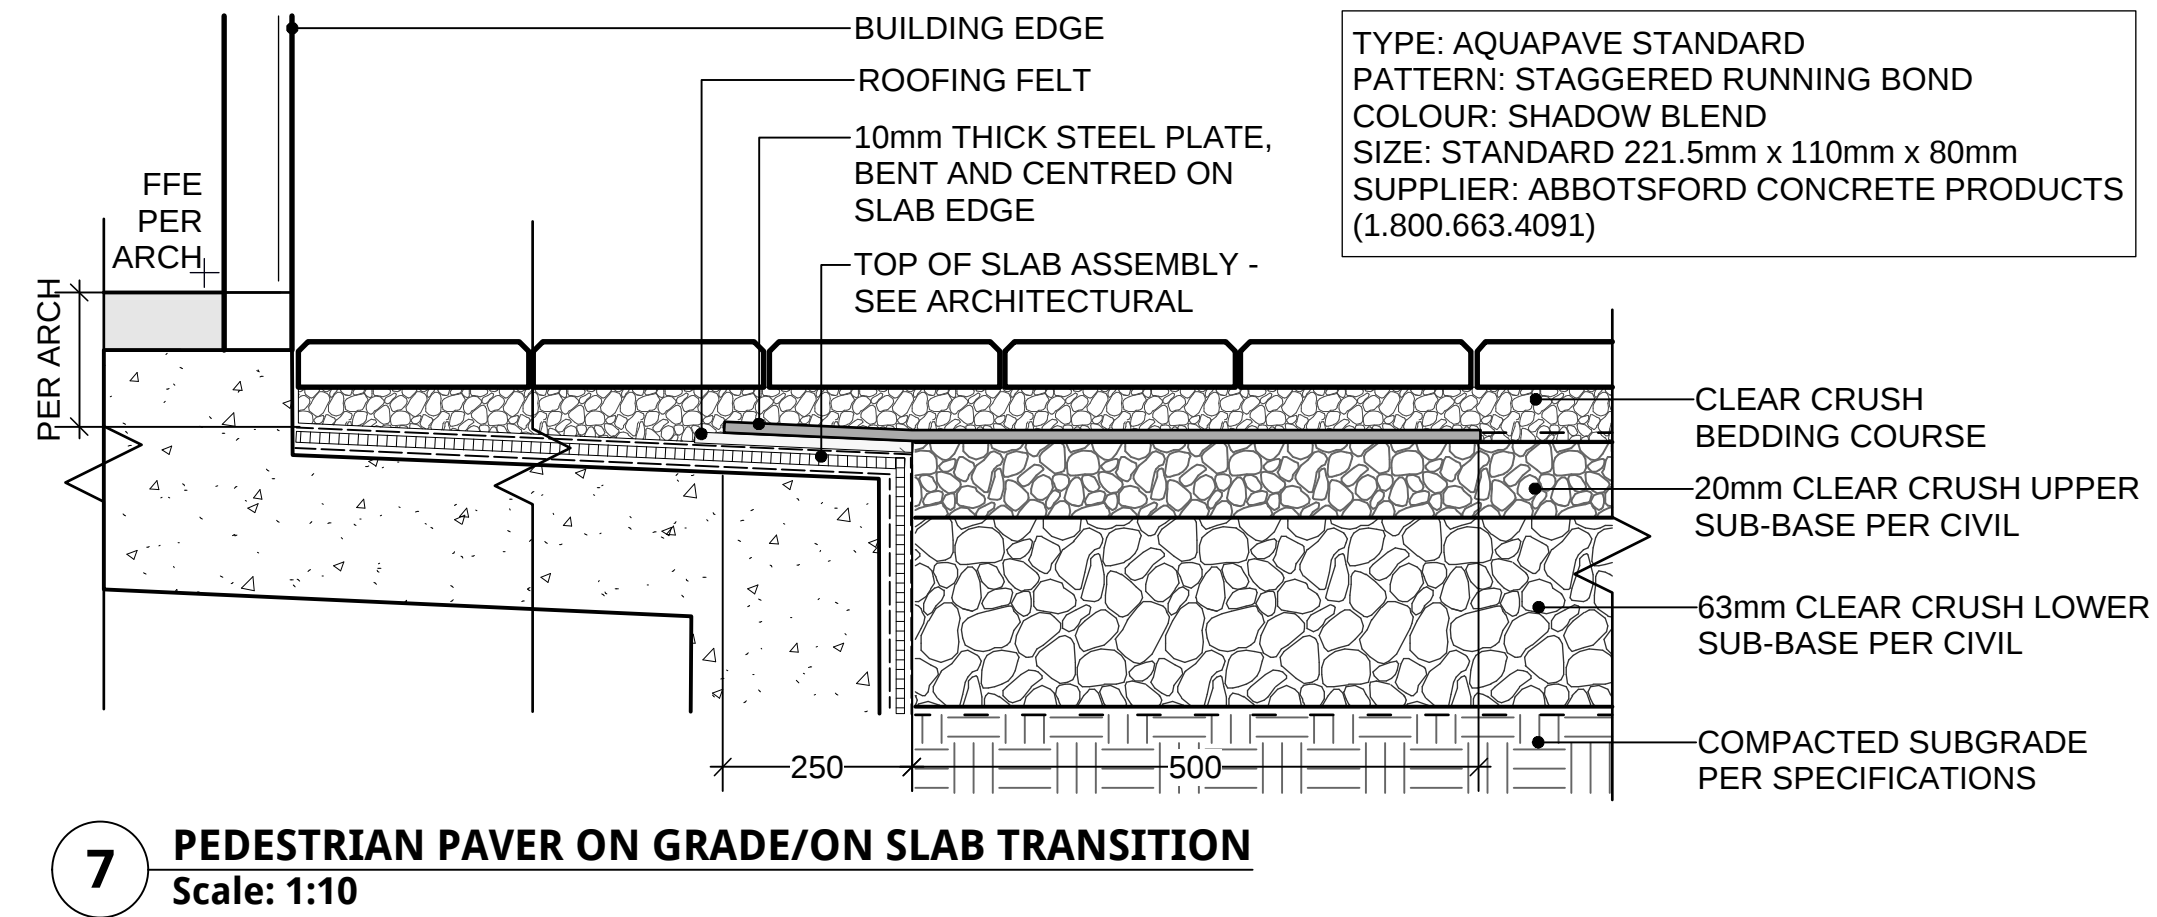

7 PEDESTRIAN PAVER ON GRADE/ON SLAB TRANSITION
Scale: 1:10

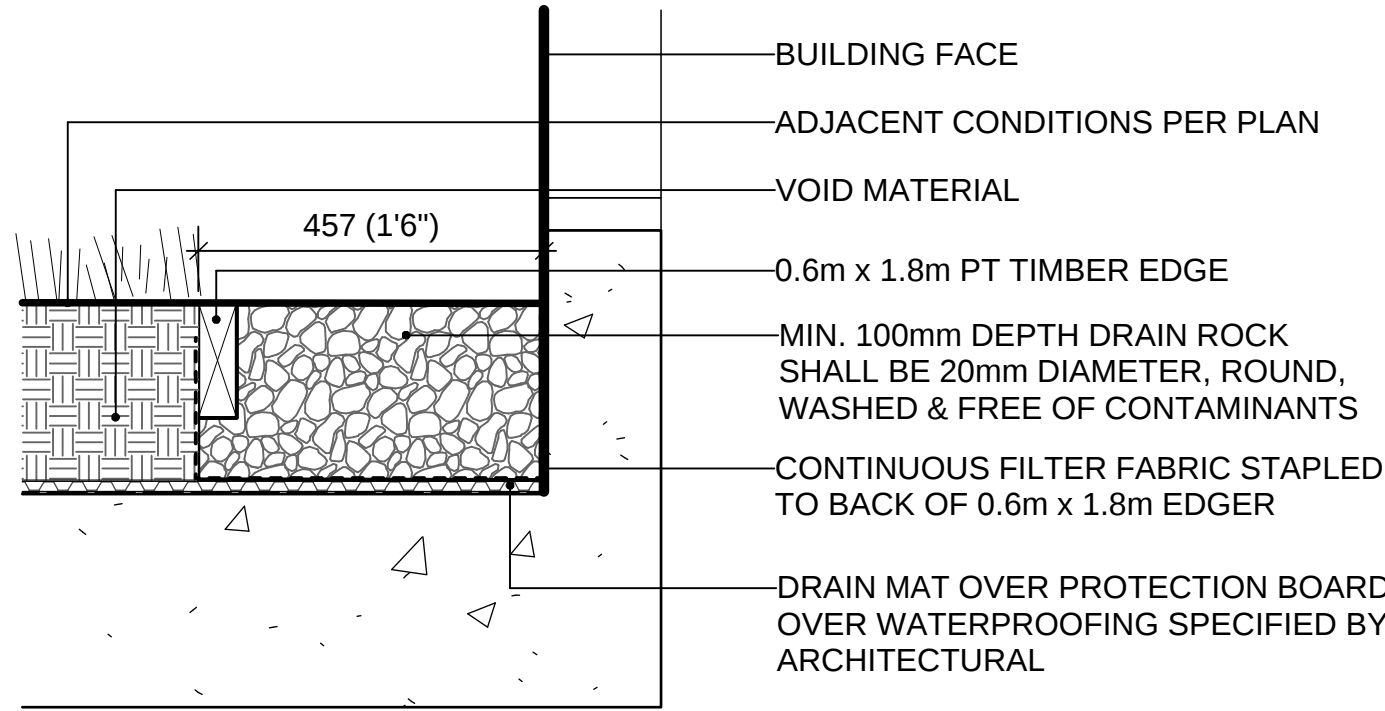

5 GRAVEL DRAIN STRIP - ON SLAB
Scale: 1:10

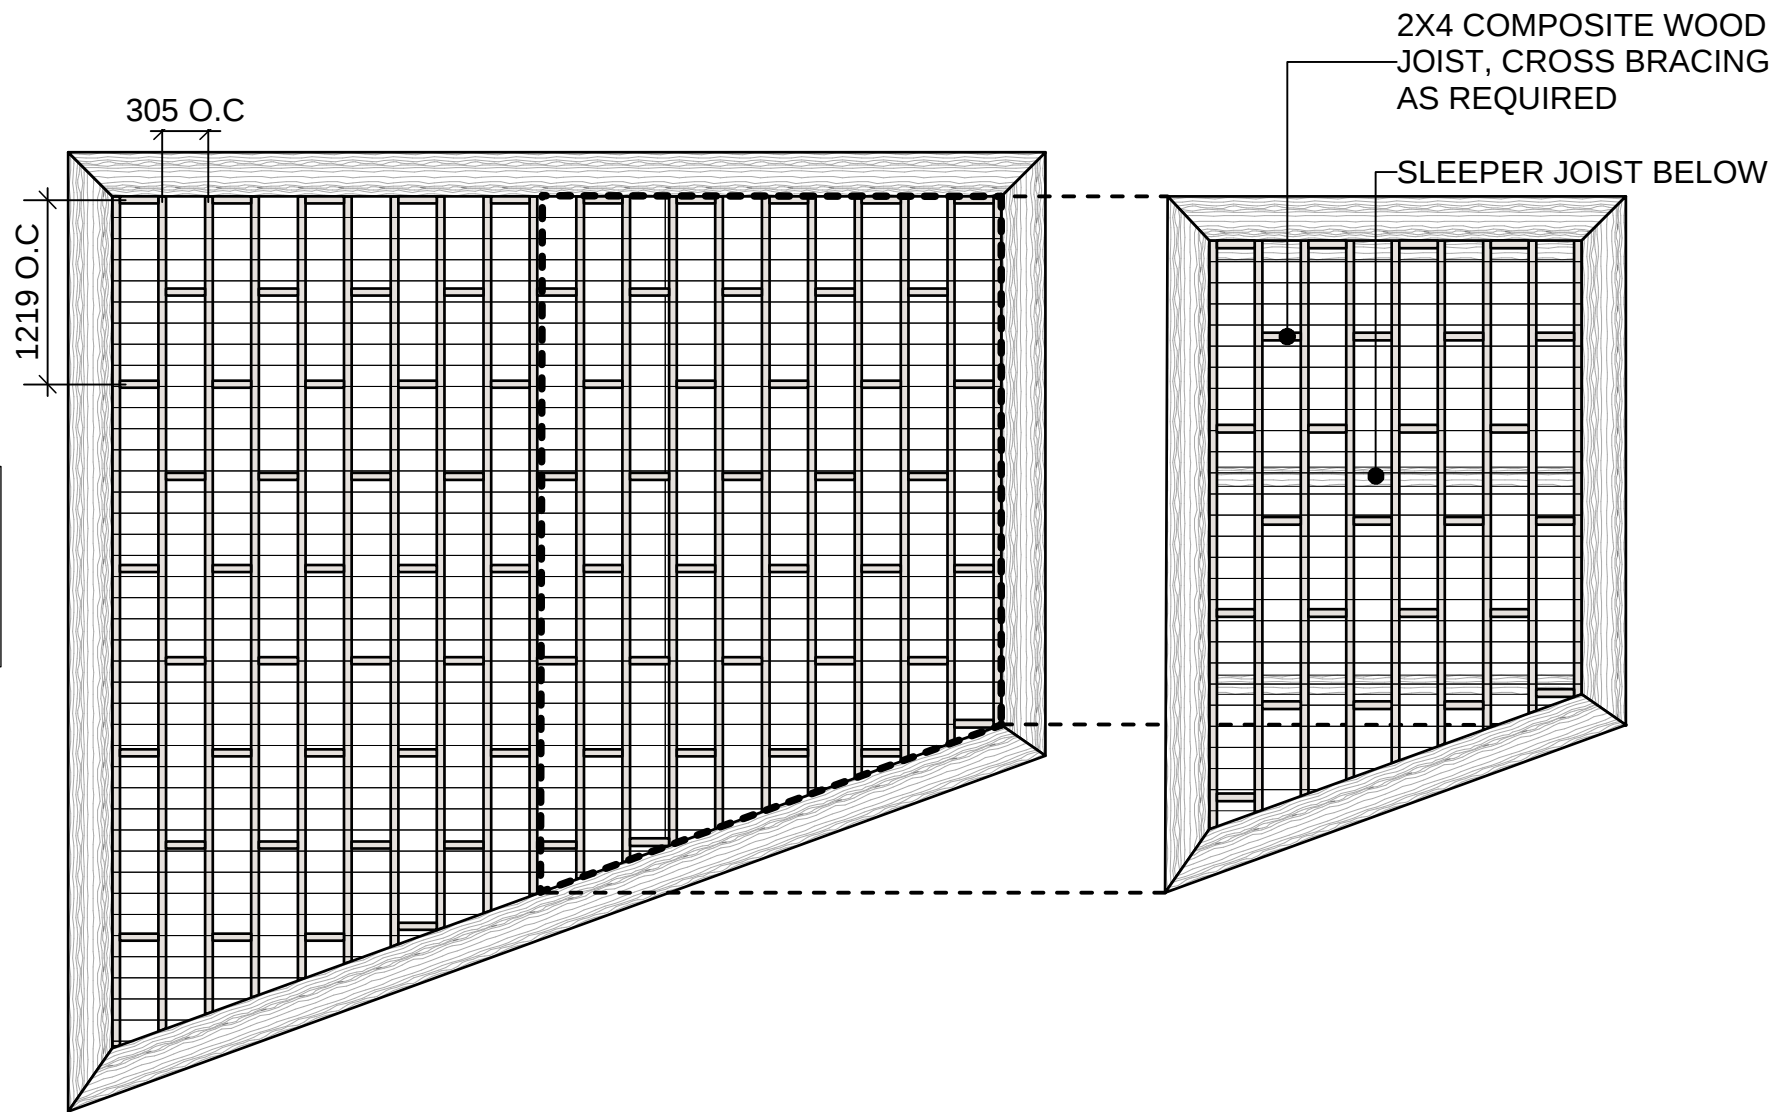

6A FRAMING PLAN
Scale: 1:50

ALBERT STREET

2025 Saint Johns Street
Port Moody, BC

Scale:	AS SHOWN
Drawn:	KD
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Project No.	06-653

LANDSCAPE DETAILS HARDSCAPE




4 WOOD GUARDRAIL



1. REMOVE BARK, SAND ALL CORNERS, EDGES, AND TIMBER SMOOTH, NO ROUGH SURFACES, SMOOTH AND FREE OF SPLINTERS.
2. ENSURE POSITIVE DRAINAGE FROM TOP FACE OF LOG; NO DEPRESSIONS PERMITTED
3. APPLY 2 COATS BOILED LINSEED OIL FINISH BEFORE CONSTRUCTION TO ENSURE ALL EDGES ARE FINISHED PRIOR TO ASSEMBLY.



1 PLAY LOGS
Scale: 1:10

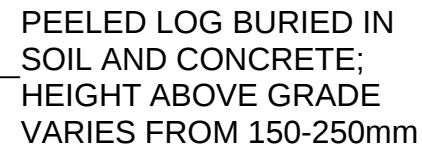

—RUBBER PLAY SURFACING


C.I.P. CONCRETE SLAB
—POURED AROUND LOGS
—90 POUND ROOFING FELT
UNDERNEATH LOG AREA

2 PLAY STUMPS
Scale: 1:10




3 PLAY AREA BOULDER EDGE

Scale: 1:10

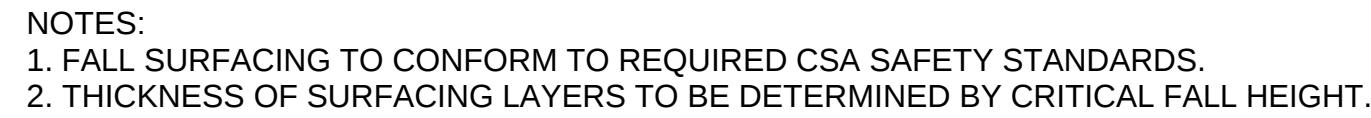

4 RUBBER PLAY SURFACING

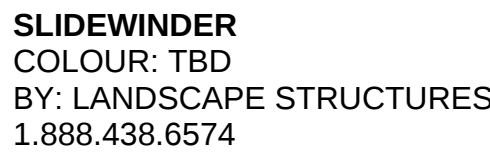

5 PLAY STRUCTURES

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REVISIONS		

ALBERT STREET

2025 Saint Johns Street
Port Moody, BC



Scale:	AS SHOWN
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LANDSCAPE DETAILS

PLAY AREA



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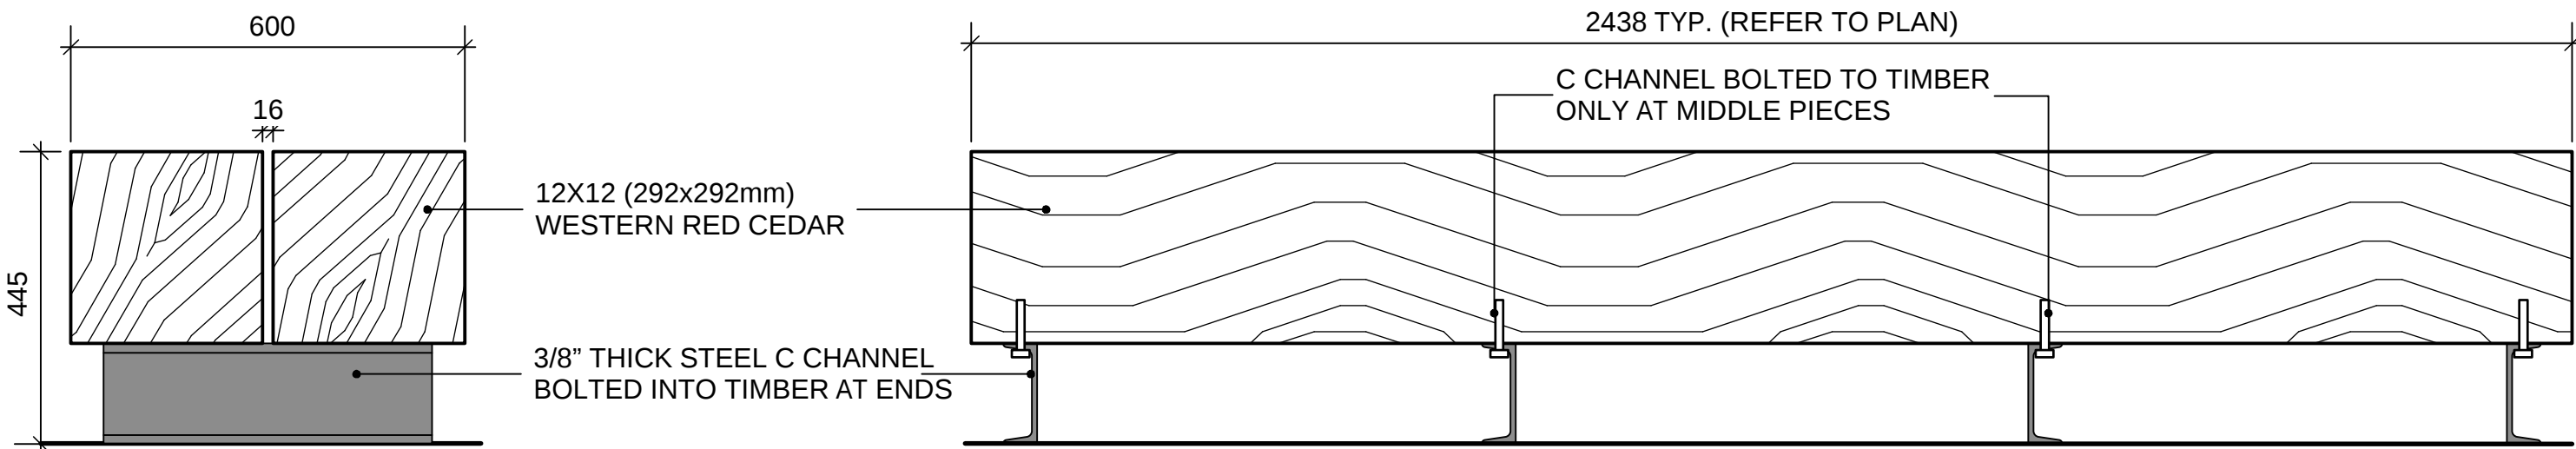


- NOTES:**
1. CONTRACTOR TO PROVIDE ENGINEERED SHOP DRAWINGS OF THE METAL TRELLIS FOR REVIEW AND APPROVAL.
 2. ALL FASTENERS ARE TO BE HOT-DIPPED GALVANIZED.
 3. ALL WELDS TO BE GROUND SMOOTH.
 4. MANUAL SHUT OFF VALVE TO BE PROVIDED FOR GAS BARBEQUE CONNECTION.
 5. BARBEQUE GRILL TO BE INSTALLED AS PER MANUFACTURES INSTRUCTION.
 6. REFER TO SPECIFICATION FOR FINISH AND COLOUR OF TRELLIS STRUCTURE.

1 COVERED BBQ AND COUNTER
Scale: 1:25

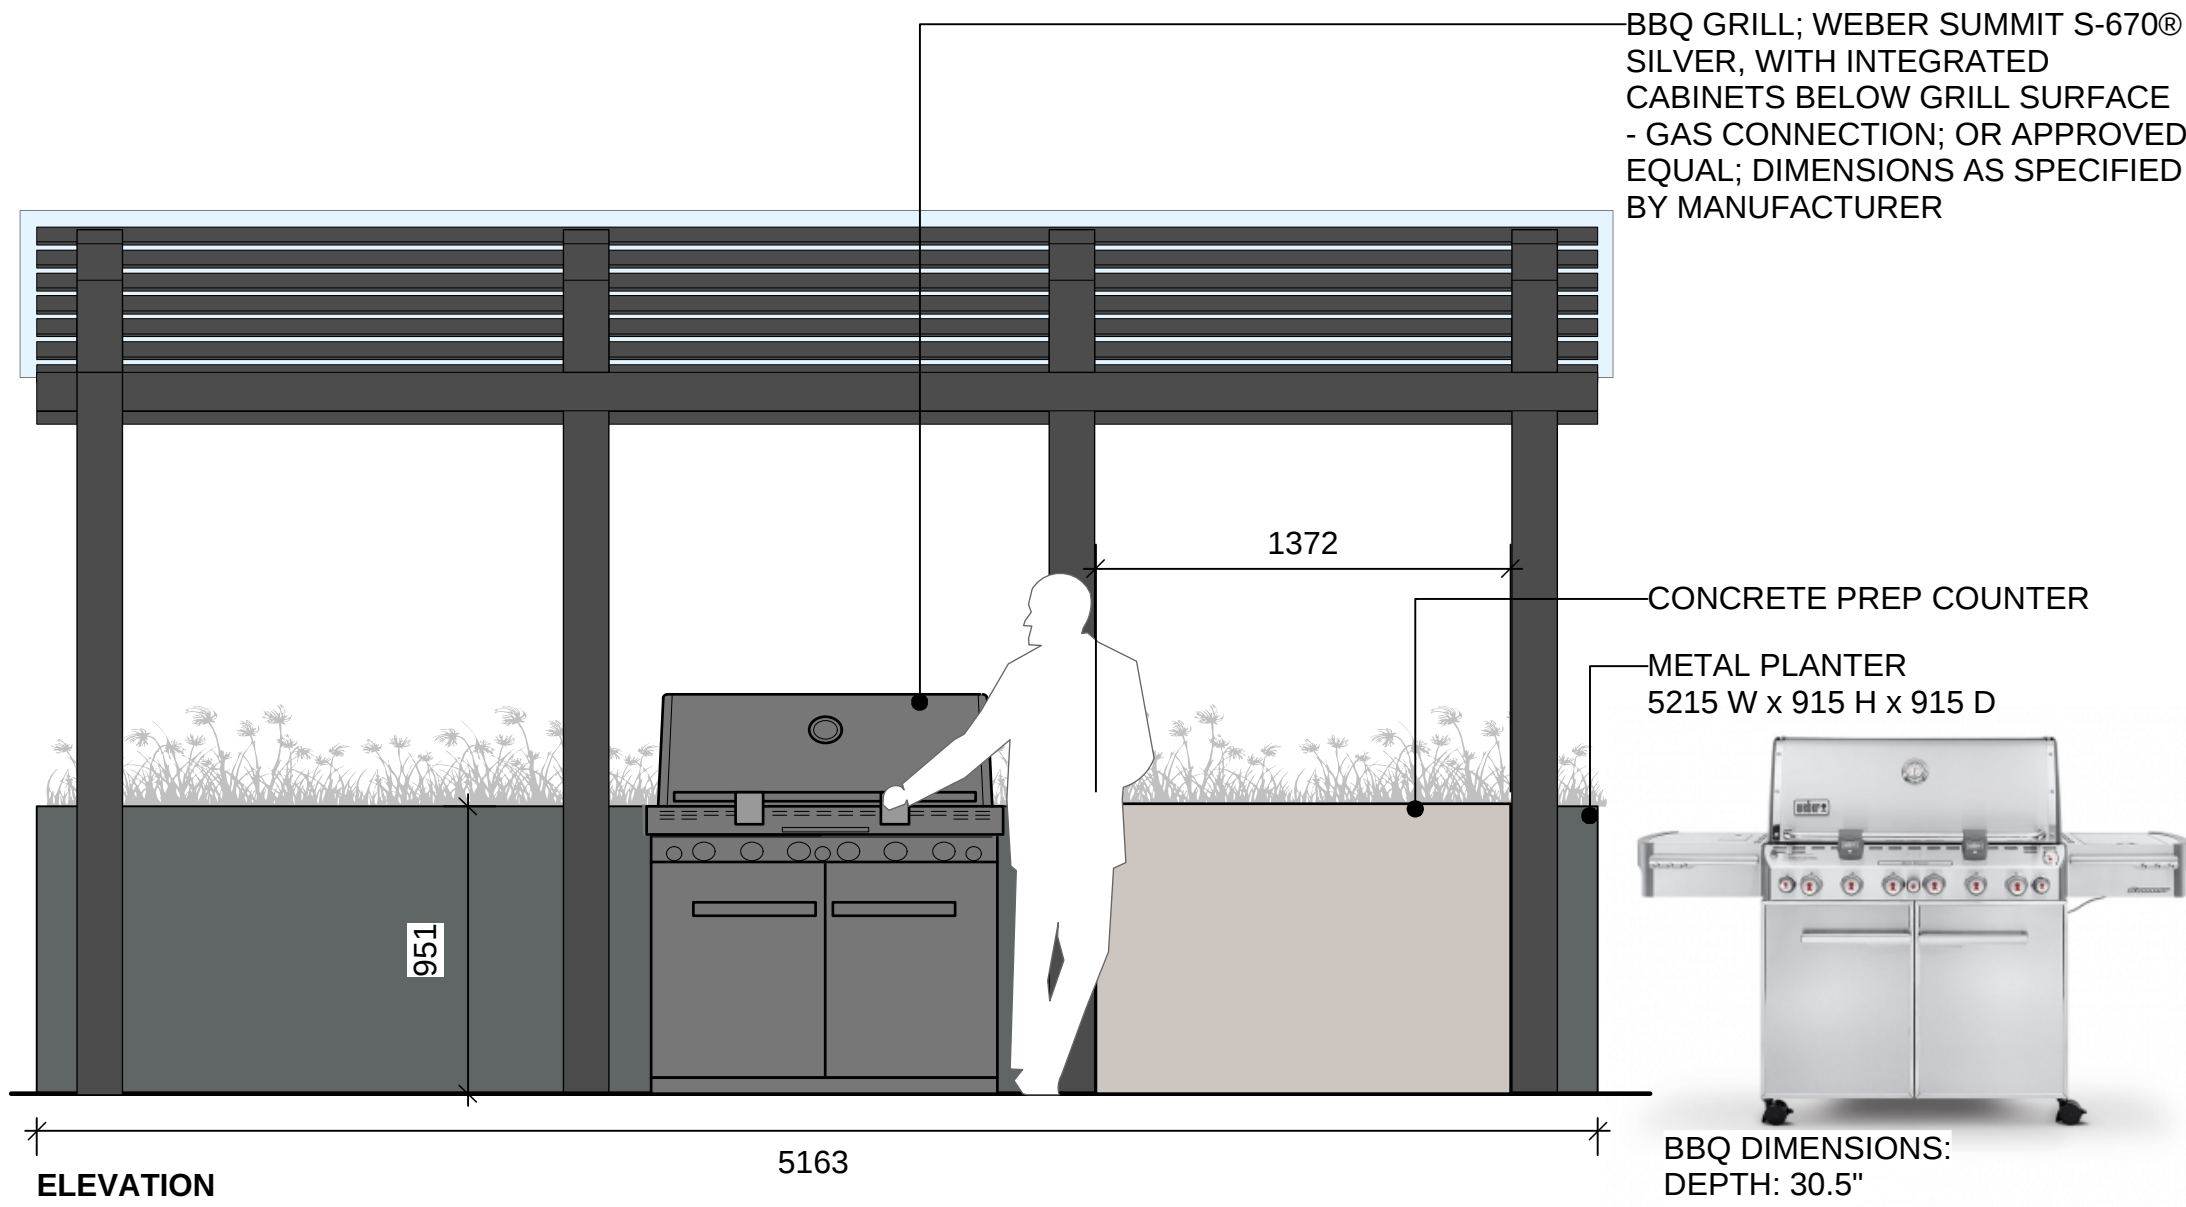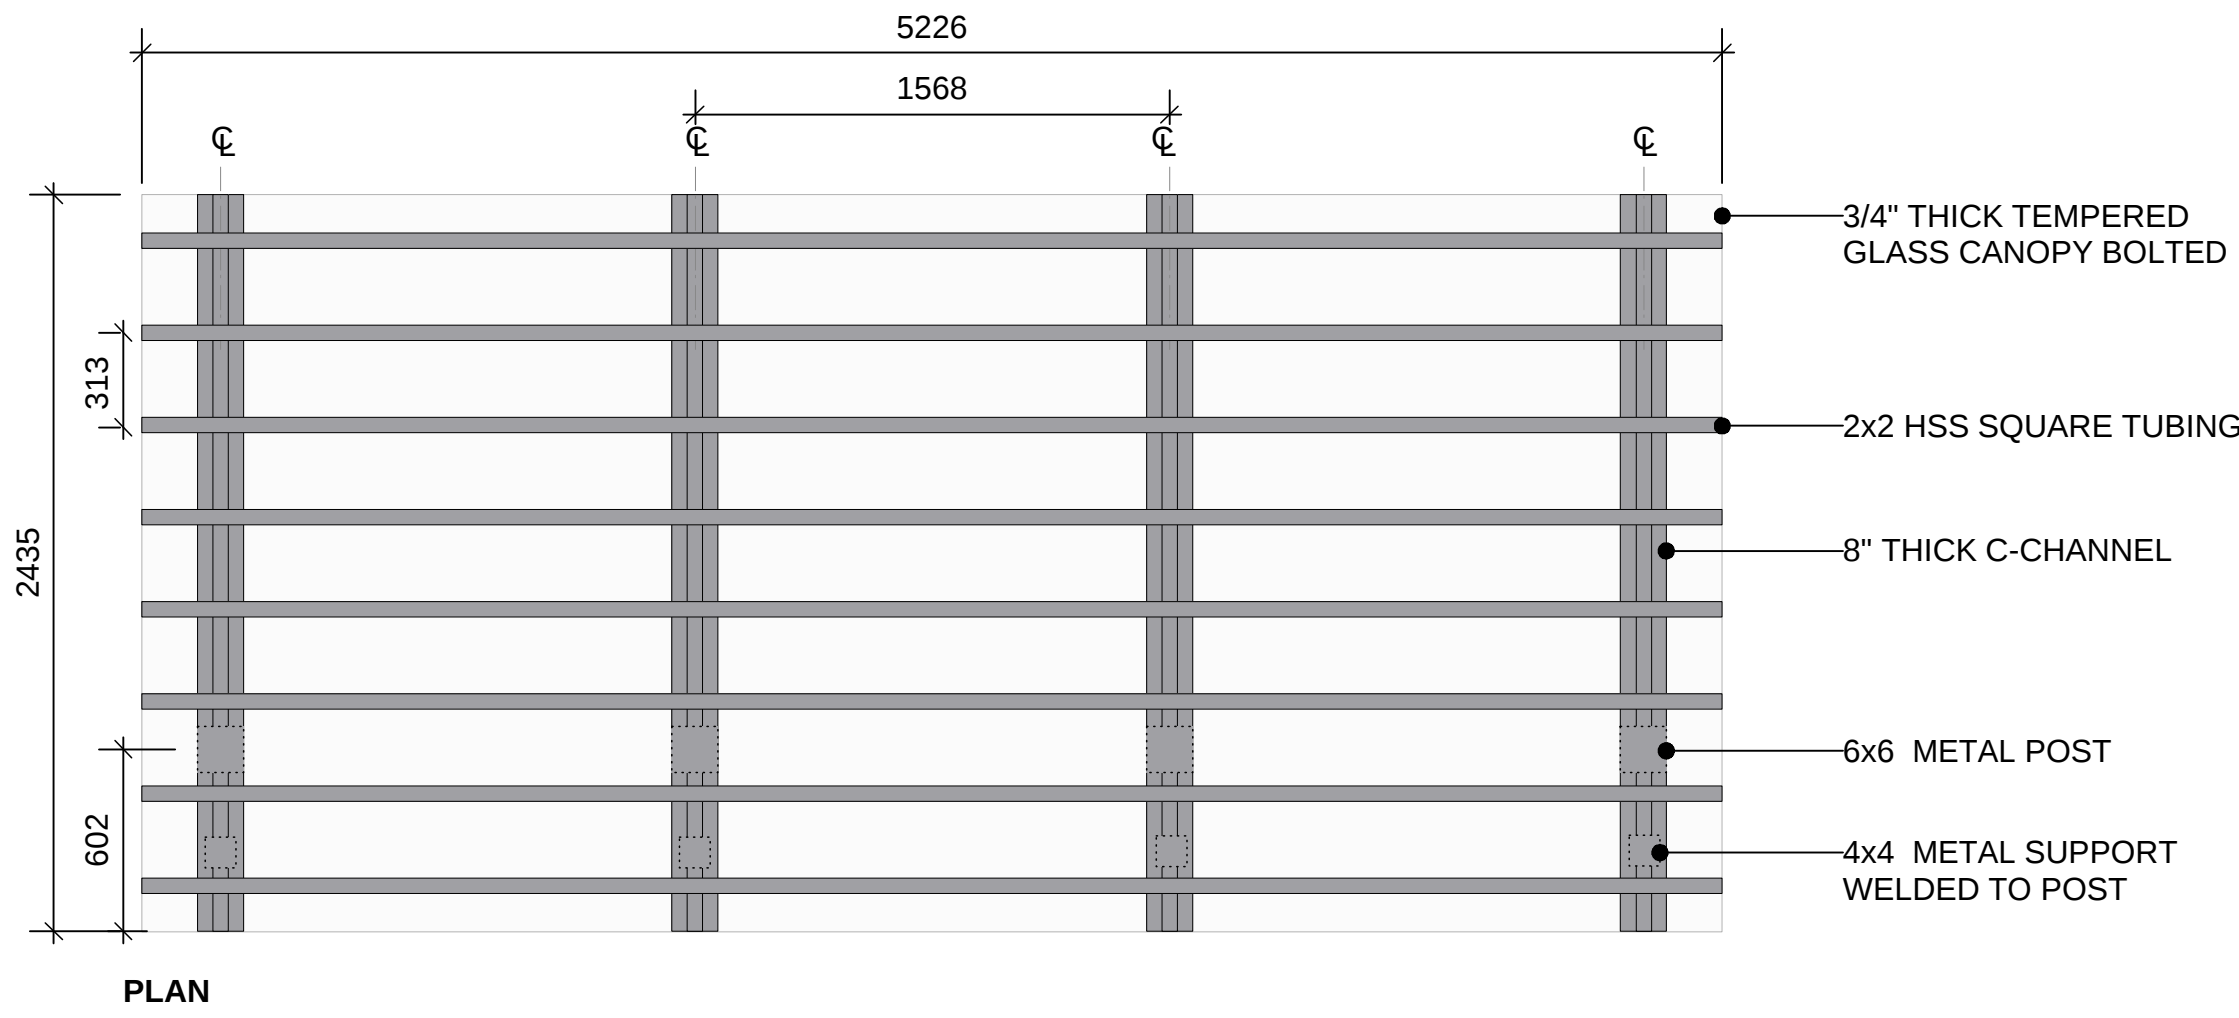


2 BIKE RACK
Scale: 1:10

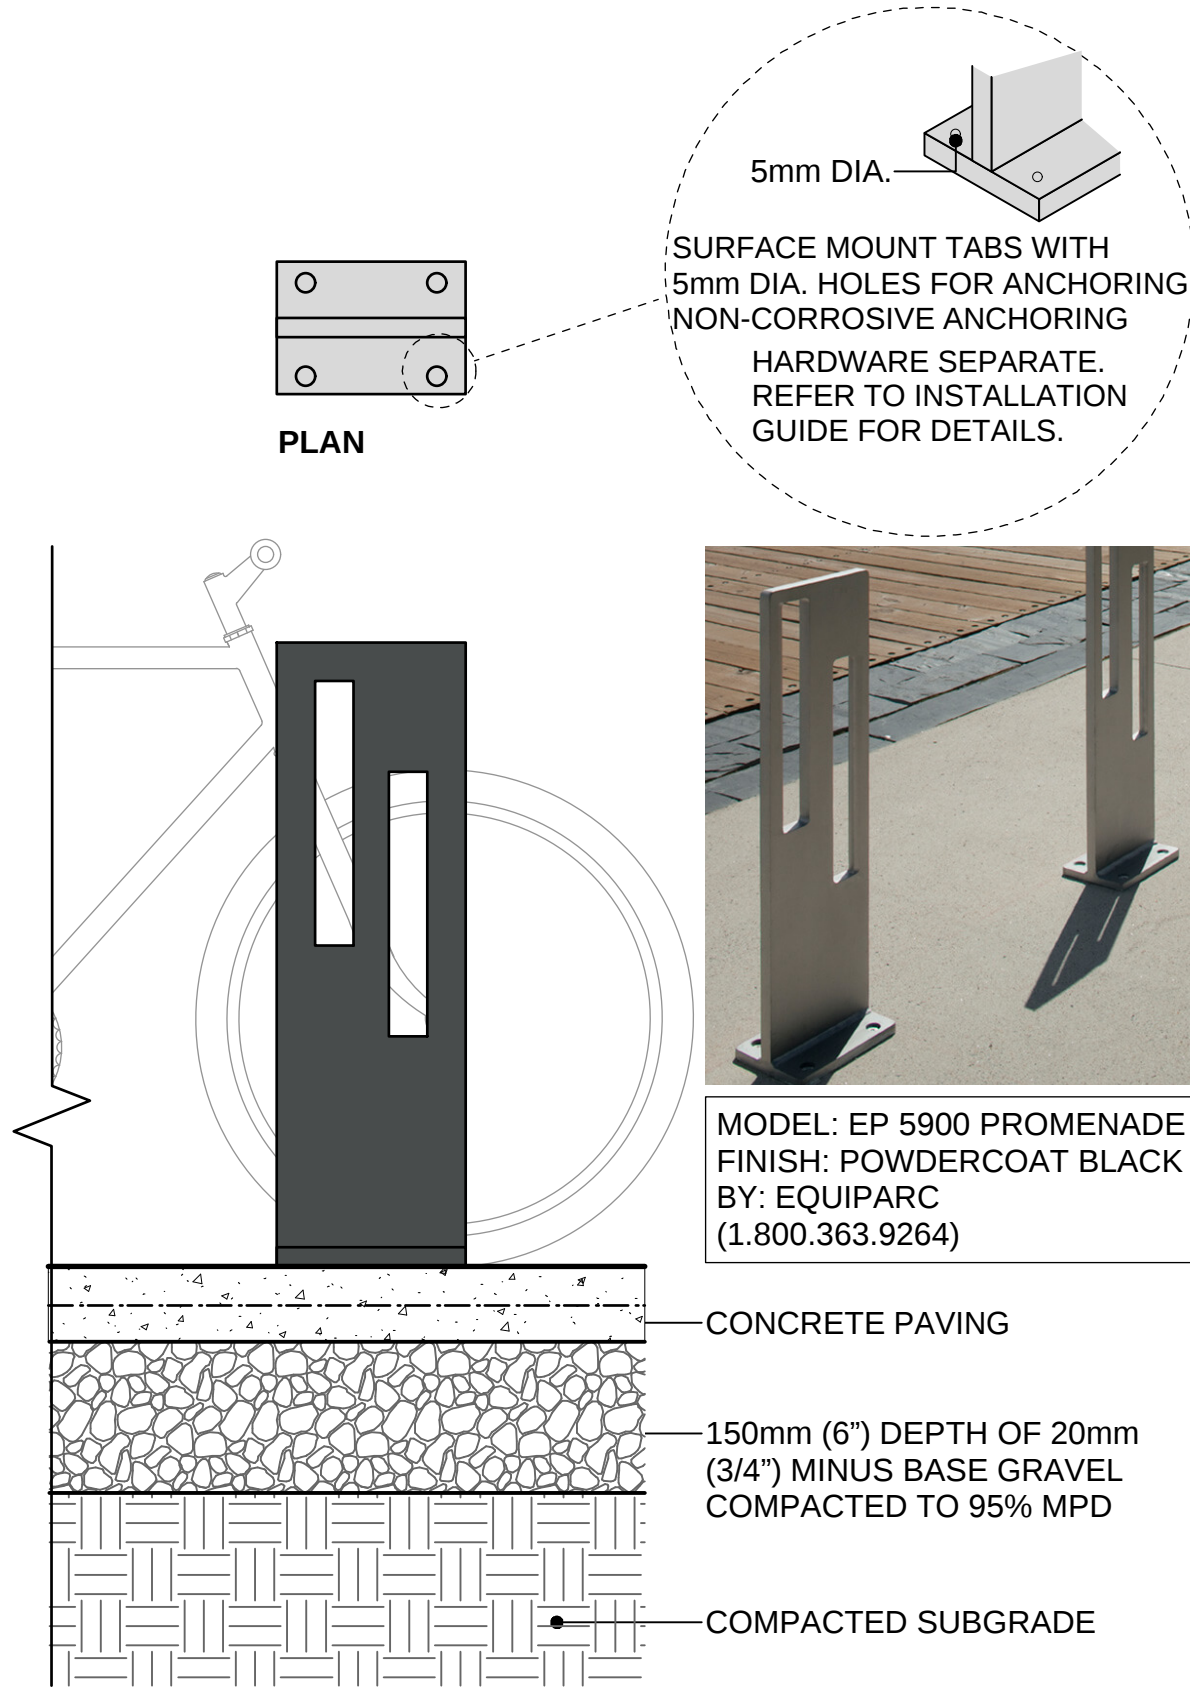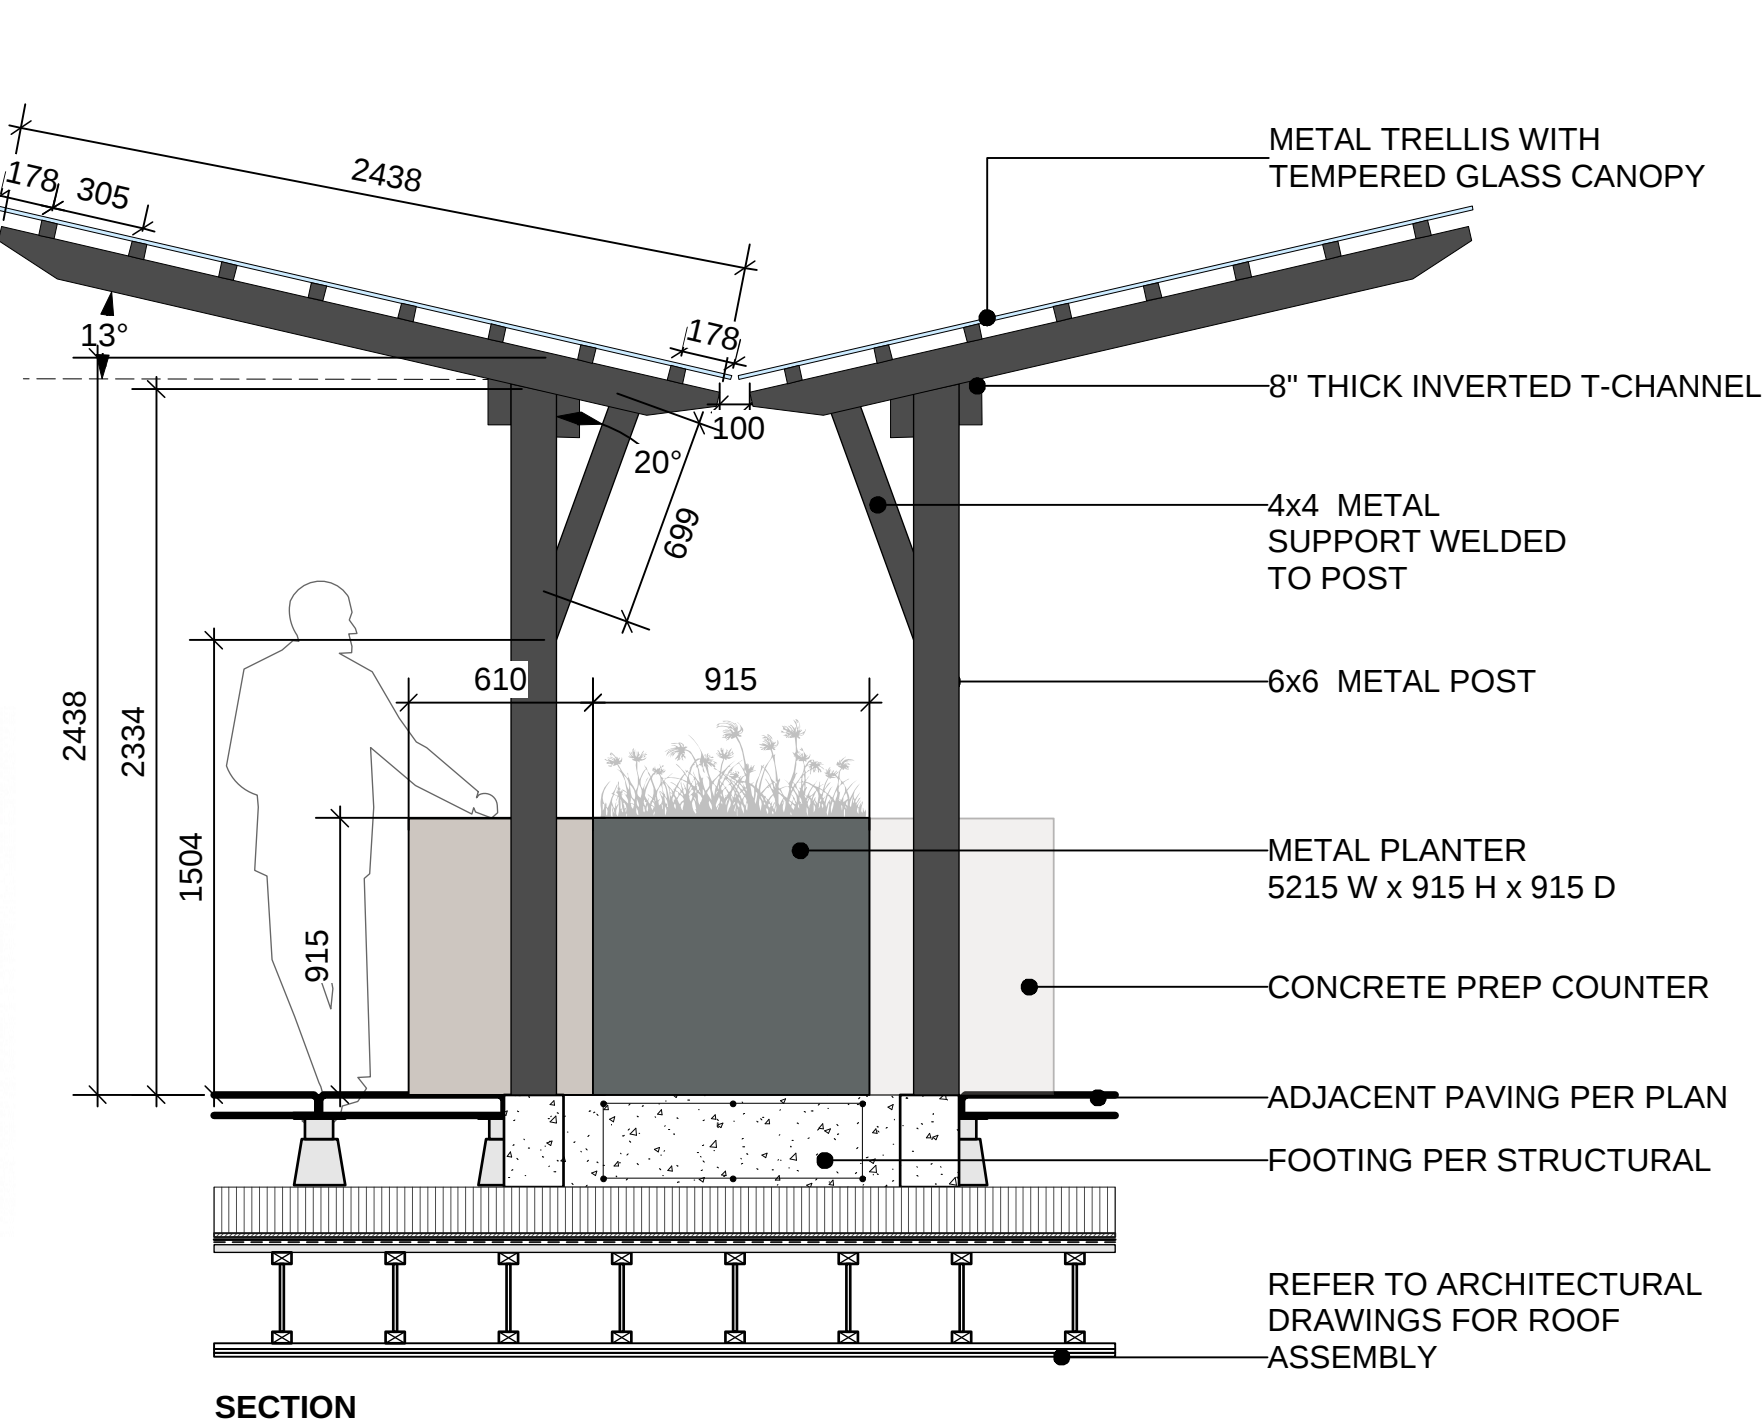

2 CUSTOM TIMBER BENCH
Scale: 1:10

- TIMBER NOTES:**
1. LUMBER TO BE PRESSURE-TREATED CEDAR, CLEAN NO KNOTS.
 2. ALL CUT ENDS TO BE TREATED WITH PRESERVATIVE.
 3. ALL EXPOSED WOOD TO BE SMOOTH AND SPLINTER FREE.
 4. ALL CUTS TO BE SQUARE AND CLEAN.
 5. ENSURE POSITIVE DRAINAGE FROM TOP FACE OF BENCH; NO DEPRESSIONS PERMITTED
 6. WOOD DIMENSION ARE NOMINAL UNLESS NOTED ON DRAWINGS.
 7. ALL METAL FASTENERS TO BE HOT PITTED GALVANIZED TO G185 OR APPROVED EQUAL FOR PRESSURE-TREATED WOOD.
 8. APPLY 2 COATS BOILED LINSEED OIL FINISH BEFORE CONSTRUCTION TO ENSURE ALL EDGES ARE FINISHED PRIOR TO ASSEMBLY.

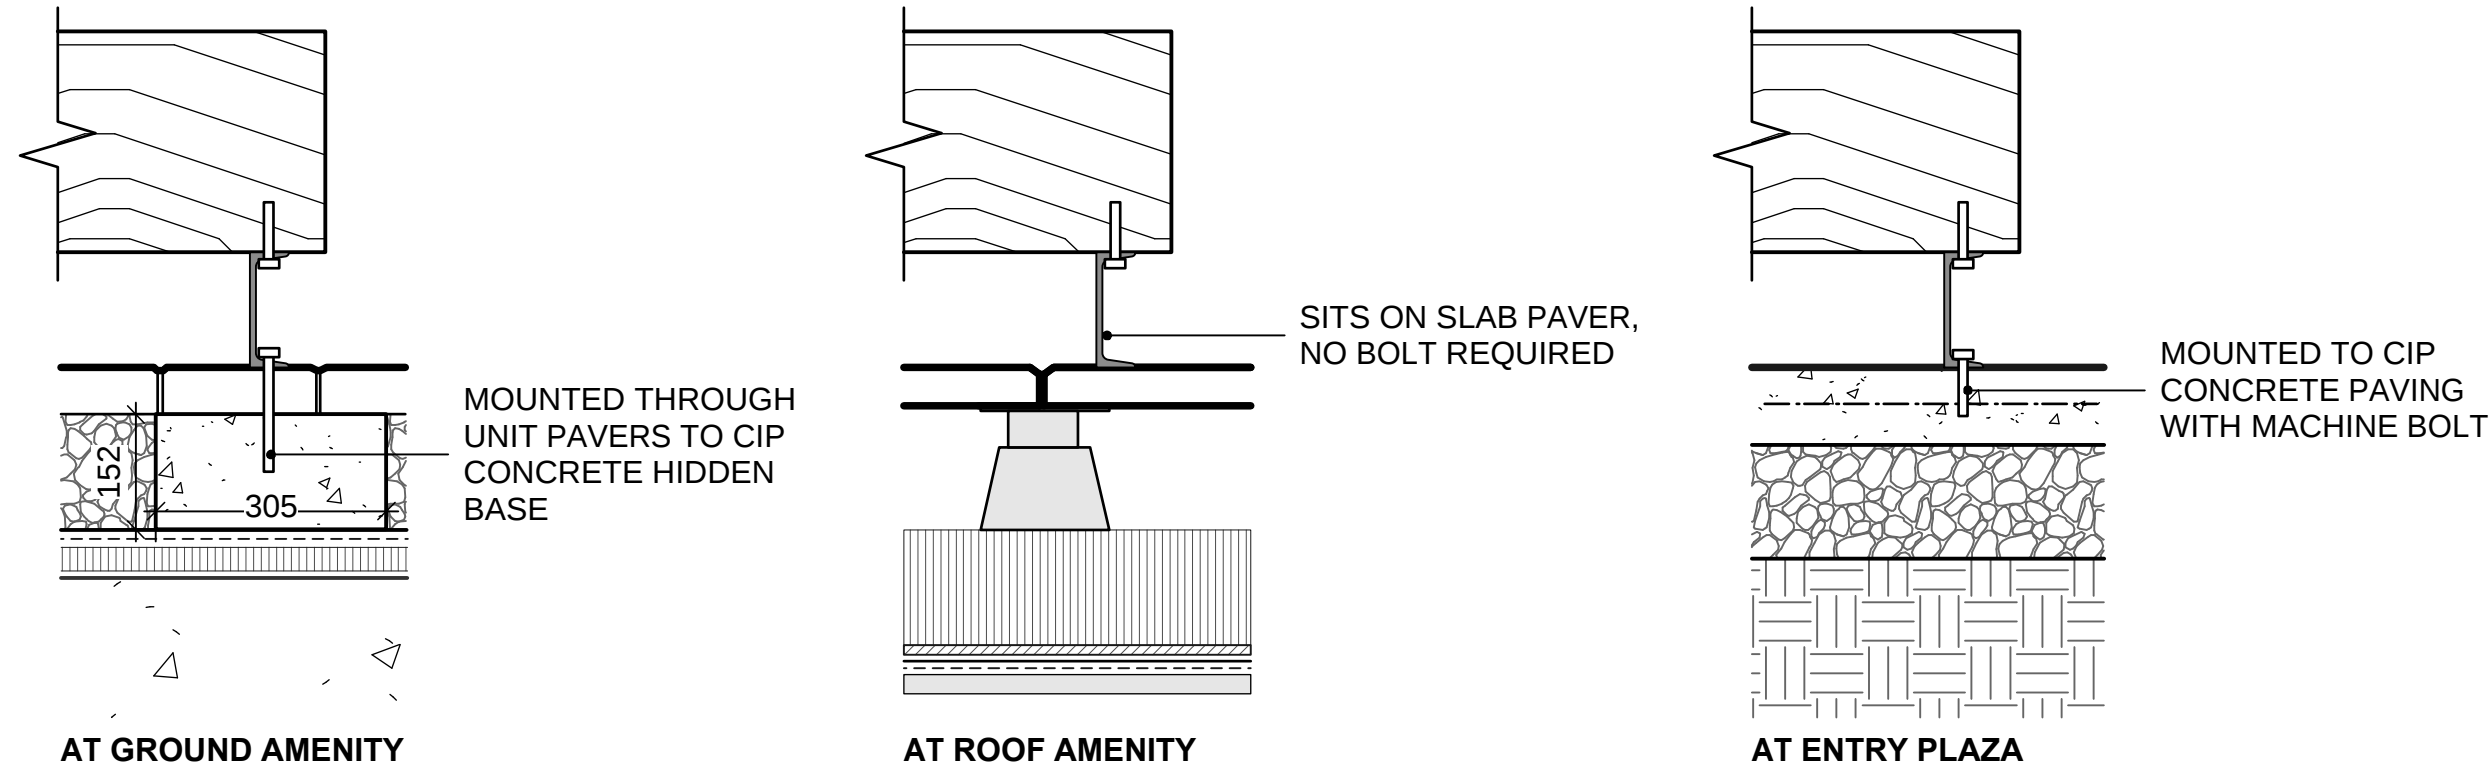

2A C CHANNEL ATTACHMENT
Scale: 1:10

ALBERT STREET

2025 Saint Johns Street
Port Moody, BC

Scale:	AS SHOWN
Drawn:	KD
Reviewed:	DS
Project No.	06-653

**LANDSCAPE DETAILS
FURNISHINGS**

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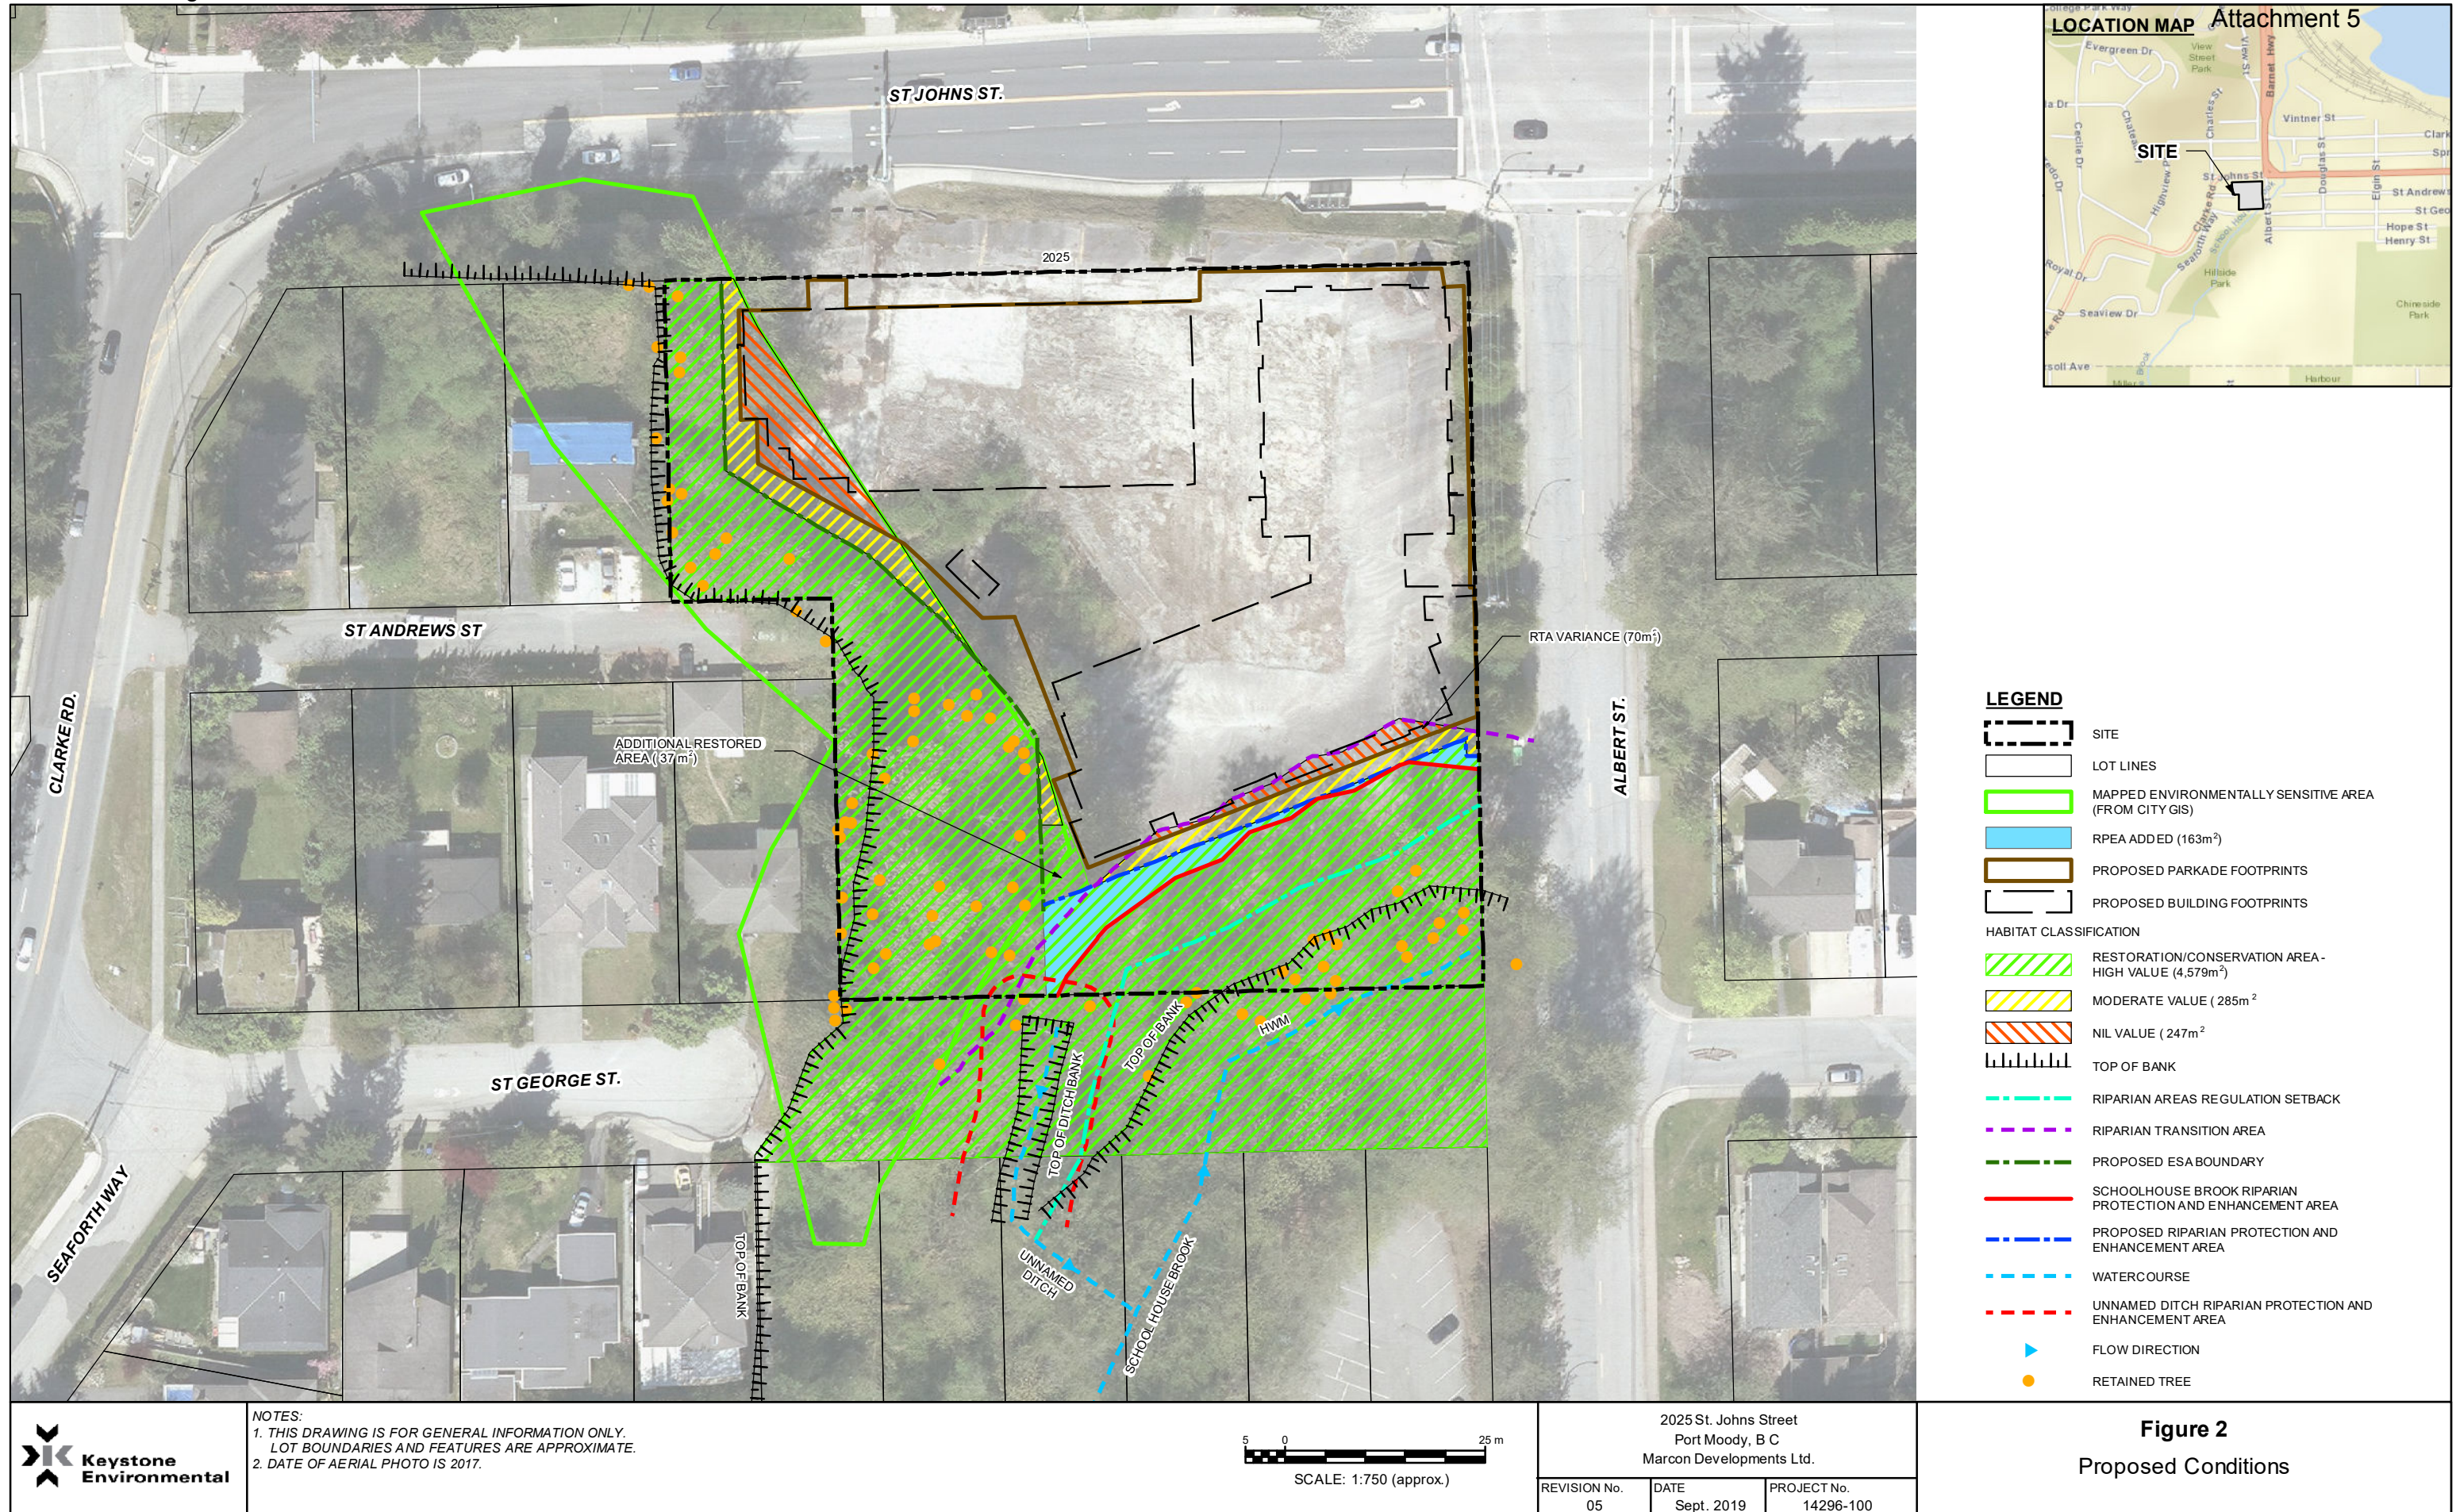
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2025 Saint Johns Street
Port Moody, BC

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LANDSCAPE DETAILS

ROOF PLANTERS



MARCON.CA

T 604.530.5646
F 604.530.51805645 – 199TH Street
Langley, BC, Canada
V3A 1H9

Doug Allan, MCIP, RPP
Acting Manager, Development Planning
City of Port Moody
100 Newport Drive
Port Moody, BC V3H 5C3

September 5, 2019

Mr. Allan:

Re: Letter of Intent, 2025 St. Johns Street – DP and Rezoning Application

Legal Description:	Lot 92, Plan 52281, District Lot 202, New West District
PID:	004-963-539

We are pleased to submit a DP and Rezoning application for the property located at 2025 St. John St. The site is situated at the southeast quadrant of the intersection of Albert St. and St. Johns, is approximately 2 acres in size and is currently zoned C5 Commercial.

The project is compliant with the OCP designation of Mixed Use – Moody Centre and has been designed within the context of the CRM2 Six-Storey Mixed Use zone. The proposed consists of 2 six-storey wood-frame buildings over a common parkade, and includes 242 condominium residential units and 7,927 sf of commercial space at the ground level. The Floor Area Ratio (FAR) is 2.23 based on a net floor area of 194,195 sf, accounting for the exclusion of indoor amenity space and an adaptable allowance of 2.0m² per adaptable unit. A design rationale has been provided by the Shift Architecture and attached as Appendix 1.

An initial iteration of the plan, generally consistent with the current configuration, was reviewed with staff in September of 2018. The current proposal incorporates the comments provided by staff and discussion at the September 5th meeting.

Affordable Housing

In addition to the CAC contribution for affordable housing, this project will provide 22 market rental units to further augment the City's rental supply. The rental tenure of these units will carry a term of 20 years.

Consistent with Marcon's previous projects in Port Moody, a 'locals-first' initiative will be employed to provide Port Moody residents with first opportunity to purchase before opening to the wider-public.

A Housing Agreement preventing future strata's from enacting rental restriction bylaws or regulations will be provided.

Commercial

Recognising the aspirations of the OCP Westport Study Area to provide locally serving commercial and employment space, retail and office has been included at the ground level fronting St. Johns St. and Albert St. The corner location provides good visibility to the busy intersection and provides for an appropriate urban-oriented pedestrian interface. The grade slopes up along both the west and south frontages of the site where the land use transitions to residential.

A total of 7,927 sf of commercial has been included, with one-third of the space being designated as office use. The composition and size of the commercial space reflects what is considered to be appropriate for marketable space and given traffic and access considerations.

Setbacks

In accordance with the CRM2 zone, the site design incorporates near-zero lot line setbacks for the commercial portion of the building. In order to provide a comfortable pedestrian realm for the commercial frontages, awnings have been included and which encroach on the City right-of-way. We anticipate a typical canopy encroachment covenant to be registered on title to accommodate this.

Setbacks increase to 3.0m measured from the building face for residential above the commercial and the street fronting homes. To meet the intent of the DP Guidelines for building form, balconies extend out from the building face so that the setback to the balcony face is reduced and overall massing reflects the desired urban character.

Environment

The site is located adjacent to Schoolhouse South Creek which crosses the far southeast corner of the property. It is also partially within the High Environmentally Sensitive Area (ESA) attributed to the steeply sloped, treed area that extends beyond the western edge of the property. In total, the project contributes nearly one-third (2,900m²) of the total site as high-value environmental area. In addition, another 1,600m² of off-site riparian area will be improved through invasive removal.

Setbacks from Schoolhouse South Creek have been established at a minimum of 15 metres for the Riparian Protection Enhancement Area (RPEA) in accordance with the Zoning Bylaw for this watercourse. As identified in the Keystone Environmental report, the stream setback exceeds the Riparian Area Regulations setback.

A setback variance is being requested for the 5m Riparian Transition Area (RTA) based on earlier discussion with Staff, and on the basis of a net increase in high-value riparian/ESA areas being provided. The variance occurs where foundation wall overlaps the RTA which occurs only at the centre point of the arched setback line and represents an area of just 70m². This is offset by the increase of higher valued RPEA of 163m² which will be restored and protected from future disturbances.

The project's RPEA and ESA balance of accounts is positive, High-Value ESA is provided through restoration measures and additional preservations. Of particular importance is the increased RPEA setback at the southwest corner of the building which will be preserved as a 'no touch' area protected by a RPEA fence. In addition, restoration measures are being proposed through the ravine area within the St. George right-of-way and directly south of the site.

Lastly, Salmon Safe Certification is being pursued to provide a third-party confirmation that the project meets their standards for environmental stewardship and stormwater management. As noted in the attached letter, Salmon Safe has conducted their initial review of the project and found that it is a good candidate for certification. This would likely make this the first residential development to be certified in BC. Attached to this letter as Appendix 2 is the initial review letter provided by Salmon Safe.

Public Art

Public art is identified in the OCP and DP Area Guidelines as an important consideration particularly for sites which are situated prominently at the entrance to the City and have the potential to incorporate an identity feature. In recognition of the site's 'gateway' location, a significant piece of public art has been integrated into the south façade so as to be prominent when entering the City from the south via Barnet Highway.

In addition to the façade, a second piece of public art is proposed to be located at the northwest corner of the site at the intersection of Albert and St. Johns St. This piece, located within the public realm, plays on the City's rich heritage housing vernacular with an abstracted house form. The trellis façade and house both utilise the same materials of square tube aluminum and coloured glass to relate to one another.

The artist's public art proposal, included with this submission, provides a more in-depth discussion of their influences and considerations for the piece. Ballard Fine Art Consultants have been retained to manage the process and implementation. In accordance with the Public Art Policy, the budget for the work is set at \$200,000 based on 0.5% of construction cost.

Amenity Space

A number of amenity spaces have been incorporated into the project to accommodate a wide range of resident activities. At the ground-level 615 sf of indoor space and 2,864 sf outdoor space is provided and includes a gym, meeting room, seating and lounge areas, an open turf area and a children's play space.

On the 6th floor a large 1,364 sf amenity room is provided along with kitchen and dining spaces seating area and activity space. Connected to the indoor space, located on the roof of building 2 is a 4,000 sf roof top amenity space. The outdoor area has been carefully programmed to provide entertaining spaces, outdoor barbeque and dining areas, lounge space and community garden beds.

In total, the building provides over 9,100 sf (848 m²) of amenity space for the residents use. This represents 3.5 m² per dwelling unit exceeding the Bylaw requirement of 3.0 m² per unit.

We look forward to receiving your feedback on our proposal. Please do not hesitate to contact me with any questions on the enclosed during the review process.

Sincerely,

Nic Paoletta

Director of Development

MARCON

APPENDIX 1 – DESIGN RATIONALE

September 6, 2019

The City of Port Moody
100 Newport Drive
Port Moody, B.C. V3H 5C3

Attn: Doug Allan
Acting Manager, Development Planning

Dear Mr. Allan:

**Re: 2025 Saint Johns Street , Port Moody
Architectural Design Rationale**

Further to the success of our previous projects within the City of Port Moody with Marcon Developments, we are pleased to be have been retained to provide Architectural services for the above-mentioned site. One of the primary focusses of our involvement in this project will be the successful integration of the development within the changing urban fabric of your community. Key to this integration is the architectural expression of the development. With proceeding in mind, we wish to formally submit the following design rational for this prominent gateway location.

SITE

The proposed development is located on a vacant site at the western edge of Port Moody's, Moody Centre neighbourhood, at the intersection of the Barnet Highway and St. John's Street. The site was the former location of the Barnet Hotel which has been previously demolished.

The site is bounded by St. John's Street to the north, by Albert Street and urban forest to the east, Schoolhouse Creek South and urban forest to the south, and steeply sloping urban forest to the west. Immediately south of the site and Schoolhouse Creek, is Port Moody Secondary School. To the west of the urban forest of the site are existing single-family residences. The site is effectively separated from the adjacent urban fabric by the natural forested boundaries to the west, south and east, while the arterial nature of St. John's provides a significant separation from properties to the north.

ARCHITECTURAL EXPRESSION

Given the gateway location of the site, the project seeks to elevate the architectural expression of the development in order create a memorable western entry into Port Moody center. This memory is firmly established by the interplay of multiple colourful glazed guards that populate the north and east facades of the project. These colourful panels, change with the day as the capture, reflect or cast coloured light onto the immediate surroundings.

Upper residential levels of the development sit upon a well-defined commercial base which is located at the intersection of Albert and St. John's Streets. The commercial base is rendered in masonry which contrasts the corrugated metal cladding of the upper residential levels. The extent of this commercial occupancy is limited by the slope of the

Shift Architecture Inc

200 – 1000 West 3rd Street
North Vancouver, BC V7P 3J6

tel 604 988 7501
fax 604 988 7510

info@shiftarchitecture.ca
shiftarchitecture.ca

PRINCIPAL

Cameron Halkier
Architect AIBC,
MRAIC

The logo for Shift Architecture Inc. features the word "SHIFT" in a bold, sans-serif font. The letter "I" is stylized with a vertical line through it, and the "T" has a horizontal bar that extends to the right.

site in both the north/south and east/west directions. A glazed canopy wraps the commercial frontage, serving to further define the base while providing cover for those accessing the three commercial units. The masonry base is extended the full length of the development on both the east and north elevations by utilizing brick for the landscape walls. The expression of a strong base for the development is further accentuated by recessing and darkening the lowest level of the northern building.

Residential levels of the buildings are rendered in corrugated metal cladding with composite metal accent panels and glazed guards, both clear and coloured. The corrugated cladding is purposefully light in colour to maximize the effect of light reflections that emanate from the coloured glazing. The coloured guards and accent panels are playfully arranged to achieve interest. Each building is capped with a projecting eyebrow that provides cover for the residential balconies.

The public expression of the Architecture is consistent and extends from the riparian area at the southern boundary of the site, north to the intersection of Albert and St John's Streets and westward to the urban forest at the western edge of the property. On the less public, forest facing or internal elevations, coloured accent panels are used to create interest rather than the coloured guards of the more public, street facing facades.

Public artwork for the project is being developed by Alex Morrison. The two sculptural pieces are located within the recess on the north elevation of Building 2 and within the small plaza at the corner of Albert and St. Johns Streets.

Amenities for the development include the triangular, residential courtyard which is enclosed by the two buildings and the urban forest of the hillside. This courtyard provides both common gathering and play spaces as well as individual yards for those units that open directly to it. A small meeting room within the Building 2 opens onto the courtyard and a resident gym is located at the west end of Building 1. A large amenity room on the upper level of Building 2 is also provided. This large amenity room provides access and connects with the generous public roof deck which extends the full length of the north wing of Building 2.

Throughout the proposed development, high quality, durable materials are specified. Brick, corrugated metal siding, composite metal panels, wood-like soffits and glazed guards are carefully composed to achieve the fresh, contemporary, playful expression of the Architecture.

In conclusion, we are excited to be involved with this project and contributing to the development of your growing and changing community. Should you have any questions or require further information regarding this project, feel free to call me at (604) 988-7501

Sincerely,

Cameron Halkier Architect AIBC, MRAIC
Principal

APPENDIX 2 – SALMON SAFE



1001 SE Water Ave.
Suite 450
Portland, OR 97214
503.232.3750
f 503.228.3556

August 2, 2019

Tim Schmitt
Marcon Developments Ltd.
5465 – 199th Street
Langley, BC, V3A 1H9

Dear Tim:

This letter serves to summarize the Salmon-Safe pre-assessment design review that has been conducted for the Albert Street development as well as to provide an overview of Salmon-Safe's urban certification program.

Salmon-Safe BC is one of Canada's first eco-certification programs that recognizes and promotes environmentally friendly land and water management practices that minimize impacts on water quality and aquatic biodiversity. Salmon-Safe provides expert guidance for developers, landowners and property managers interested in demonstrating environmental stewardship that helps to protect salmon health and habitat. Building off of the success of Salmon-Safe US, the Fraser Basin Council helped to launch BC's first urban certification program, Salmon-Safe Communities in 2013.

Salmon-Safe's peer-reviewed standards and rigorous on-site inspections provide independent validation of environmental performance, as well as a framework to inform ongoing operations. Salmon-Safe's high visibility media outreach and communication campaigns provide public recognition to certified sites, building their reputation for excellence in environmental stewardship and efforts to go beyond regulatory compliance. Salmon-Safe Certification is valid for a 5-year period and entitles the certified institution to display the Salmon-Safe logo and incorporate Salmon-Safe messaging within internal and external communications.

As a first step in the certification process for the Albert Street Development, Salmon-Safe conducted a review of current drawings and completed a memo summarizing our findings on July 23, 2019. Our overall impression of the project is positive and that it's a good candidate site for Salmon-Safe certification. Specifically, the approach to stormwater management appears to emphasize on-site treatment to the maximum extent feasible, the design improves ecological function both in vegetation and in the RPEA, water conservation is prioritized, and a plan for long-term monitoring and maintenance of the stormwater system has been drafted.

We look forward to getting to know the project in greater depth as the design and certification processes move forward.

Kind regards,

Anna Huttel
Certification Manager

Cc: Dan Kent, Executive Director
Theresa Fresco, BC Program Manager

Mixed-Use Sustainability Report Card

Purpose

The Sustainability Report Card recognizes that developers, builders, designers, and others proposing changes to the built environment have an important role in creating a sustainable community. Sustainability involves stewardship of land and environmental resources, as well as green building and a focus on design elements that bring people together and help communities flourish economically, socially, and culturally. Port Moody encourages innovative thinking in community design to achieve a more sustainable community.

To this end, the Report Card is a requirement for rezoning, development permit, and heritage alteration permit applications. The Report Card identifies performance measures based on community sustainability values: these measures are used to evaluate development proposals. The Report Card is intended to be a summary of overall project sustainability. It is a tool to be integrated with all other development approval requirements.

Process

There are six steps to follow in completing the Sustainability Report Card process:

1. Make a development inquiry to Development Services regarding your proposed rezoning, development permit, or heritage alteration permit. Staff will provide you with a hard copy of the Sustainability Report Card and provide a weblink to portmoody.ca/SRC where you can find a fillable PDF version of the Report Card.
2. Attend a pre-application meeting with City staff to discuss your proposal. The Planner will determine if the Sustainability Report Card is a document that must be submitted with your application.
3. If required, complete a Report Card by filling in the appropriate information that applies to your particular application and submit the completed Report Card (saved version of online fillable PDF or hard copy) to the appropriate City staff (sustainabilityreportcard@portmoody.ca or deliver to City Hall Planning Department at 100 Newport Drive), along with a completed land use application.
4. The Planner will review the Report Card for completeness and accuracy and forward to staff in various departments for feedback. The Planner will determine your preliminary score and discuss the results of the staff review with you. You will then have an opportunity to improve your score with respect to the sustainability of your proposal and resubmit an updated Report Card.
5. The Planner will make comments, determine your final score, and prepare the Project Report Card Summary. The Summary will be included in the land use reports that are distributed to the Advisory Design Panel, Community Planning Advisory Committee, and Council.
6. If your application is approved by Council, your final Report Card is maintained in the development file and a copy is provided to the City's Building Division.

Instructions

- Your Report Card must contain sufficient detail to ensure each measure can be evaluated. To do this, make reference to the appropriate plans, drawings, and reports that demonstrate how the performance measure is met.
- The relevance of the questions will depend on the nature and scope of your project, so not all questions will be applicable to all projects.
- Some measures are marked 'EARLY STAGE'. This indicates that these measures must be considered in the design phase as it is unlikely they can be added to a proposal later on.

Italicized words are in the Glossary at the back of this document.

- Similarly, some measures are marked 'BASELINE'. Although the Report Card is not a pass or fail test of development applications, it does set a minimum score to indicate the City's minimum expectations. Items labelled 'BASELINE' count toward a minimum score as they are considered to be low cost and readily achievable.
- Italicized terms are defined in the Glossary at the end of the Report Card document.
- Refer to the Resources section for links to Internet resources relevant to measures in the Report Card.

Scoring

- Performance measures are assigned weighted scores from 1 to 10 to indicate their significance based on: (1) level of difficulty to integrate into project design; (2) order-of-magnitude cost added to the project; (3) degree of effectiveness for increasing the overall project sustainability; (4) identified community priority in the Official Community Plan; and (5) level of urgency for Port Moody in terms of achieving community sustainability goals.
- City staff score the completed Report Card based on the principle of best achievable on each site for each performance measure. Where possible, points for achieving various means are indicated. In other cases, the number of means to achieve a performance measure may exceed the total points possible for an item. In this case, the Planner will make a fair assessment of the project's performance for this measure with respect to the conditions of the site as a percentage and translate this to the possible score.
- Only whole number scores will be assigned. This will be achieved by rounding to the nearest whole number. For example, if overall performance for a measure is deemed to be about 80 per cent and the possible score is out of 4, then a score of 3 points out of 4 will be assigned.
- The Report Card is an iterative process with the applicant. The applicant has an opportunity to comment and make changes to their proposal before the scores are considered final and shared with public advisory bodies and Council.
- Additional space is provided for the applicant to address innovations and constraints not captured elsewhere in the Report Card. These items are not scored, but are given specific mention on the Project Report Card Summary.
- Staff will review your completed Report Card and provide feedback before your project is scored to give you the opportunity to achieve the highest score possible.

Monitoring

In general, the information required from the applicant for the Sustainability Report Card is similar to the kind of information required for a typical development application. However, to ensure accountability, you can expect the City to request additional information, such as: photos of installed systems or products, design drawings, professional reports, copies of receipts, or other records that can be used to verify the implementation of the selected sustainability measures. We encourage you to provide as much information as possible to assist City staff in their review of your development proposal.

Public Information

The public may request a review of any completed Report Card related to a development application. Copies of the Report Card are maintained by the Planning Division. The Development Services Department makes Report Cards available following completion of the project.

Property and Applicant Information

Applicant Marcon Albert (GP) Ltd.	Telephone 604.530.5646	Email tschmitt@marcon.ca
Registered Owner Marcon Albert Properties Ltd.	Project Address 2025 St. Johns Street	
Proposed Use Mixed-use, Residential Multi-family and Commercial		

Total Floorspace **18507** m²

CULTURAL SUSTAINABILITY SECTION*How will the project contribute to Port Moody's status as 'City of the Arts'?***Arts****Performance Measure Description and Scoring**

C1

Project includes public art in publicly accessible or publicly owned space (3 points, +1 bonus point if a Public Art Consultant is used).
OR Project provides an in lieu financial contribution to the City's Public Art Reserve Fund (3 points).

See links in Resources under "Examples of Good Public Art".

Applicant Explanation and Reference to Plans, Drawings, and Reports

If **yes**, describe:

The project provides two pieces of public art. The first will be installed on the site in advance of any construction activity taking place on site, and is intended to provide a prelude of the project to come. This piece will be relocated to a public location when the building completes.

The second and primary public art component is a structure that will be located on the north face of the building and will be highly visible from the intersection.

Public Art Consultant:
Ballard Fine Art.

Plan reference:
Public Art Brief

Staff Comments

Bonus Score /1

Score /3

CULTURAL SUSTAINABILITY SECTION*How will the project contribute to Port Moody's status as 'City of the Arts'?***Arts****Performance Measure Description and Scoring**

C2

Project supports Port Moody's desire to be a "City of the Arts" by integrating artistic design into the site or building form or functionality (2 points).

Examples:

- Creative stormwater management features.
- Creative interaction of the project with the public.
- Artistic panels in entry foyer.

Applicant Explanation and Reference to Plans, Drawings, and Reports

Describe:

As noted above, the building's design incorporates a significant public art piece in the north facade. The building further response to this public art component by punctuating the facade with coloured balcony railings.

Plan reference:
Alex Morrison proposal and Arch A0.00

Staff Comments

Score /2

CULTURAL SUSTAINABILITY SECTION *How will the project contribute to Port Moody's status as 'City of the Arts'?***Heritage****Performance Measure Description and Scoring**

C3 Project includes reusing an existing heritage structure with heritage value through *heritage restoration* or *heritage rehabilitation* (4 points).

Where the preservation of a heritage structure in its original location cannot be accommodated, this may include re-location.

See *Standards and Guidelines for the Conservation of Historic Places in Canada*: historicplaces.ca

Applicant Explanation and Reference to Plans, Drawings, and Reports

Describe:

Does not apply, no heritage building or structures remain on the site.

Staff Comments

Plan reference:

Score N/A /4

CULTURAL SUSTAINABILITY SECTION *How will the project contribute to Port Moody's status as 'City of the Arts'?***Heritage****Performance Measure Description and Scoring**

C4 Project includes a *statement of significance* prepared by a heritage conservation specialist where potential heritage value is observed (2 points). Where warranted, project includes a heritage conservation plan prepared by a heritage conservation professional (+2 bonus points, where applicable).

See *Standards and Guidelines for the Conservation of Historic Places in Canada*: historicplaces.ca

Applicant Explanation and Reference to Plans, Drawings, and Reports

Report title:

Does not apply.

Staff Comments

Heritage Consultant:

Bonus Score N/A /2

Score N/A /2

CULTURAL SUSTAINABILITY SECTION*How will the project contribute to Port Moody's status as 'City of the Arts'?***Heritage****Performance Measure Description and Scoring**

C5

Project salvages materials or artefacts from a historic place, or reuses materials or artefacts from architectural/landscape salvage in a manner which supports the authenticity of the site's *character-defining elements*.

Applicant Explanation and Reference to Plans, Drawings, and Reports

Details:

The public art makes reference to the City's heritage and the single-family housing typology that the area has been known for.

Plan reference:

Staff CommentsScore /3**CULTURAL SUSTAINABILITY SECTION***How will the project contribute to Port Moody's status as 'City of the Arts'?***Arts****Performance Measure Description and Scoring**

C6

Project designates space for the arts or creative enterprise to be retained for the lifetime of the project.
Ex. artist studio, gallery space, dance studio, indoor/outdoor theatre, live-work units, plaza, etc.

Applicant Explanation and Reference to Plans, Drawings, and Reports meters² / feet²

Description of space:

Staff CommentsScore /4

CULTURAL SUSTAINABILITY SECTION *How will the project contribute to Port Moody's status as 'City of the Arts'?***Complete Community Elements****Performance Measure Description and Scoring**

C7 Project improves the *streetscape* beyond minimum City requirements by integrating lasting creative elements and demonstrating effort to optimize the project's *beautification* impact.

Examples:

- Restores the frontage of an existing building in Historic Moody Centre.
- Proposes artistic paving treatments in the public realm.
- Adds creativity to functional elements of the *streetscape*.
- Benches, bike rack, planter, lighting, etc. upgrades.

Applicant Explanation and Reference to Plans, Drawings, and Reports

Details:

The vibrant colours and unique design of the building which incorporates public art in the facade will greatly improve the quality of the streetscape. The building design was driven by the site's location at a prominent 'gateway' intersection. The pedestrian realm will be improved with the introduction of commercial and ground-oriented residential fronting the street. In addition, the new sidewalk, street trees, wider boulevard, and multi-use pathway improvements will provide a more pedestrian oriented street frontage.

Plan reference:

L1.0, A0.00, A0.031

Staff Comments

Score 1 /2

CULTURAL SUSTAINABILITY SECTION *How will the project contribute to Port Moody's status as 'City of the Arts'?***Heritage****Performance Measure Description and Scoring**

C8 Project will apply to be added to the City's Heritage Register.

Applicant Explanation and Reference to Plans, Drawings, and Reports

☐ Yes ☐ No ☒ N/A

Details:

Staff Comments

Score N/A /3

CULTURAL SUSTAINABILITY SECTION*How will the project contribute to Port Moody's status as 'City of the Arts'?***Innovation****Performance Measure Description and Scoring**

C9 Cultural sustainability aspects not captured above.

Applicant Explanation and Reference to Plans, Drawings, and Reports

- Internal plaza space has been designed to work with the adjacent hillside.
- The childrens' play area utilises the slope as an interactive play feature.
- Making use of the rooftop amenity space's good sun exposure, community garden beds have been provided for growing food.
- Restoration, preservation and protection of the Schoolhouse Creek riparian area and the Environmentally Sensitive Area bank on the west.

Staff Comments**CULTURAL SUSTAINABILITY SECTION***How will the project contribute to Port Moody's status as 'City of the Arts'?***Constraints****Performance Measure Description and Scoring**

C10 Unique site aspects that limit cultural sustainability achievement.

Applicant Explanation and Reference to Plans, Drawings, and Reports

The site is constrained on the south by the setback and riparian area and on the west by the ESA. These two environmental preservation areas, while important for ecology, limit the space available on-site for more cultural, arts and performance space.

Staff Comments**Cultural Sustainability Score Summary****Total Cultural Pillar Points (Total Points Available – Not Including Bonus Points)****Score**

23

Total

Total Cultural Points Not Applicable

(Total Points for Items Not Relevant to this Application)

9

n/a

Maximum Achievable Score

(Total Cultural Pillar Points Minus Total Cultural Points Not Applicable)

14

Maximum

Cultural Pillar Minimum Score

(Sum of Applicable Baseline Items)

5

Cultural Baseline

Total Points Achieved

(Total Points Achieved for Applicable Items for this Application)

7

Total Cultural Points

Cultural Pillar Score

(Total Points Achieved/Maximum Achievable Score)

7

Total Cultural Points

14

Max

50

Percent

ECONOMIC SUSTAINABILITY SECTION *How will the project contribute to a stronger local economy?***Land Use/Employment****Performance Measure Description and Scoring**

EC1 Project increases long-term employment on land designated as Industrial, Mixed Employment, or Mixed Use in the City's Official Community Plan.

See Map 1: Overall Land Use in the City's Official Community Plan: [Map 1: Overall Land Use Plan](#)

Applicant Explanation and Reference to Plans, Drawings, and Reports

Existing:	Staff Comments
Use(s): Vacant	
Number of jobs on-site relating to this use in operation: 0	
Proposed:	
Use(s): Commercial and office space	
Number of jobs estimate: 54	
Assumptions: Based on industry averages of one employee per 150sf of commercial space, the 7,927sf CRU is estimated to accommodate 54 direct jobs, not accounting for indirect or induced jobs.	

Score 2 /3**ECONOMIC SUSTAINABILITY SECTION** *How will the project contribute to a stronger local economy?***Land Use****Performance Measure Description and Scoring**

EC2 Project supports walking to shops and services by broadening the current retail/service mix within an 800m radius of the lot.

Applicant Explanation and Reference to Plans, Drawings, and Reports

Describe the diversification and how it is appropriate to this particular location: The project provides 7,927 sf of commercial space which will accommodate services and employment space that can serve the local area. This provides a live-work opportunity for people that reside in the general neighbourhood or within the development. There are a number of existing restaurants and shops and other planned developments within 800m that future residents can to walk to, particularly the Queen St. and Clarke St. retail clusters.	Staff Comments
--	-----------------------

Score 1 /1

ECONOMIC SUSTAINABILITY SECTION *How will the project contribute to a stronger local economy?***Land Use/Employment****Performance Measure Description and Scoring**

- EC3 Project provides more intensive use of land designated as Mixed Use, *Transit Oriented Development*, Mixed Employment, or Industrial in the City's Official Community Plan that will support neighbourhood businesses (where permitted/appropriate).

See Map 1: Overall Land Use in the City's Official Community Plan: [Map 1: Overall Land Use Plan](#)

Applicant Explanation and Reference to Plans, Drawings, and Reports

Existing:	Staff Comments
Building type: NA	
FSR: NA	
Proposed:	
Building type: Mixed-use, 6-storey	
FSR: 2.23	

Score 3 /3**ECONOMIC SUSTAINABILITY SECTION** *How will the project contribute to a stronger local economy?***Tourism****Performance Measure Description and Scoring**

- EC4 Project provides regional destination commercial or institutional uses such as specialized training/education, specialty retail, dining, arts, cultural, or recreational opportunities.

Applicant Explanation and Reference to Plans, Drawings, and Reports

<input checked="" type="radio"/> Yes <input type="radio"/> No	Staff Comments
If Yes, explain: Given the site's location at a 'gateway' intersection, considerable attention has been paid to creating an exciting facade. The public art will make this intersection unique and highly identifiable. The project provides an opportunity to revitalize the site and improve on its current and historic uses.	

Score 0 /2

ECONOMIC SUSTAINABILITY SECTION *How will the project contribute to a stronger local economy?***Economic Development/Energy/Materials/Water Use Efficiency****Performance Measure Description and Scoring**

EC5 Project participates in or develops an alliance between multiple, co-located uses/businesses, i.e. eco-industrial networking.

Applicant Explanation and Reference to Plans, Drawings, and Reports

Relationship results in (check all that apply): <input type="checkbox"/> Reduced energy consumption <input type="checkbox"/> Reduced water consumption <input type="checkbox"/> Reduced materials use <input type="checkbox"/> Waste reduction Other efficiency: Description: 	Staff Comments

Score /4**ECONOMIC SUSTAINABILITY SECTION** *How will the project contribute to a stronger local economy?***Land Use****Performance Measure Description and Scoring**EC6 Project redevelops and rehabilitates a *brownfield* site.**Applicant Explanation and Reference to Plans, Drawings, and Reports**

Describe: Although this is a redevelopment of a commercial site, it is not a brownfield property in that it is not contaminated with hazardous substances. The proposed site design provides considerable improvement on the existing/historical use which was predominately paved, non-permeable surface. Considerable increase in landscaped areas and stormwater detention will reduce storm flows to 50% of the pre-development condition.	Staff Comments

Score /3

ECONOMIC SUSTAINABILITY SECTION *How will the project contribute to a stronger local economy?***Innovation****Performance Measure Description and Scoring**

EC7 Economic sustainability aspects not captured above.

Applicant Explanation and Reference to Plans, Drawings, and Reports

	Staff Comments Applicant Comment: Provides much needed rental housing to support a workforce that underpins local business.
--	--

ECONOMIC SUSTAINABILITY SECTION *How will the project contribute to a stronger local economy?***Constraints****Performance Measure Description and Scoring**

EC8 Unique site aspects that limit economic sustainability achievement.

Applicant Explanation and Reference to Plans, Drawings, and Reports

	Staff Comments
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Economic Sustainability Score Summary

	Score
Total Economic Pillar Points (Total Points Available – Not Including Bonus Points)	16 Total
Total Economic Points Not Applicable (Total Points for Items Not Relevant to this Application)	3 n/a
Maximum Achievable Score (Total Economic Pillar Points Minus Total Economic Points Not Applicable)	13 Maximum
Economic Pillar Minimum Score (Sum of Applicable Baseline Items)	7 Economic Baseline
Total Points Achieved (Total Points Achieved for Applicable Items for this Application)	6 Total Economic Points
Economic Pillar Score (Total Points Achieved/Maximum Achievable Score)	6 / 13 = 46 % Total Economic Points Max Percent

ENVIRONMENTAL SUSTAINABILITY SECTION *How well does the project minimize the demands on the environment?***Site Context | Ecology****Performance Measure Description and Scoring**

- EN1 Project protects and enhances an *Environmentally Sensitive Area* (ESA) as designated on Map 13 in the City's Official Community Plan, i.e. provides positive net benefit.

See [Map 13: Environmentally Sensitive Areas](#) and [Appendix 2: Development Permit Area Guidelines](#) in the Official Community Plan.

Applicant Explanation and Reference to Plans, Drawings, and Reports

Type of ESA: <input checked="" type="radio"/> High ESA <input type="radio"/> Medium ESA <input type="radio"/> Low ESA <input type="radio"/> 30m Stream Buffer (High Value) <input type="radio"/> Special Feature (High Value)	Staff Comments
Features/Species of Value: <p>Mature forest of bigleaf maple, red alder, western hemlock, Douglas-fir and western redcedar, salmonberry, sword fern, red elderberry and lady fern. Partially compromised by invasive Himalayan blackberry and English ivy. Provides habitat for songbirds and urban-associated wildlife. Fish-bearing Schoolhouse Brook and riparian area are located at the south end of the site.</p>	
Means of Protection: <input checked="" type="radio"/> Covenant <input type="radio"/> Dedication <input type="radio"/> Monitoring <input type="radio"/> Other:	
Means of Improvement of ESA: <p>It is proposed that invasive Himalayan blackberry and English ivy will be removed and areas will be restored by planting diverse native tree and shrub species. Species planted were selected to provide a food source for songbirds and pollinators and to support riparian health. A fence will be installed around the ESA and riparian buffer to prevent encroachment. Post-restoration monitoring will be conducted to confirm ecological health.</p>	

The restoration plan goes beyond the site boundaries to include the riparian area within the adjacent road RoW. This adds 1600m² of additional restored riparian area.

Score 3 /4

BASELINE + EARLY STAGE

ENVIRONMENTAL SUSTAINABILITY SECTION *How well does the project minimize the demands on the environment?***Site Context | Ecology****Performance Measure Description and Scoring**

- EN2 Project provides bird-friendly development through landscaping that provides habitat to native species and building design that reduces bird collisions.

See [Vancouver Bird Strategy](#)

Applicant Explanation and Reference to Plans, Drawings, and Reports

List all elements that reduce the impact that urbanization has on birds for this project:

- Forested ESA and riparian habitat will be protected.
- Native fruit-bearing species including salmonberry, red elderberry, Indian plum, Nootka rose, and snowberry were selected for restoration planting in the ESA and riparian buffer to provide food for songbirds. Species with a range of flowering times were selected, which will encourage pollinators and select insectivore bird species.
- The restoration planting areas will include species with diverse vertical structure (e.g., snowberry, red elderberry, bigleaf maple).
- Nest surveys will be conducted before clearing invasive blackberry

Staff Comments

Score 3 /3

ENVIRONMENTAL SUSTAINABILITY SECTION *How well does the project minimize the demands on the environment?***Site Context | Ecology****Performance Measure Description and Scoring**

- EN3 Design of outdoor lighting minimizes the harmful effects of *light pollution* with technology that ensures lighting is:

- Only on when needed
- Only lights the area that needs it
- No brighter than necessary
- Minimizes blue light emissions
- Fully shielded (pointing downward)

See [International Dark Sky Association](#) for Dark Sky Friendly Lighting.

Applicant Explanation and Reference to Plans, Drawings, and Reports

Describe the lighting plan for the site and its dark sky friendly features:

Landscape lighting is used only when needed to light pathways and to provide appropriate lighting levels under BCBC and CPTED. Lighting is all LED and directed downward onto the pathway. Automatic, photocells to reduce energy consumption by ensuring lighting is only turned on in the evening.

Staff Comments

Score 2 /3

ENVIRONMENTAL SUSTAINABILITY SECTION *How well does the project minimize the demands on the environment?***Site | Air Quality – Alternative Transportation****Performance Measure Description and Scoring**

- EN4 Project provides alternative transportation facilities for user groups of each land use type, which contributes to reducing Greenhouse Gas Emissions from this development.

Applicant Explanation and Reference to Plans, Drawings, and Reports

Check all that apply: <input checked="" type="checkbox"/> Short-Term Bicycle parking <input checked="" type="checkbox"/> Long-Term Bicycle parking <input type="checkbox"/> End-of-Trip Bicycle Facilities: <input type="checkbox"/> Bike share and assigned parking <input type="checkbox"/> Co-op vehicle and assigned parking space provision <input checked="" type="checkbox"/> Electric Vehicle plug-ins and designated spaces ¹ Plan references:	Staff Comments
---	-----------------------

Score 2 /3**ENVIRONMENTAL SUSTAINABILITY SECTION** *How well does the project minimize the demands on the environment?***Site | Air Quality – Alternative Transportation****Performance Measure Description and Scoring**

- EN5 Project incorporates measures to support pedestrians and cyclists.

Applicant Explanation and Reference to Plans, Drawings, and Reports

Check all that apply: <input checked="" type="checkbox"/> Connects to existing pedestrian/cycling routes and priority destinations <input checked="" type="checkbox"/> Improves local pedestrian routes, local bike networks/trails <input checked="" type="checkbox"/> Safe, secure, accessible, and sustainable footpaths <input checked="" type="checkbox"/> Pedestrian clearway sufficient to accommodate pedestrian flow <input checked="" type="checkbox"/> Covered outdoor waiting areas, overhangs, or awnings <input checked="" type="checkbox"/> Pedestrian scale lighting <input checked="" type="checkbox"/> Pedestrian/bike-only zones <input type="checkbox"/> Other: Site circulation plan: Other plan references: A2.04, A3.01, 18-1133-KP	Staff Comments
--	-----------------------

Score 2 /3

¹ See BC Hydro's *Electric Vehicle Charging Infrastructure Deployment Guidelines*.

ENVIRONMENTAL SUSTAINABILITY SECTION *How well does the project minimize the demands on the environment?***Building | Waste Storage Space****Performance Measure Description and Scoring**

EN6 Project allocates sufficient and accessible recycling and garbage storage space in multi-family and commercial buildings and complexes compatible with City of Port Moody recycling, green waste, and garbage services.

Target 1: Metro Vancouver's Technical Specifications for Recycling and Garbage Amenities in Multi-family and Commercial Developments.

Target 2: Design provides safe and universally accessible access in a secure common area.

Applicant Explanation and Reference to Plans, Drawings, and Reports

Total residential recycling, garbage, and green waste space proposed: Recycling: 39.7 m ² Garbage: 19 m ² Green Waste: 15 m ²	Staff Comments
Total commercial recycling, garbage, and green waste space proposed: Recycling: 6 m ² Garbage: 8 m ² Green Waste: 2.6 m ²	
Details regarding design for safety, security, and accessibility: Both commercial and residential recycling and garbage rooms are fully accessible per code. The rooms are access controlled for security, and will be well lit with motion activated lighting.	

Score 2 /2

ENVIRONMENTAL SUSTAINABILITY SECTION *How well does the project minimize the demands on the environment?***Site | Sustainable Landscaping – Urban Forestry****Performance Measure Description and Scoring**

EN7 Project protects and enhances the *urban forest*, prioritizing native tree species.

See [City of Port Moody Tree Protection Bylaw](#)

Applicant Explanation and Reference to Plans, Drawings, and Reports

Check all that apply: <input checked="" type="checkbox"/> Existing mature trees protected (# 61) <input checked="" type="checkbox"/> Replacement tree ratio (5.4 : 1) • Native tree species planted on site (# 97) • Native tree species planted off site (#) <input checked="" type="checkbox"/> Protected/natural park areas added on site (% of total site area: 34 %) Arborist report: Froggers Creek Tree Consultants Ltd., Appendix 3.	Staff Comments

Score 2 /3

ENVIRONMENTAL SUSTAINABILITY SECTION *How well does the project minimize the demands on the environment?***Site | Sustainable Landscaping – Habitat****Performance Measure Description and Scoring**

EN8 Project preserves, enhances, and/or compensates for site ecology on site (4 points). Off-site compensation may be considered in some cases, in accordance with all other City regulations and supported by staff (3 points).

Compensation in the form of a financial contribution to the City toward approved public restoration, rehabilitation, or enhancement projects may be considered (2 points).

See *City of Port Moody Naturescape Policy 13-6410-03*.

See also [Invasive Plant Council of BC](#)

Applicant Explanation and Reference to Plans, Drawings, and Reports

Check all that apply:	Staff Comments
<input type="checkbox"/> Salvage replanting <input checked="" type="checkbox"/> Reduction to existing impervious area <input type="text" value="470"/> m ²	
<input checked="" type="checkbox"/> Removal of <i>invasive plant species</i> Names: Himalayan blackberry, English ivy, English holly, spurge laurel	
<input checked="" type="checkbox"/> Native/"naturescape" landscaping <input type="checkbox"/> Watercourse daylighting <input checked="" type="checkbox"/> Riparian area restoration	
<input type="checkbox"/> Other measures taken to enhance habitat or to compensate for habitat loss: The plant material palette in this project follows naturescape principles which provides a sustainable, ecologically sound, and aesthetically pleasing urban condition that blends with the adjacent environmentally sensitive area. Focus is on low maintenance and native attractive species and minimal lawn areas, which helps to reduce water consumption. Plant palette does not include any invasive materials, and considers habitat and food options for birds and butterflies with layered plant species.	

Score /4

ENVIRONMENTAL SUSTAINABILITY SECTION *How well does the project minimize the demands on the environment?***Site | Sustainable Landscaping – Stormwater****Performance Measure Description and Scoring**

EN9 Project provides for stormwater retention and evaporation, and groundwater protection in the site stormwater management plan.

Targets:

1. Stormwater retained on-site to the same level of annual volume allowable under pre-development conditions.
2. Maximum allowable annual run-off volume is no more than 50% of the total average annual rainfall depth.
3. Remove 80% of total suspended solids based on the post-development imperviousness.

(3 points if all three targets are achieved)

See link in References to Metro Vancouver's Stormwater Source Control Guidelines

Applicant Explanation and Reference to Plans, Drawings, and Reports

Target(s) reached: <input checked="" type="checkbox"/> 1 <input checked="" type="checkbox"/> 2 <input checked="" type="checkbox"/> 3	Staff Comments
Means of achieving (check all that apply): <input checked="" type="checkbox"/> Absorbent landscape <input type="checkbox"/> Roof downspout disconnection <input type="checkbox"/> Infiltration swales and/or trenches <input checked="" type="checkbox"/> Sub-surface chambers/detention tanks <input type="checkbox"/> Rain gardens with native plantings <input type="checkbox"/> Rainwater harvesting <input type="checkbox"/> Tree well structures <input type="checkbox"/> Green roof/wall <input checked="" type="checkbox"/> Water quality structures <input type="checkbox"/> Pervious paving <input type="checkbox"/> Daylighted streams <input type="checkbox"/> Constructed wetlands	
<input type="checkbox"/> Other:	
References to plans and documents: Stormwater Management Plan	

Score /3

ENVIRONMENTAL SUSTAINABILITY SECTION *How well does the project minimize the demands on the environment?***Site | Sustainable Landscaping – Water Conservation****Performance Measure Description and Scoring**

- EN10 Project reduces potable water use for irrigation.
 2 points = 5 actions (from "check all that apply" list)
 1 point = 3 actions (from "check all that apply" list)

Applicant Explanation and Reference to Plans, Drawings, and Reports

Check all that apply: <input checked="" type="checkbox"/> Drought-tolerant landscaping (<i>xeriscaping</i>) with native species <input checked="" type="checkbox"/> Low-maintenance lawn alternatives <input checked="" type="checkbox"/> Non-water dependent materials/features for ground cover treatment <input checked="" type="checkbox"/> Irrigation system with central control and rain sensors <input type="checkbox"/> Captured rainwater irrigation system, e.g. using cisterns/rain barrels <input type="checkbox"/> Other: Plan reference: L1.0	Staff Comments
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Score 1 /2**ENVIRONMENTAL SUSTAINABILITY SECTION** *How well does the project minimize the demands on the environment?***Site Context | Ecology****Performance Measure Description and Scoring**

- EN11 Project is sited and designed in order to facilitate and improve wildlife movement and access, particularly within known and suspected *habitat corridors*.
 Ex. Deer, bears, frogs, salmon, etc. (depending on site location).

Applicant Explanation and Reference to Plans, Drawings, and Reports

Species supported: Chum salmon, coho salmon, coastal cutthroat trout rainbow trout, urban-associated wildlife (e.g. songbirds, deer, raccoons). Means of supporting: Protect Schoolhouse Brook riparian habitat and enhance riparian habitat through removal of invasive species and planting of native species Environmental assessment or site plan reference: Environmental Assessment and Restoration Plan (Keystone)	Staff Comments
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Score 1 /2

ENVIRONMENTAL SUSTAINABILITY SECTION *How well does the project minimize the demands on the environment?***Building | Green Building Rating****Performance Measure Description and Scoring**

EN12 Project will achieve a recognized industry standard for sustainable design.

Applicant Explanation and Reference to Plans, Drawings, and Reports

<p><input checked="" type="radio"/> Built Green Level: Gold Equivalent</p> <ul style="list-style-type: none"> • Bronze (2 points) • Silver (5 points) • Gold (8 points) • Platinum (10 points) <p><input type="radio"/> LEED Level: </p> <ul style="list-style-type: none"> • Certified (2 points) • Silver (5 points) • Gold (8 points) • Platinum (10 points) <p><input type="radio"/> Canadian Passive House Institute (10 points)</p> <p><input type="radio"/> Living Future Institute</p> <ul style="list-style-type: none"> • Living Building Certification (10 points) • Petal Certification (10 points) • Net Zero Energy Certification (10 points) <p><input type="radio"/> Other:</p>	<p>Staff Comments</p>
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Score 8 /10**ENVIRONMENTAL SUSTAINABILITY SECTION** *How well does the project minimize the demands on the environment?***Building | Alternative/Renewable Energy****Performance Measure Description and Scoring**

EN13 Project provides local, low-carbon energy systems, such as geo-exchange, heat recovery ventilation, solar or district energy.

Applicant Explanation and Reference to Plans, Drawings, and Reports

<p>Details:</p> <p>NA</p>	<p>Staff Comments</p>
<p>Specify % of energy generated:</p>	

Score N/A /4

ENVIRONMENTAL SUSTAINABILITY SECTION *How well does the project minimize the demands on the environment?***Building | Energy Reduction and Indoor Climate****Performance Measure Description and Scoring**

EN14 Building architecture employs *passive design* strategies appropriate to the local climate to reduce energy use and enhance occupant comfort.

Examples:

- Site design and building massing minimizes east and west exposures to avoid unwanted solar gains.
- Limit windows to 50% of any façade, taking into account other livability and aesthetic criteria.
- Use heat-recovery ventilation during heating season only, and design for natural ventilation and cooling by natural ventilation throughout the rest of the year.
- See [City of Vancouver Passive Design Toolkit](#) for Large Buildings for other examples.

Applicant Explanation and Reference to Plans, Drawings, and Reports

<input checked="" type="radio"/> Yes <input type="radio"/> No	Staff Comments
<p>Key <i>passive design</i> building elements:</p> <p>Window wall ratio is less than 50%.</p> <p>The site design minimizes east and west exposures to minimise unwanted solar gains.</p>	

Score 2 /3

ENVIRONMENTAL SUSTAINABILITY SECTION *How well does the project minimize the demands on the environment?***Smart Technology****Performance Measure Description and Scoring**

EN15 Project uses *smart technology* to optimize sustainable use of resources.

Ex. Automated lighting, shading, HVAC, energy/water consumption, security, etc.

Applicant Explanation and Reference to Plans, Drawings, and Reports

<p>Details:</p> <p>LED lighting, Heat Recovery Ventilation (HRV), Low-E glazing, Energy Star appliances.</p>	Staff Comments

Score 2 /2

ENVIRONMENTAL SUSTAINABILITY SECTION *How well does the project minimize the demands on the environment?***Site | Sustainable Landscaping****Performance Measure Description and Scoring**

- EN16 Project provides or designates space for growing food in private or common areas including on-site composting to support the gardening activities.

Applicant Explanation and Reference to Plans, Drawings, and Reports

Details:

The rooftop amenity space includes community garden planters and associated tool storage for food to be grown on site.

Staff Comments

Landscape Plan Reference: L1.3

Score 2 /2**ENVIRONMENTAL SUSTAINABILITY SECTION** *How well does the project minimize the demands on the environment?***Building Energy Performance****Performance Measure Description and Scoring**

- EN17 Building design incorporates Port Moody Building Energy Performance Design Guidelines.

Applicant Explanation and Reference to Plans, Drawings, and Reports**BC Energy Step Code:**

- ☒ Tier 1 (1 point)
☐ Tier 2 (2 points)
☐ Tier 3 (3 points)
☐ Tier 4 (4 points)

Attach a copy of Port Moody Building Energy Performance Design Guidelines Checklist.

Staff Comments

Score 1 /4

ENVIRONMENTAL SUSTAINABILITY SECTION *How well does the project minimize the demands on the environment?***Stormwater and Ecology/Water Conservation****Performance Measure Description and Scoring**

EN18 Project incorporates landscaped roofs or living walls that also provide food/habitat for native species.

OR

Project includes on-site grey water reuse.

2 BONUS POINTS EACH**Applicant Explanation and Reference to Plans, Drawings, and Reports**

Details:	Staff Comments
3,500m2 of the Schoolhouse South Creek riparian area and ESA habitat will be enhance and protected providing habitat birds and other animals, wildlife corridor and a food source for downstream aquatic animals.	

Bonus Score /2**ENVIRONMENTAL SUSTAINABILITY SECTION** *How well does the project minimize the demands on the environment?***Environmental Monitoring****Performance Measure Description and Scoring**

EN19 Project contracts with an Environmental Monitor(s) to oversee implementation of environmental sustainability measures, i.e. sustainable landscaping measures.

OR

Project employs an energy efficiency consultant.

2 BONUS POINTS EACH**Applicant Explanation and Reference to Plans, Drawings, and Reports**

Details of Work Overseen/Contribution:	Staff Comments
Keystone Environmental Consultants have been retained to develop the plan for the riparian area and ESA, and will provide monitoring over the three year post-restoration period.	

Bonus Score /2

ENVIRONMENTAL SUSTAINABILITY SECTION *How well does the project minimize the demands on the environment?***Innovation****Performance Measure Description and Scoring**

EN20 Environmental sustainability aspects not captured above.

Applicant Explanation and Reference to Plans, Drawings, and Reports

	Staff Comments Applicant Comment: In addition, Salmon Safe Certification is being pursued for the project. Salmon Safe provides a third-party verification that the project is being designed and built in accordance with environmentally friendly management practices that minimize impacts on water quality and aquatic biodiversity.
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ENVIRONMENTAL SUSTAINABILITY SECTION *How well does the project minimize the demands on the environment?***Constraints****Performance Measure Description and Scoring**

EN21 Unique site aspects that limit environmental sustainability achievement.

Applicant Explanation and Reference to Plans, Drawings, and Reports

	Staff Comments
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Environmental Sustainability Score Summary

	Score
Total Environmental Pillar Points (Total Points Available – Not Including Bonus Points)	61 Total
Total Environmental Points Not Applicable (Total Points for Items Not Relevant to this Application)	4 n/a
Maximum Achievable Score (Total Environmental Pillar Points Minus Total Environmental Points Not Applicable)	57 Maximum
Environmental Pillar Minimum Score (Sum of Applicable Baseline Items)	30 Enviro Baseline
Total Points Achieved (Total Points Achieved for Applicable Items for this Application)	40 Total Environmental Points
Environmental Pillar Score (Total Points Achieved/Maximum Achievable Score)	<div> <div>40 Total Environmental Points</div> <div>/</div> <div>57 Max</div> <div>=</div> <div>70 Percent</div> </div>

SOCIAL SUSTAINABILITY SECTION*How well does the project address community health and wellness?***Accessibility****Performance Measure Description and Scoring**

S1

For single-storey units in multi-family residential development:

(a) a minimum of 40% are *adaptable units* (2 points) and, of those units,(b) *accessible unit(s)* providing full wheelchair accessibility are provided (2 points).

Project incorporates adaptable and accessible design features in the site/building circulation and bathrooms in all other uses (2 points).

Applicant Explanation and Reference to Plans, Drawings, and Reports

Residential	Staff Comments
% of Adaptable Units: <input type="text" value="50"/>	
Details: All common areas of the residential building, lobby, circulation space, elevators and amenity spaces, will be accessible.	
Number of Accessible Units: <input type="text" value="0"/>	
Details:	
Residential Site/Common Areas and Commercial/Industrial/Institutional Uses: Office	
Details: Commercial spaces will be fully accessible from the street level and the parking area. CRU spaces are not yet designed but will be required to provide fully accessible bathrooms and circulation areas.	

Score /6

SOCIAL SUSTAINABILITY SECTION*How well does the project address community health and wellness?***Complete Community Design****Performance Measure Description and Scoring**

- S2 Project design is adapted to minimize shadow or privacy impacts to adjacent buildings.

AND/OR

Project design integrates the results of a *viewscape* study with respect to water and mountain views.

Applicant Explanation and Reference to Plans, Drawings, and Reports

Details:

A shadow study has been conducted and demonstrates no impact to adjacent buildings. Only the northwest corner of the building lines up with an adjacent residential building so privacy impacts are minimal. The other building frontages are facing heavily treed areas and commercial uses.

Plan/document references:

A0.011, A0.040

Staff CommentsScore /1**SOCIAL SUSTAINABILITY SECTION***How well does the project address community health and wellness?***Diversity of Use****Performance Measure Description and Scoring**

- S3 Development provides diversification by increasing the mix of uses for the particular site and its neighbourhood.

Applicant Explanation and Reference to Plans, Drawings, and Reports

Existing use(s):

None.

Staff Comments

Proposed uses:

% Total Floorspace/Site Area

Residential

Commercial

Industrial

Institutional

Park (Note Type)

Gathering Space

Score /3

SOCIAL SUSTAINABILITY SECTION*How well does the project address community health and wellness?***Housing Diversity****Performance Measure Description and Scoring**

S4 Development includes a mix of housing types.

Applicant Explanation and Reference to Plans, Drawings, and Reports

	Number of Units	Staff Comments
Live-work units	<input type="text"/>	
Ground-oriented units	41	
Apartment units	201	

Score /3**SOCIAL SUSTAINABILITY SECTION***How well does the project address community health and wellness?***Housing Diversity****Performance Measure Description and Scoring**

S5 Project includes a range of unit sizes for a variety of household types, and the design is flexible to allow for changes, i.e. den can easily become another bedroom.

Targets:

2-bedroom minimum 25% of units

3-bedroom minimum 10% of units

Applicant Explanation and Reference to Plans, Drawings, and Reports

	Number of Units	% of Units	Staff Comments
Bachelor/1-bedroom	<input type="text" value="168"/>	<input type="text" value="69"/>	
2-bedroom	<input type="text" value="70"/>	<input type="text" value="29"/> (1 pt)	
3+ -bedroom	<input type="text" value="4"/>	<input type="text" value="2"/> (2 pts)	
Flexible design features:			

Score /3

SOCIAL SUSTAINABILITY SECTION*How well does the project address community health and wellness?***Housing Affordability****Performance Measure Description and Scoring**

- S6 Project provides new purpose-built *market rental housing* (2 points) or affordable *market rental housing* (3 points) or *non-market rental housing* (4 points).

OR

Development contributes to the City's Affordable Housing Reserve Fund in lieu of provision of affordable housing (2 points).

Applicant Explanation and Reference to Plans, Drawings, and Reports

Types: Market Rental	Staff Comments
Description: 22 of the units will be provided as market rental for a term of 20 years.	
% of total housing units: <input type="text" value="9"/> %	
Plan reference: NA	

Score /4**SOCIAL SUSTAINABILITY SECTION***How well does the project address community health and wellness?***Amenities****Performance Measure Description and Scoring**

- S7 Project provides voluntary public amenities.
Examples:
- Child care facility
 - Space for growing food
 - Child play areas
 - Gathering place/space
 - Park/greenspace
 - Public contribution in lieu (CACs), i.e., school, library, arts, etc.
- (5 Points = any approved option)

Applicant Explanation and Reference to Plans, Drawings, and Reports

Details: Multi-use pathway along St. Johns St. Public, realm improvements with seating benches fronting the commercial area and bike racks for short term bike parking.	Staff Comments
Plan reference:	

Score /5

SOCIAL SUSTAINABILITY SECTION*How well does the project address community health and wellness?***Amenities****Performance Measure Description and Scoring**

S8 Project provides voluntary private amenities.

Examples:

- Accessible green roof
- Communal garden
- Dog runs
- Play areas
- Social gathering place

(1 point per approved amenity item – maximum of 3 points)

Applicant Explanation and Reference to Plans, Drawings, and Reports

Details:

Children's playground that benches into the slope and includes 'nature play' elements.

Central gathering space with raised seating area. Lawn space.

Large indoor amenity room on the 6th floor facing Burrard Inlet and connected to an outdoor, rooftop amenity space. Outdoor kitchen/BBQ with dinning table, lounge seating and community garden plots.

Plan reference:

L1.2, L1.2

Staff CommentsScore 3 /3**SOCIAL SUSTAINABILITY SECTION***How well does the project address community health and wellness?***Inclusive Community****Performance Measure Description and Scoring**

S9 The proposal supports aging-in-place with adult care, assisted living space, and/or independent senior living space.

Applicant Explanation and Reference to Plans, Drawings, and Reports

Details:

50% of the units are being designed as adaptable which is an appropriate design standard to support aging-in-place. This includes key spacial design elements (eg. space for wheelchairs) as well as provision for grab bars to be installed in the future.

Light switches, receptacles, cable/data outlets all located to be reachable to a person in a wheelchair.

Staff CommentsScore 1 /4

SOCIAL SUSTAINABILITY SECTION*How well does the project address community health and wellness?***Community Building****Performance Measure Description and Scoring**

S10 Project provides *urban vitalization* by involving land owners and occupants, community groups, and end user groups who may be affected by the proposal in the planning process to identify and showcase Port Moody's unique assets, i.e. goes above and beyond standard notification and consultation.

Examples:

- Host a community-building workshop with the neighbourhood at the time of a project's inception to determine values and identify unique assets to leverage through design.

Staff will advise on notification requirements and appropriate stakeholder consultation

Applicant Explanation and Reference to Plans, Drawings, and Reports

<p>Please identify stakeholders and explain their involvement:</p> <p>Local stream keepers and other environmental groups will be sought for consultation and advice on the enhancement of the riparian area. In past experiences, we found this provided key insights into the local ecology and enabled a more tailor-made approach.</p>	<p>Staff Comments</p>
<p>Identify actions taken in response to stakeholder input:</p> <p>Consultation is pending.</p>	
<p>Plan references:</p>	

Score 1 /4

SOCIAL SUSTAINABILITY SECTION*How well does the project address community health and wellness?***Safety****Performance Measure Description and Scoring**

- S11 The design of the site incorporates *Crime Prevention Through Environmental Design* principles (CPTED).

Applicant Explanation and Reference to Plans, Drawings, and Reports

Please explain:

This development follows well established CPTED principals by eliminating or reducing concealed spaces both above and below grade, separating public and residential stairs, separating and controlling access to resident parking areas and by controlling access to residential elevators while providing egress from below grade visitor or commercial parking areas. Access to the visitor and commercial parking areas is through an open gate during normal business hours while off hour access to these areas is controlled by an enter-phone.

Plan references:

A2.17, A3.01

Staff CommentsScore /1**SOCIAL SUSTAINABILITY SECTION***How well does the project address community health and wellness?***Education and Awareness****Performance Measure Description and Scoring**

- S12 Project provides education and awareness of the sustainable features of the project for owners/occupants.

Examples:

- Document is given to new owners at time of sale, covenant on title, inclusion/protection of features in strata bylaws
- Signage/display/art recognizing design, etc.

Applicant Explanation and Reference to Plans, Drawings, and Reports

Describe:

An operations and maintenance plan will be provided to the strata corporation and property manager, and will outline standards for maintaining on-site landscaping in accordance with Salmon Safe practices. This includes, limitation of herbicides/pesticides and identification of permitted fertilizers. Signage will be located on the SPEA fence along the Albert Street frontage.

Staff CommentsScore /1

SOCIAL SUSTAINABILITY SECTION*How well does the project address community health and wellness?***Innovation****Performance Measure Description and Scoring**

S13 Social sustainability aspects not captured above.

Applicant Explanation and Reference to Plans, Drawings, and Reports

	Staff Comments
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SOCIAL SUSTAINABILITY SECTION*How well does the project address community health and wellness?***Constraints****Performance Measure Description and Scoring**

S14 Unique site aspects that limit social sustainability achievement.

Applicant Explanation and Reference to Plans, Drawings, and Reports

	Staff Comments
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Social Sustainability Score Summary

	Score
Total Social Pillar Points (Total Points Available – Not Including Bonus Points)	38 Total
Total Social Points Not Applicable (Total Points for Items Not Relevant to this Application)	0 n/a
Maximum Achievable Score (Total Social Pillar Points Minus Total Social Points Not Applicable)	38 Maximum
Social Pillar Minimum Score (Sum of Applicable Baseline Items)	7 Social Baseline
Total Points Achieved (Total Points Achieved for Applicable Items for this Application)	17 Total Social Points
Social Pillar Score (Total Points Achieved/Maximum Achievable Score)	17 / 38 = 45 % Total Social Points Max Percent

Project Report Card Summary FOR CITY USE ONLY – TO BE FILLED OUT BY THE PLANNER

Project Address/Name:	File No:
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PROJECT SCORE SUMMARY	Cultural	Economic	Environmental	Social
Total Pillar Points Available	23	16	57	38
Sum Of Items Not Applicable	Cultural na 9	Economic na 3	Enviro na 4	Social na 0
Maximum Achievable Score (Total Pillar Points – Sum of Items N/A)	Maximum Cultural Achievable 14	Maximum Economic Achievable 13	Maximum Enviro Achievable 57	Maximum Social Achievable 38
Minimum Score (Sum of Applicable Baseline Items)	Minimum Cultural Score 5	Minimum Economic Score 7	Minimum Enviro Score 30	Minimum Social Score
Missed Points (Sum of Applicable Items Not Achieved)	Missed Cultural Points 7	Missed Economic Points 7	Missed Enviro Points 17	Missed Social Points
TOTAL PILLAR SCORE ACHIEVED (Total Points Achieved out of Applicable Items)	<div>7 / 14</div> <div>Total Cultural # / Possible Cultural #</div> <div>50 %</div> <div>Total Cultural Percent</div>	<div>6 / 13</div> <div>Total Economic # / Possible Economic #</div> <div>46 %</div> <div>Total Economic Percent</div>	<div>40 / 57</div> <div>Total Enviro # / Possible Enviro #</div> <div>70 %</div> <div>Total Enviro Percent</div>	<div>17 / 38</div> <div>Total Social # / Possible Social #</div> <div>45 %</div> <div>Total Social Percent</div>

OVERALL SUSTAINABILITY SCORE (Sum of Four Pillars)

<div>70 / 122</div> <div>Overall # / Overall Possible #</div>	<div>57 %</div> <div>Overall Percent</div>
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SUSTAINABILITY HIGHLIGHTS

+ Priority Items (Score ≥3) Achieved and Confirmed Innovations

- Priority Items (Score ≥3) Missed and Confirmed Constraints

Cultural	Economic	Environmental	Social
+ Cultural Public Art installation proposed for corner of St. Johns Street and Albert Street.	+ Economic	+ Environmental Enhancement of existing riparian area and removal of invasive species. Commitment to Built Green Gold equivalent.	+ Social 22 units proposed to be market rental for a term of 20 years.
- Cultural No Heritage Buildings on-site	- Economic	- Environmental Step Code Tier 1 commitment	- Social