

Considered at the July 23, 2024, Regular Council meeting

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City of Port Moody

Report/Recommendation to Council

Date: July 23, 2024
 Submitted by: Community Development Department – Development Planning Division
 Subject: OCP Amendment and Rezoning – 2331-2335 St. Johns Street (Cornerstone Architecture) – Bylaw Nos. 3471, 3470, and 3472

Purpose

To present for Council consideration the first and second readings of an application for OCP Amendment and Rezoning to facilitate a six-storey mixed-use development with a rooftop garden within 2231-2335 St. Johns Street (File: ORD00006).

Recommended Resolution(s)

THAT City of Port Moody Official Community Plan Bylaw, 2014, No. 2955, Amendment Bylaw No. 38, 2024, No. 3471 (2331-2335 St. Johns Street and a 5.5-metre-wide portion of Queens Street right-of-way) be read a first and second time as recommended in the report dated July 23, 2024, from the Community Development Department – Development Planning Division regarding OCP Amendment and Rezoning – 2331-2335 St. Johns Street (Cornerstone Architecture) – Bylaw Nos. 3471, 3470, and 3472;

AND THAT City of Port Moody Zoning Bylaw, 2018, No. 2937, Amendment Bylaw No. 97, 2024, No. 3470 (2331-2335 St. Johns Street and a 5.5-metre-wide portion of Queens Street right-of-way) (CD97) be read a first and second time;

AND THAT Bylaw No. 3470 and Bylaw No. 3471 be referred to Public Hearing;

AND THAT City of Port Moody Road Closure Bylaw – Portion of Queens Street, 2024, No. 3472 be read a first, second, and third time.

Background

Cornerstone Architecture (On behalf of Benedet Properties Ltd.) submitted a full application in July 2023 to amend the Official Community Plan (OCP) land use and storey designations and to rezone the subject properties at 2331-2335 St. Johns Street to a new Comprehensive Development (CD) zone to allow for the development of a mixed-used project.

The application was presented to the Land Use Committee (LUC) on September 7, 2023. The LUC endorsed the proposed project with a list of concerns for the applicant to address. These concerns included the sufficiency of commercial parking allocations, access, egress, turning radii designs, the need for traffic lights at St. Johns Street intersection, consideration of e-bike

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parking, and more information about pedestrian safety at the intersection between the planned multi-use pathway and the stairs.

The application was also presented to the Advisory Design Panel (ADP) on October 26, 2023. The ADP endorsed it, subject to the applicant addressing several items. Some major items included incorporating heritage features and the neighbourhood character, using more vibrant materials or feature colours in the residential massing, and integrating green infrastructure along the streets. Additionally, they recommended investigating the inclusion of native, pollinator-friendly plant species and bird-friendly features on building glass.

In addition, the application was presented to the Council members at the City Initiatives and Planning Committee (CIPC) on November 21, 2023. The discussion included intersection signaling, St. Andrews Street lane width, traffic and pedestrian flow, family-friendly and rental inclusions, green roofing, architectural design of the upper floors, sustainability inclusions, and an inclusion of fresh produce in the grocery component. Detailed LUC and CIPC meeting minutes are included as **Attachment 1** and **2**. The applicant has made efforts to address above concerns, as well as those provided by staff, in the most recent application resubmission package.

Discussion

Property Description

The subject site consists of two lots at the southwest corner of St. Johns Street and Queens Street plus 5.5-metre-wide portion of City land within the Queens Street right-of-way. The location map is included as **Attachment 3**. The site is approximately 1,839m² (19,800ft²) in size and currently developed with four strata units on the western lot (2331 St. Johns Street) and a Thai restaurant on the eastern lot (2335 St. Johns Street). Neither property has heritage value, although the neighbouring lot on the west side is a protected heritage property (White Residence at 2329 St. Johns Street).

Official Community Plan (OCP)

The eastern subject lot (2335 St. Johns Street) is designated Mixed Use – Moody Centre in the Official Community Plan, allowing for a maximum height of four storeys, while the western subject lot (2331 St. Johns Street) is designated Multi-Family Residential, which permits up to a maximum of three storeys (**Attachment 4**). The proposal is not consistent with these designations and, therefore, requires an amendment to the OCP Bylaw.

The site falls within Development Permit Area 2 (DPA2) – Moody Centre and both lots are within the Moody Centre Heritage Conservation Area (HCA). The site is also located within Development Permit Area 5: Hazardous Conditions due to steep slopes and the potential of soil liquefaction during an earthquake event. Draft of Bylaw No. 3471 is included as **Attachment 5**.

Zoning

In terms of Zoning designations, the eastern lot of the subject site is currently zoned as General Commercial (C3), while the western one is Medium Density Townhouse Residential (RM4) (**Attachment 6**). Since the application does not fit with the designation requirements and regulations, the applicant has requested creation of a Comprehensive Development (CD) zone for this development. Draft of Bylaw No. 3470 is included as **Attachment 7**.

Neighbourhood Context

The subject site fronts onto St. Johns Street and backs onto St. Andrews Street. Surrounding development consists of the following:

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- North: A property zoned as General Commercial (C3) that is designated as Mixed Use – Moody Centre, and to its west, a Comprehensive Development Zone 14 (CD14) designated as Multi-Family Residential, permitting development of up to three storeys in accordance with the OCP.
- East: The lot on the east is currently a Shell Gas Station and is zoned Service Station Commercial (C4) in the OCP, allowing for the development of up to four storeys.
- South: Single-Detached Residential (RS1) lots, designated in the OCP as Single-Family Low Density.
- West: A protected heritage property zoned as Medium Density Townhouse Residential (RM4).

Development Proposal Description

The applicant seeks to rezone the subject site to a Comprehensive Development (CD) zone to construct a six-storey mixed-use commercial and residential building and a rooftop garden amenity space on top with enclosed and open space. The first two levels of the building would contain a specialty food store and a parkade for commercial use on the same ground level with a mezzanine and portion of residential parking stalls at the rear on the next floor. Above these levels, there would be a residential parkade and four residential floors proposed to be 100% market rental apartments. Due to the sloping nature of the site, the lowest commercial level facing St. Johns Street is considered to be a “basement” by Zoning Bylaw definition. St. Andrews Street is a full level above St. Johns Street. Additional specifics regarding the proposal are outlined as follows:

- Total gross floor area: 5,206m² (56,033.5ft²) spread across the following uses:
 - 885m² (9,525ft²) of commercial space over two floors fronting onto St. Johns Street.
 - 3,473m² (37,379ft²) of residential space over four upper floors with 48 market rental apartments, including the following unit mix:

Unit Type	Number of Units	Percentage of Mix
Studio	8	17%
One-Bedroom	21	44%
Two-Bedroom	12	25%
Three-Bedroom	7	14%

- 50% adaptable dwellings (24 units out of the total 48) meeting Zoning Bylaw requirement for Adaptable Housing Requirements.
- A proposed floor space ratio (FSR) of 2.63.
- A total of 81 parking spaces with the following allocation:
 - 53 residential parking spaces located at the rear of the mezzanine level and parkade level on top of it for the 48 units with entry accessed from St. Andrews Street (48 is required);
 - 23 commercial parking spaces accessed through Queens Street (22 is required);
 - 5 visitor parking spaces for the residential units; and
 - 2 accessible parking for residential and 1 for commercial area.
- 73 long term bicycle spaces and 6 short term stalls for residential portion.
- 1 long term bicycle spaces and 6 short term stalls for commercial portion.

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- A patio area of approximately 113.4m² (1,221ft²) on the St. Johns Street right of way on the south side of the multi-use path.
- A total of 496.6m² (5,346ft²) rooftop garden and greenhouse space in the form of both indoor and outdoor areas (excluding roof circulation) as a communal amenity for the residents.
- Committed to comply with Energy Step Code 3 with a Low Carbon Energy System (LCES).

Proposed project plans and landscape plans are included as **Attachment 8** and **9**. A project Fact Sheet is provided as **Attachment 10**.

Staff Analysis – Items for Staff Consideration/Review

Housing

With the residential component of the project being entirely market rental, the development is exempt from the requirements of the Inclusionary Zoning – Affordable Housing policy. A housing agreement bylaw is required for the market rental component of the development.

Family Friendly Units Policy

The proposed bedroom mix for this project meets the current policy, updated on June 18, 2024.

Sustainability Report Card

The completed and scored Sustainability Report Card for the development proposal is included as **Attachment 11**. The development received the highest scores in the economic and environmental sustainability pillars.

Public Art Policy

According to the Public Art Corporate Policy 18-7940-01, amended on September 19, 2017, developer contributions are not required for developments exclusively for rental housing. However, the applicant is proposing to contribute 0.5% of the commercial components' construction budget, approximately \$20,240, for a single art piece. The artwork is planned to be hung over the public space under the canopies at the northeast corner, as in **Attachment 12**.

Amenity Spaces/Community Gathering Spaces

The project features a rooftop garden as an amenity space with indoor and outdoor sheltered areas, providing spaces for exercise, relaxation, and community meeting or recreational activities for residents. Additionally, the application proposes a 128.76 m² (1386 ft²) outdoor kids' play area on the first residential level.

Patio Area

Staff support the proposed patio area on the City property along St. Johns, south of the Multi-Use Path (MUP), considering the potentials for improving the vibrancy and activity along St. Johns Street. Since the applicant has indicated that this area is intended for the exclusive use by Bosa Foods, with discretionary use by the public, staff suggest considering either a Lease or a License of Occupation with an appropriate annual fee. This arrangement would retain the City's authority to request the removal or modification of the patio whenever needed in the future. The final decision will be made with the Development Permit and will be registered on title as part of the permit.

Overhang/weather protection

The applicant proposes a roof overhang/weather protection at the corner of the St. Johns Street and Queens Street for the entrance area of the Bosa Foods store, which encroaches on city

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property. An Encroachment Covenant is required which will be identified in the Development Permit requirements, and it will be registered on the building title for this development.

Queens Street Road Closure

This project requires a 5.5-metre-width portion of the Queens Street right-of-way, totalling approximately 216.9m² (2,334.6ft²) in size, to be closed, purchased by the owner, and consolidated with the development site. If the development is approved, the owner has committed to purchasing this portion of Queens Street at market value. Based on the proposed uses of the development, the market value of the closure area is \$930,000, as assessed in the most recent appraisal report. A draft road closure bylaw, Bylaw No. 3472, is included as **Attachment 13**.

Concluding Comments

Overall, the project is well-developed, and staff are supportive of the application as proposed. It provides new commercial opportunities and increases the amount of market rental housing stock in the city. Additionally, it shows potential for enhancement along St. Johns Street with the patio, support for other adjacent public places, and encouraging more vibrancy through greater community presence.

Other Option(s)

THAT City of Port Moody Official Community Plan Bylaw, 2014, No. 2955, Amendment Bylaw No. 38, 2024, No. 3471 (2331-2335 St. Johns Street and a 5.5-metre-wide portion of Queens Street right-of-way) and City of Port Moody Zoning Bylaw, 2018, No. 2937, Amendment Bylaw No. 97, 2024, No. 3470 (2331-2335 St. Johns Street and a 5.5-metre-wide portion of Queens Street right-of-way) (CD97) be read a first time;

AND THAT the applicant address the following issues prior to second reading and referral to a Public Hearing:

- (list concerns).

Financial Implications

Community Amenity Contributions (CACs)

The exact CAC amount will be established at the development permit stage once the final residential floor area is confirmed and will be collected prior to the adoption of the rezoning bylaw. Based on the proposed development, the contribution is estimated to be approximately \$161,627.34, including deduction based on eligible credits for the existing residential floor area.

Public Art Contribution

The applicant is proposing to contribute 0.5% of the project's construction budget for the commercial component in the form of an artwork, with the approximate budget of \$20,240.

Off-Site Improvement Contributions

The development committed to provide a full traffic and pedestrian crosswalk signal at the intersection of St. Johns and Queens Street as required.

Road Closure

The report has been presented to the Council meeting to discuss the sale of the 5.5-metre-wide portion of Queens Street on the basis that the proposed floor area and land uses are distributed as if the road were a portion of the site for density calculation purposes. As part of this development, the applicant would be required to purchase this portion of Queens Street,

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contingent upon the rezoning being approved by Council. The assessed value in the most recent appraisal report is \$930,000.00.

Communications and Public Engagement Initiatives

A notification sign informing the public of the development application has been placed on the subject site in accordance with the City of Port Moody Development Approval Procedures Bylaw, 2023, No. 3417. Should the rezoning application be given first and second readings, the public will have an opportunity to comment at the Public Hearing. The public hearing will be noticed by following at least two methods mentioned in the above bylaw and a decal placed on the application notification sign on the subject property.

Prior to adoption of the road closure bylaw, notice of Council's intention to dispose of the road must be given, providing the public with an opportunity to comment on the disposition in accordance with sections 26(3) and 40 of the *Community Charter*.

Developer Consultation

In addition, a Community Information Meeting was held by the applicant on Wednesday, August 30, 2023, from 4-7pm at the POMOARTS center, 2425 St. Johns Street with 30-40 individuals walked through the door. Total 22 comment sheets were submitted at the meeting, with 16 fully supporting, 5 supporting with comments and 1 supporting Bosa Foods but only 2 floors of rental part.

Engage Port Moody

The most recent Engage Port Moody summary report indicates a total of 21 comments were received up to June 26, 2024. Of those, 14 were supportive, 2 were opposed and 5 had a mixed reaction to the proposal. Verbatim comments are included in the summary (**Attachment 14**).

Council Strategic Plan Goals

The recommendations in this report align with the following Council Strategic Plan Goal(s):

- Strategic Goal 4.1 – Improve the local business climate; and
- Strategic Goal 4.3 – Leverage public spaces.

Attachment(s)

1. LUC meeting minutes.
2. CIPC meeting minutes.
3. Location map.
4. OCP Designation.
5. Draft Bylaw No. 3471 (OCP Amendment).
6. Zoning Designation.
7. Draft Bylaw No. 3470 (Rezoning).
8. Project plans.
9. Landscape plans.
10. Project Fact Sheet.
11. Scored Sustainability Report Card.
12. Public Art Concept.
13. Draft Bylaw No. 3472 (Road Closure).
14. Engage Port Moody Summary Report.

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Report Author

Armita Afsahi

Development Planner

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Report Approval Details

Document Title:	OCP Amendment and Rezoning – 2331-2335 St. Johns Street (Cornerstone Architecture) – Bylaw Nos. 3471, 3470, and 3472.docx
Attachments:	<ul style="list-style-type: none"> - Attachment 1 - LUC meeting minutes.pdf - Attachment 2 - CIPC meeting minutes.pdf - Attachment 3 - Location Map - 2331-2335 St. Johns Street.pdf - Attachment 4 - OCP Designation - 2331-2335 St. Johns Street.pdf - Attachment 5 - Draft Bylaw No. 3471 (OCP Amendment) - 2331-2335 St. Johns Street.pdf - Attachment 6 - Zoning Designation - 2331-2335 St. Johns Street.pdf - Attachment 7 - Draft Bylaw No. 3470 (Rezoning) - 2331-2335 St. Johns Street.pdf - Attachment 8 - Project Plans - 2331-2335 St. Johns Street.pdf - Attachment 9 - Landscape plans - 2331-2335 St. Johns Street.pdf - Attachment 10 - Project Fact Sheet - 2331-2335 St. Johns Street.pdf - Attachment 11 - Scored Sustainability Report Card - 2331-2335 St. Johns Street.pdf - Attachment 12 - Public Art Concept - 2331-2335 St. Johns Street.pdf - Attachment 13 - Draft Bylaw No. 3472 (Road Closure) - 2331-2335 St. Johns Street.pdf - Attachment 14 - Engage Port Moody Summary Report.pdf
Final Approval Date:	Jul 16, 2024

This report and all of its attachments were approved and signed as outlined below:

Tracey Takahashi, Deputy Corporate Officer - Jul 11, 2024

Kate Zanon, General Manager of Community Development - Jul 12, 2024

Stephanie Lam, City Clerk and Manager of Legislative Services - Jul 12, 2024

Lindsay Todd, Manager of Communications and Engagement - Jul 12, 2024

Paul Rockwood, General Manager of Finance and Technology - Jul 12, 2024

Anna Mathewson, City Manager - Jul 16, 2024



City of Port Moody Minutes Land Use Committee

Minutes of the meeting of the Land Use Committee held on
Thursday, September 7, 2023, via Zoom.

Present

Councillor Kyla Knowles, Chair
Alistair Henry
Barbara Junker
Jonathan Leighs
Jeffery McLellan
Bill Parneta
Jessica Wakeling
Stirling Ward (arrived at 7:09pm)
Sarah Wellman

Absent

Councillor Callan Morrison, Vice-Chair
Jillian Eaton (Regrets)
Amanda Welsh (Regrets)

In Attendance

Armita Afsahi – Development Planner
Jennifer Mills – Legislative Services Advisor
Michael Olubiyi – Manager of Development Planning
Wesley Woo – Assistant Manager of Planning

1. Call to Order

The Chair called the meeting to order at 7:00pm and welcomed new Panel member, Jessica Wakeling.

2. Territorial Land Acknowledgement

The Chair provided the territorial land acknowledgement.

3. Adoption of the Agenda

Agenda

3.1 LUC23/013

Moved, seconded, and CARRIED

THAT the agenda of the September 7, 2023, Land Use Committee be adopted as circulated.

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Attachment 1

4. Adoption of Minutes
-
- Minutes**
- 4.1 LUC23/014
 Moved, seconded, and CARRIED
THAT the minutes of the Land Use Committee meeting held on July 6, 2023, be adopted.
5. Unfinished Business
-
6. New Business
-
- LUC – OCP
 Amendment and
 Rezoning (Mixed Use
 Commercial and
 Residential) –
 2331-2335 St. Johns
 Street (Cornerstone
 Architecture)**
- 6.1 Presentation: Development Planning Division
 Report: Community Development Department – Development Planning Division, dated September 7, 2023
- Staff gave a presentation entitled “2331-2335 St. Johns Street” and referred to slides contained in the on-table package.
- Stirling Ward entered the meeting at this point.
- Committee discussion ensued regarding the following topics:
- concerns about access and egress points and the need for a traffic light;
 - concerns about turning radii and loading areas in the parkade;
 - support for the unit mix, market rentals, patio, greenhouse on roof, rental units, adaptable units, and Bosa Foods;
 - concerns regarding the design and safety of the stairs located on the corner and the plaza extending into the future multi-use path;
 - opportunity to re-align Queens Street and install a traffic light, prior to building completion;
 - opportunity to improve overall safety through directing traffic back to Kyle Street by revising St. Andrews Street to a dead end, fire access only, or resident only street;
 - concerns regarding the existing limited parking on St. Johns Street and the proposed shared residential and commercial parking;
 - opportunity to include more two-bedroom units in the unit mix;
 - concerns that the commercial parking allocation may not be adequate as Bosa Foods is a specialty grocer that will attract visitors from outside of Port Moody who will most likely travel in a vehicle;

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Attachment 1

- opportunity to implement a green wave system to synchronize traffic lights and facilitate smoother functioning of traffic; and
- opportunity for secure commercial bike parking areas to encourage micromobility.

Staff noted the following in response to Committee member questions:

- the need for a traffic light has been raised by staff and supported at public information meetings, and is being considered to ensure the intersection operates safely and efficiently;
- the applicant has been asked to provide more details about the shared parking plan, including security coverage;
- the developer would typically be responsible for the installation and construction of a traffic light if warranted; and
- the residential and commercial parking are separate and have two different entrances.

LUC23/015

Moved, seconded, and CARRIED

THAT the Land Use Committee endorse the proposed project as presented in the report dated September 7, 2023, regarding LUC – OCP Amendment and Rezoning (Mixed Use Commercial and Residential) – 2331-2335 St. Johns Street (Cornerstone Architecture), subject to the applicant addressing the following specific items:

- **the sufficiency of the current commercial parking allocation;**
- **the sufficiency of the access, egress, and turning radii designs;**
- **the need for a traffic light at the St. Johns Street intersection, prior to project completion;**
- **the consideration of e-bike parking;**
- **the need for review and information about the intersection between the planned multi-use pathway and the stairs, including information about pedestrian safety.**


7. Information

Staff Updates


7.1 There were no staff updates at this time.

8. Adjournment


The Chair adjourned the meeting at 7:57pm.

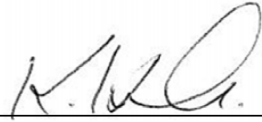

Councillor Kyla Knowles,
Chair

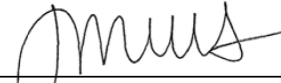

Jennifer Mills,
Legislative Services Advisor

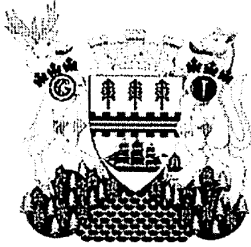

**City of Port Moody
Minutes**

City Initiatives and Planning Committee

**Tuesday, November 21, 2023
5:05 pm
Electronic Webinar via Zoom**

Present: Councillor S. Agtarap, Chairperson
Mayor M. Lahti
Councillor D. Dilworth
Councillor K. Knowles
Councillor A. Lubik
Councillor H. Lurbiecki
Councillor C. Morrison

In Attendance: Tim Savoie – City Manager
Mary De Paoli – Manager of Policy Planning
Tyson Ganske – Manager of Financial Planning and Deputy CFO
Stephanie Lam – City Clerk and Manager of Legislative Services
Anna Mathewson – General Manager of Community Services
Jeff Moi – General Manager of Engineering and Operations
Angie Parnell – General Manager of Corporate Services
Julie Pavey-Tomlinson – Director of Environment and Parks
Paul Rockwood – General Manager of Finance and Technology
Adam Shroff – Legislative Services Coordinator
Marta Taylor – Manager of Corporate Planning
Wesley Woo – Assistant Manager of Planning

1. Call to Order

Chairperson Agtarap called the meeting to order at 5:05pm.

2. Adoption of the Agenda

2.1 Agenda

CIPC23/048

THAT the agenda of the November 21, 2023, City Initiatives and Planning Committee meeting be adopted as circulated.

CARRIED

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Attachment 2

3. Adoption of Minutes**3.1 Minutes**CIPC23/049

THAT the minutes of the City Initiatives and Planning Committee meeting of October 17, 2023, be adopted.

CARRIED

4. New Business**4.1 Early Input – OCP Amendment, Rezoning, and Development Permit – 2331-2335 St. Johns Street (Cornerstone Architecture)**

Report: Community Development Department – Development Planning Division

Staff gave a presentation entitled "2331-2335 St. Johns Street – OCP Amendment, Rezoning, and Development Permit – Early Input" and referred to slides contained within the on-table package.

Staff answered questions regarding the following topics:

- intersection signalling;
- St. Andrews Street lane width; and
- traffic and pedestrian flow.

Discussion ensued regarding the following topics:

- the need for fresh produce;
- the family-friendly and rental inclusions;
- the green roof;
- the architectural design of the upper floors; and
- the sustainability inclusions.

CIPC23/050

THAT staff and the applicant consider the comments provided during the City Initiatives and Planning Committee meeting held on November 21, 2023, regarding the development application presented in the report dated November 21, 2023, from the Community Development Department – Development Planning Division regarding Early Input – OCP Amendment, Rezoning, and Development Permit – 2331-2335 St. Johns Street (Cornerstone Architecture).

CARRIED

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Attachment 2

4.2 Early Input – OCP Amendment and Rezoning – 60 Williams Street and 3006-3020 Spring Street (PCI Developments)

Report: Community Development Department – Development Planning Division

*Amended by resolution
CIPC24/002*

Councillor Agtarap declared a conflict of interest due to *potential business interests in the subject property* ~~the proximity of their business to the subject area~~ and left the meeting at this point.

Councillor Dilworth assumed the role of Presiding Member at this point.

Staff gave a presentation entitled "60 Williams Street and 3006-3020 Spring Street" and referred to slides contained within the on-table package.

Staff answered questions regarding the following topics:

- the building height in storeys;
- the new OCP and framework in relation to this approval process;
- the location and time restrictions of access to the overpass, and the future impact to developments;
- the density transfer and inclusion in the current site's calculations;
- the City's affordability requirements for rental buildings; and
- the Floor-Area Ratio in relation to other developments in the City.

Discussion ensued regarding the following topics:

- the inclusion of additional native plants and vegetation;
- affordability, below-market, and family-friendly units;
- parking inclusion;
- traffic impacts;
- architecture and the spacing of the buildings;
- the importance of careful design to accommodate density;
- unit mix;
- district energy systems;
- implementation of the overpass;
- consultation with property owners in the area; and
- housing in high-transit infrastructure areas.

CIPC23/051

THAT staff and the applicant consider the comments provided during the City Initiatives and Planning Committee meeting held on November 21, 2023, regarding the development application presented in the report dated November 21, 2023, from the Community Development Department – Development Planning Division regarding Early Input – OCP Amendment and Rezoning – 60 Williams Street and 3006-3020 Spring Street (PCI Developments).

CARRIED

CIPC23/052

THAT staff report back on a revised inclusionary zoning policy that includes 100% rental buildings and review exceptions towards meeting the city's affordable housing needs.

CARRIED

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Attachment 2

5. Rise and Report

5.1 Referral of City Initiatives and Planning Committee Resolutions

Councillor Agtarap returned to the meeting at this point and resumed the role of Presiding Member.

CIPC23/053

THAT the recommendations approved at the City Initiatives and Planning Committee meeting of November 21, 2023, be referred to the Council Standing Committee meeting of November 21, 2023, for ratification.

CARRIED


6. Adjournment

Chairperson Agtarap adjourned the meeting at 6:23pm.

Certified correct on the 20th day of February, 2024, in accordance with section 148(a) of the *Community Charter*.



Councillor S. Agtarap, Chairperson



S. Lam, City Clerk

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Attachment 3

LOCATION MAP - 2331 - 2335 St. Johns Street


 **SUBJECT PROPERTY**



File: M:\Mapping Requests - Internal\LOCATION MAPS - \St. Johns Street\2331-2335 St. Johns Street\2331-2335 St. Johns Street.dwg Last Modified: 2023Apr26

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OCP Land Use Designations - 2331 - 2335 St. Johns Street



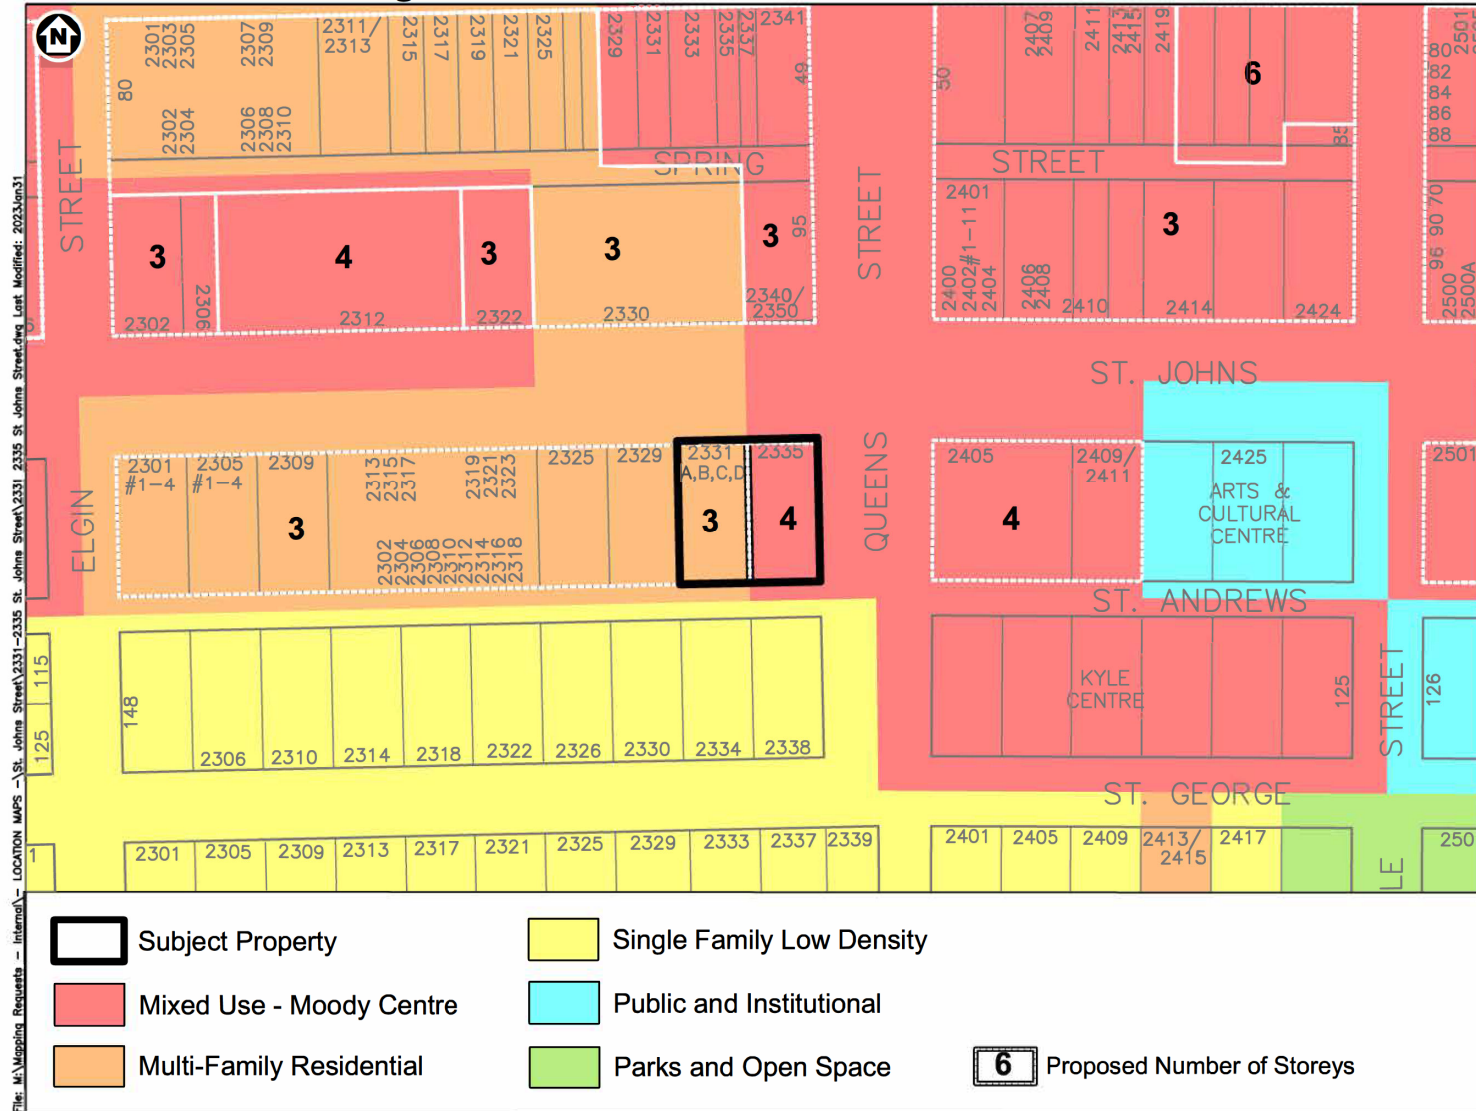

City of Port Moody

Bylaw No. 3471

A Bylaw to amend City of Port Moody Official Community Plan Bylaw, 2014, No. 2955 to change the land use designation on a portion of the subject site at 2331 St. Johns Street from Multi-Family Residential to Mixed Use – Moody Centre and to change the proposed number of storeys for the subject properties at 2331-2335 St. Johns Street and a 5.5-metre-wide portion of Queens Street right-of-way from three (3) and four (4) to six (6) storeys.

The Council of the City of Port Moody enacts as follows:

1. Citation

- 1.1 This Bylaw may be cited as “City of Port Moody Official Community Plan Bylaw, 2014, No. 2955, Amendment Bylaw No. 38, 2024, No. 3471 (2331-2335 St. Johns Street and a 5.5-metre-wide portion of Queens Street right-of-way)”.

2. Amendments

- 2.1 The Official Community Plan Overall Land Use Plan – Map 1 in Schedule “A” of City of Port Moody Official Community Plan Bylaw, 2014, No. 2955 is amended as indicated on Schedule A of this Bylaw, to change the land use designation of the following properties from Multi-Family Residential to Mixed Use – Moody Centre:

Strata Lot 1 District Lot 202 Group 1 New Westminster District Strata Plan NW282 Together With An Interest In The Common Property In Proportion To The Unit Entitlement Of The Strata Lot As Shown On Form 1
PID: 001-257-692

Strata Lot 2 District Lot 202 Group 1 New Westminster District Strata Plan NW282 Together With An Interest In The Common Property In Proportion To The Unit Entitlement Of The Strata Lot As Shown On Form 1
PID: 000-765-040

Strata Lot 3 District Lot 202 Group 1 New Westminster District Strata Plan NW282 Together With An Interest In The Common Property In Proportion To The Unit Entitlement Of The Strata Lot As Shown On Form 1
PID: 001-257-706

Strata Lot 4 District Lot 202 Group 1 New Westminster District Strata Plan NW282 Together With An Interest In The Common Property In Proportion To The Unit Entitlement Of The Strata Lot As Shown On Form 1
PID: 001-257-714

Considered at the July 23, 2024, Regular Council meeting

714

Attachment 5

- 2.2 The Official Community Plan Overall Land Use Plan – Map 11 – Evergreen Line Sub-Areas Map in Schedule “A” of City of Port Moody Official Community Plan Bylaw, 2014, No. 2955 is amended by changing the maximum number of storeys permitted from three and four to six for the following properties as indicated on Map 11 – Evergreen Line Sub-Areas Map, attached to this Bylaw as Schedule B, and on Detail Map, attached to this Bylaw as Schedule C:

Strata Lot 1 District Lot 202 Group 1 New Westminster District Strata Plan NW282 Together With An Interest In The Common Property In Proportion To The Unit Entitlement Of The Strata Lot As Shown On Form 1
PID: 001-257-692

Strata Lot 2 District Lot 202 Group 1 New Westminster District Strata Plan NW282 Together With An Interest In The Common Property In Proportion To The Unit Entitlement Of The Strata Lot As Shown On Form 1
PID: 000-765-040

Strata Lot 3 District Lot 202 Group 1 New Westminster District Strata Plan NW282 Together With An Interest In The Common Property In Proportion To The Unit Entitlement Of The Strata Lot As Shown On Form 1
PID: 001-257-706

Strata Lot 4 District Lot 202 Group 1 New Westminster District Strata Plan NW282 Together With An Interest In The Common Property In Proportion To The Unit Entitlement Of The Strata Lot As Shown On Form 1
PID: 001-257-714

Lot 22 Block 1 District Lot 202 Group 1 New Westminster District Plan 55
PID: 011-453-877

- 2.3 The Official Community Plan Overall Land Use Plan – Map 11 – Evergreen Line Sub-Areas Map in Schedule “A” of City of Port Moody Official Community Plan Bylaw, 2014, No. 2955 is amended by designating the maximum number of six storeys for the 5.5-metre-wide portion of Queens Street right-of-way as indicated on Map 11 – Evergreen Line Sub-Areas Map, attached to this Bylaw as Schedule B, and on Detail Map, attached to this Bylaw as Schedule C.

3. Attachments and Schedules

- 3.1 The following schedules are attached to and form part of this Bylaw:
- Schedule A – Location Map
 - Schedule B – Map 11 – Evergreen Line Sub-Areas Map
 - Schedule C – Detail Map

Considered at the July 23, 2024, Regular Council meeting

715

Attachment 5

4. Severability

4.1 If a portion of this Bylaw is found invalid by a court, it will be severed, and the remainder of the Bylaw will remain in effect.

Read a first time this ___ day of ____, 2024.

Read a second time this ___ day of ____, 2024.

Read a third time this ___ day of ____, 2024.

Adopted this ___ day of ____, 2024.

M. Lahti
Mayor

S. Lam
City Clerk

I hereby certify that the above is a true copy of Bylaw No. 3471 of the City of Port Moody.


S. Lam
City Clerk

Schedule A to Bylaw No. 3471 – Location Map

This is a certified true copy of the map referred to in section 2 of City of Port Moody Official Community Plan Bylaw, 2014, No. 2955, Amendment Bylaw No. 38, 2024, No. 3471 (2331-2335 St. Johns Street and a 5.5-metre-wide portion of Queens Street right-of-way).

Corporate Officer

Land Use Designations 2331-2335 St Johns St

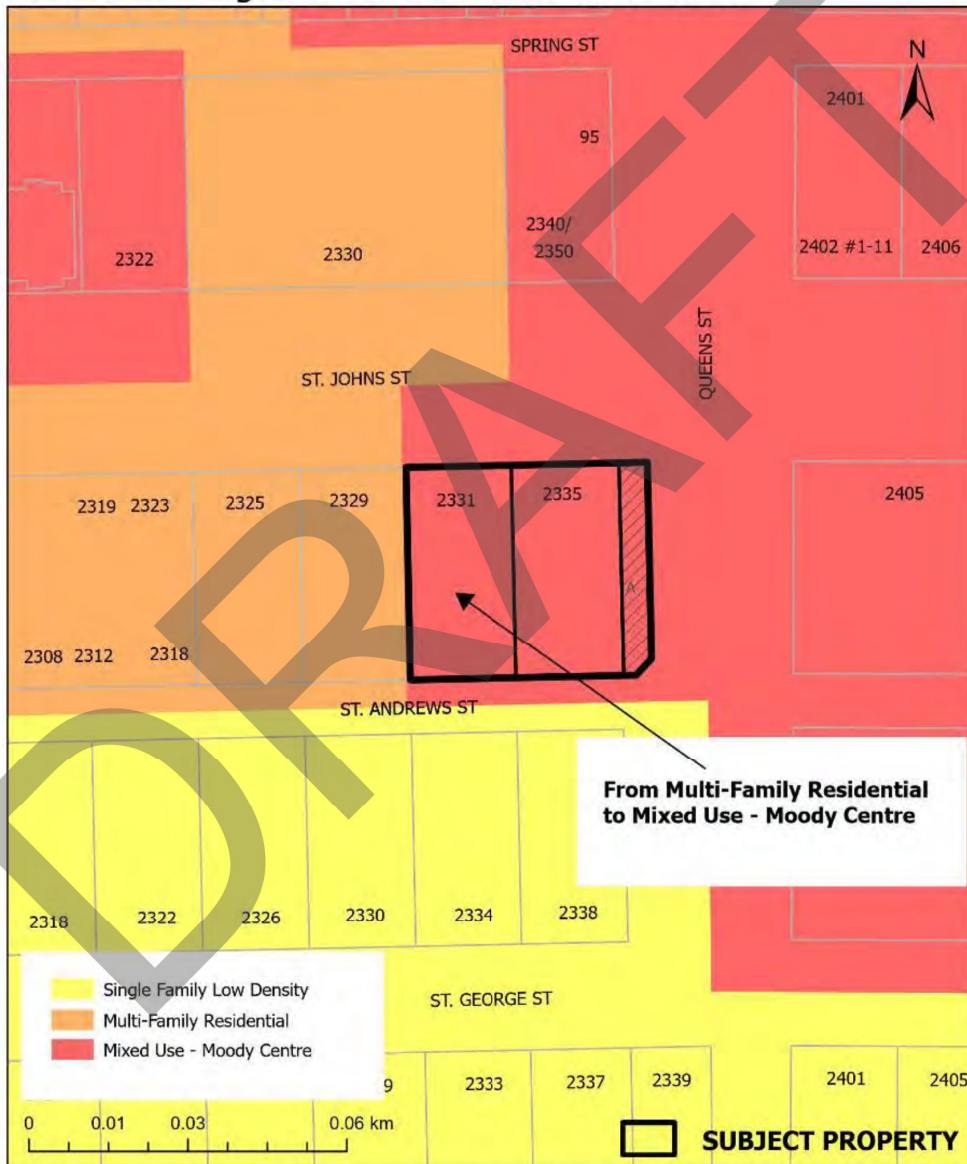


File: M:\Mapping Requests - Internal\LOCATION MAPS (St. Johns Street\2331-2335 St. Johns Street\2331-2335 St. Johns Street - DCP LanduseV2.pdf

Last Modified: 7/9/2024

Considered at the July 23, 2024, Regular Council meeting

Schedule B to Bylaw No. 3471

**DRAFT OFFICIAL
COMMUNITY PLAN
EVERGREEN LINE SUB-AREAS
MAP 11**

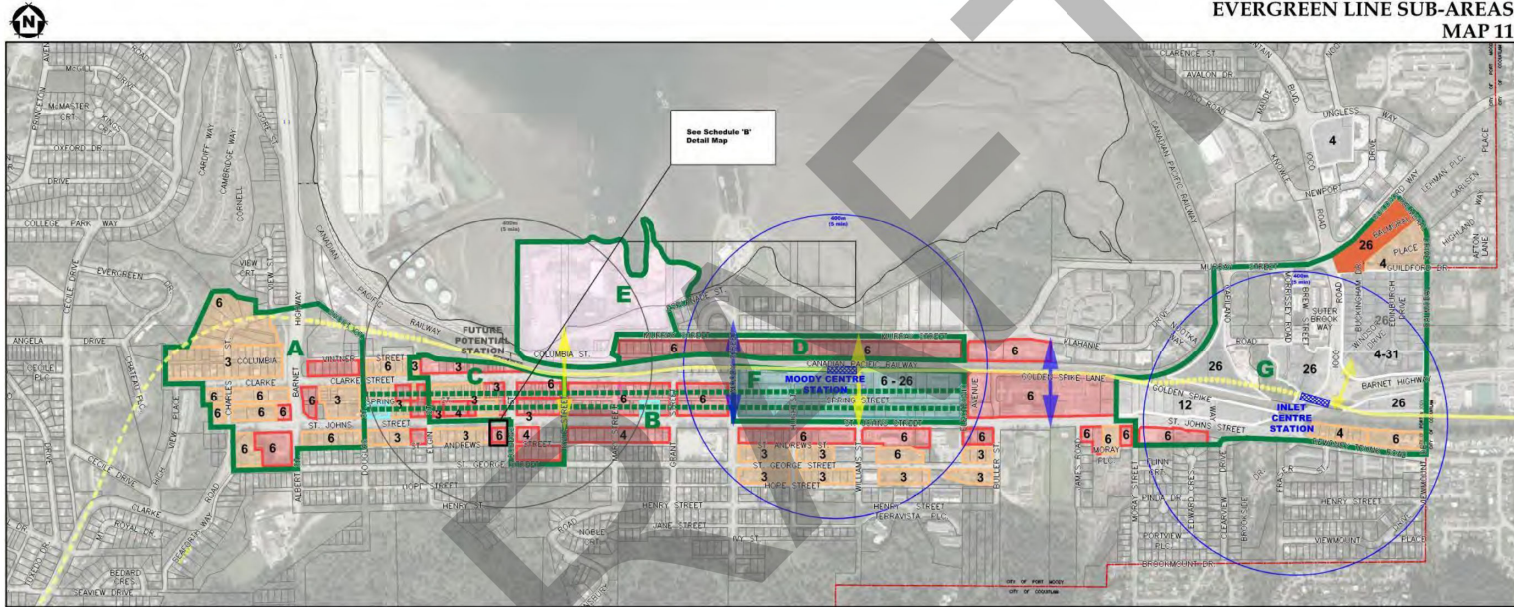

EVERGREEN LINE SUB AREAS

- A** Westport
- B** Spring Street Promenade
- C** Heritage Commercial District
- D** Murray Street Boulevard
- E** Oceanfront District
- F** Moody Centre Station Transit Oriented Development
- G** Inlet Centre Station Transit Oriented Development

LEGEND

- Multi-Family Residential
- High-Rise Residential
- Mixed Use - Inlet Centre
- Mixed Use - Moody Centre
- Moody Centre Station Transit-Oriented Development
- Public and Institutional
- Mixed Employment
- Mixed Use - Oceanfront District
- Evergreen Line - Tunnel
- Evergreen Line - Elevated
- Evergreen Line - Ground Level
- 400m Radius from Station (= 5 min Walk)
- Existing Connections
- Future Connections
- Municipal Boundary

3 Proposed Number of Storeys


The City of Port Moody makes no representation or warranty expressed or implied with respect to the accuracy, completeness or appropriateness of the information contained herein.
Produced by Engineering & Parks Date Plotted: 9-Jul-2024

W:\GCP Map\11 - COMMUNITY PLAN - 2014 GCP\2014 GCP Maps 1 to 17\Map 11 - Evergreen Sub-Areas\MAP 11 - Evergreen Line Sub-Areas_2018 - Copy July 2024.aprx

*NOTES: This map shows the amended locations of the Evergreen Line Stations and Future Potential Station. Evergreen Line projected completion date of 2016.

Considered at the July 23, 2024, Regular Council meeting


Schedule C to Bylaw No. 3471 – Detail Map

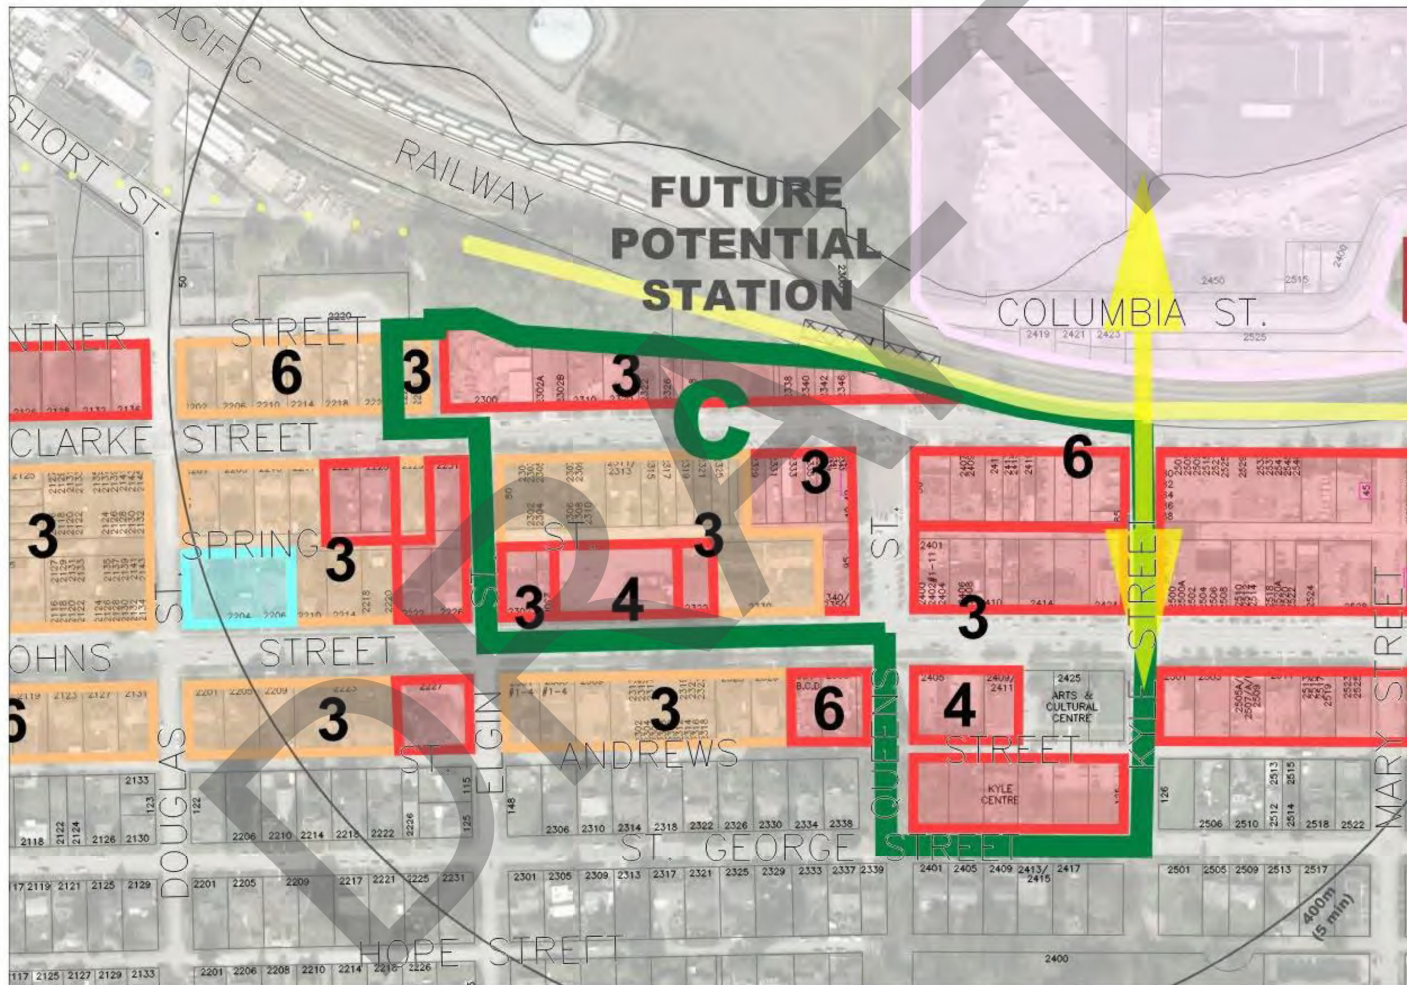

Considered at the July 23, 2024, Regular Council meeting

ZONING MAP - 2331 - 2335 St. Johns Street

 SUBJECT PROPERTY

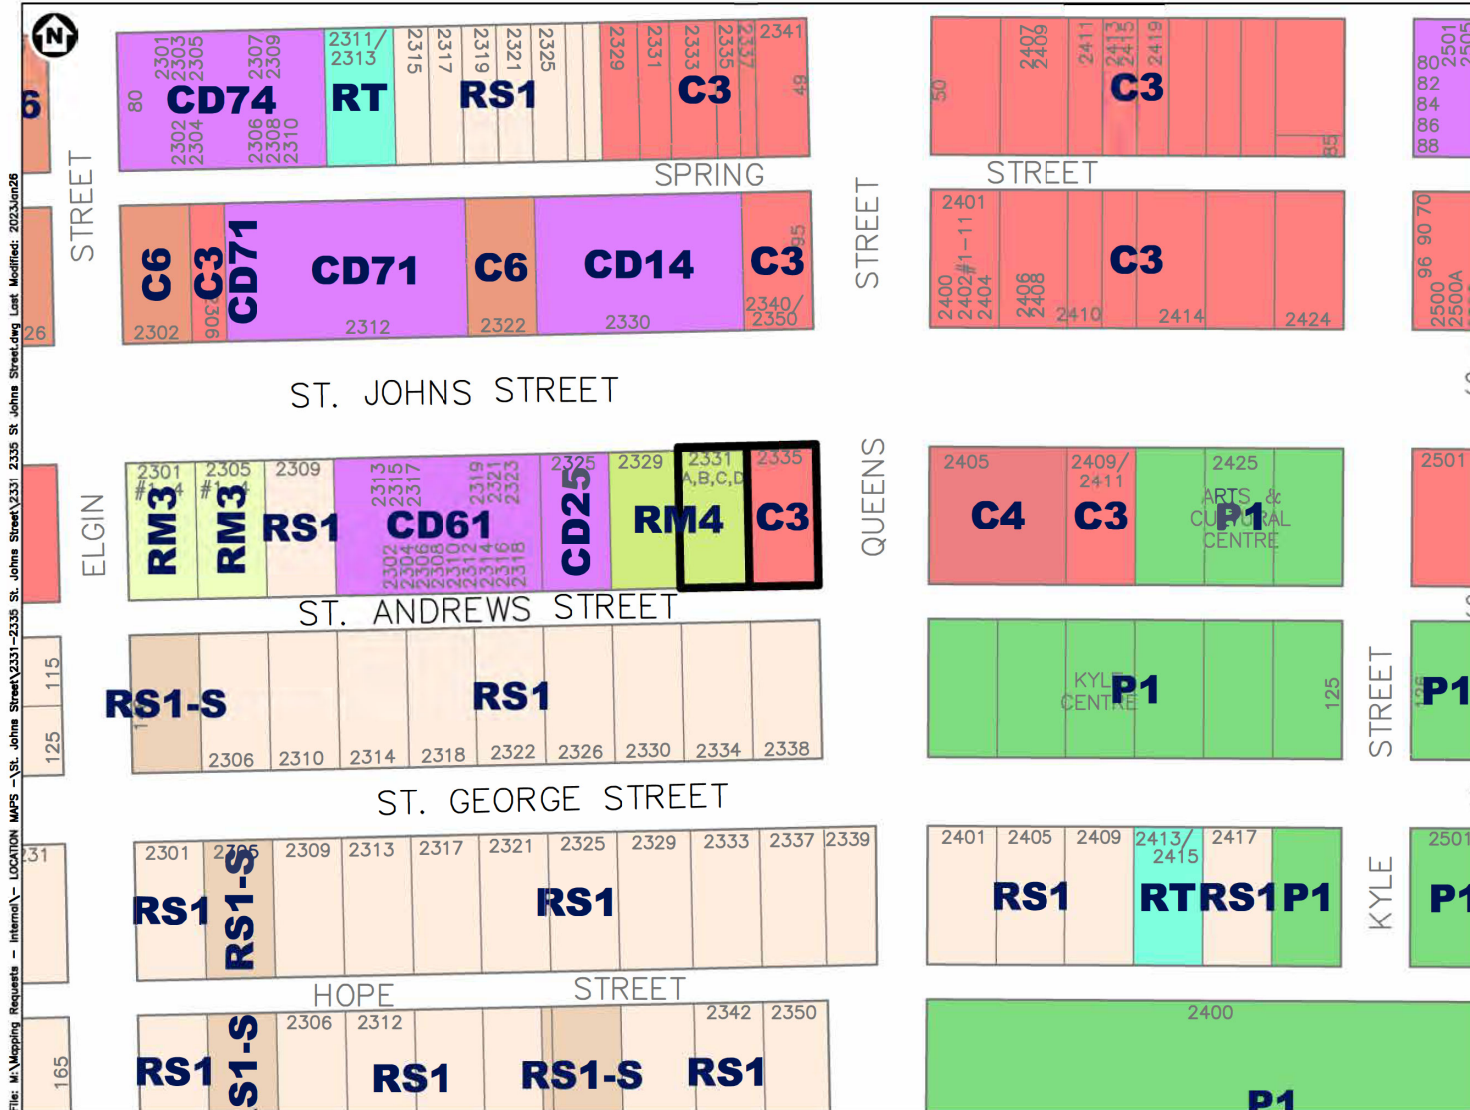

File: M:\Mapping Requests - Internal\ - LOCATION MAPS - St. Johns Street\2331-2335 St. Johns Street\2331-2335 St. Johns Street.dwg Last Modified: 2023 Jun 26



City of Port Moody

Bylaw No. 3470

A Bylaw to amend City of Port Moody Zoning Bylaw, 2018, No. 2937 to facilitate the development of a mixed-use residential/commercial building at 2331-2335 St. Johns Street and a 5.5-metre-wide portion of Queens Street right-of-way.

The Council of the City of Port Moody enacts as follows:

1. Citation

- 1.1 This Bylaw may be cited as “City of Port Moody Zoning Bylaw, 2018, No. 2937, Amendment Bylaw No. 97, 2024, No. 3470 (2331-2335 St. Johns Street and a 5.5-metre-wide portion of Queens Street right-of-way) (CD97)”.

2. Amendments

- 2.1 City of Port Moody Zoning Bylaw, 2018, No. 2937, is amended by rezoning the following lands from Medium Density Townhouse Residential (RM4) to Comprehensive Development Zone 97 (CD97):

Strata Lot 1 District Lot 202 Group 1 New Westminster District Strata Plan NW282 Together With An Interest In The Common Property In Proportion To The Unit Entitlement Of The Strata Lot As Shown On Form 1
PID: 001-257-692

Strata Lot 2 District Lot 202 Group 1 New Westminster District Strata Plan NW282 Together With An Interest In The Common Property In Proportion To The Unit Entitlement Of The Strata Lot As Shown On Form 1
PID: 000-765-040

Strata Lot 3 District Lot 202 Group 1 New Westminster District Strata Plan NW282 Together With An Interest In The Common Property In Proportion To The Unit Entitlement Of The Strata Lot As Shown On Form 1
PID: 001-257-706

Strata Lot 4 District Lot 202 Group 1 New Westminster District Strata Plan NW282 Together With An Interest In The Common Property In Proportion To The Unit Entitlement Of The Strata Lot As Shown On Form 1
PID: 001-257-714

as shown on the map in Schedule A of this Bylaw.

Considered at the July 23, 2024, Regular Council meeting

721

Attachment 7

- 2.2 City of Port Moody Zoning Bylaw, 2018, No. 2937, is further amended by rezoning the following land from General Commercial (C3) to Comprehensive Development Zone 97 (CD97):

Lot 22 Block 1 District Lot 202 Group 1 New Westminster District Plan 55
PID: 011-453-877

- 2.3 City of Port Moody Zoning Bylaw, 2018, No. 2937, is further amended by rezoning the 5.5-metre-wide portion of Queens Street right-of-way from unzoned to Comprehensive Development Zone 97 (CD97) as shown on the map in Schedule A of this Bylaw.

- 2.4 City of Port Moody Zoning Bylaw, 2018, No. 2937 is further amended by adding the following section CD97 to Schedule D:

“CD97. Comprehensive Development Zone (CD97)

CD97.1 Intent

The intent of this zone is to accommodate a six-storey mixed-use commercial/residential development with a rooftop garden on the subject lands.

CD97.2 Permitted Uses

The following uses are permitted:

CD97 Zone	
a. Principal Use	i. Assembly ii. Child Care iii. Civic iv. Commercial Athletic and Recreation v. Community Care vi. Office vii. Personal Service viii. Restaurant ix. Retail Food Service x. Retail xi. Multi-Residential, limited to Market Rental
b. Secondary Use	i. Home Occupation – Type A

CD97.3 Conditions of Use

- (a) Due to the sloping nature of the site, the lowest commercial level of the Building facing St. Johns Street is a “basement” by Zoning Bylaw definition.
- (b) Commercial uses are only permitted on the ground floor along St. Johns Street and the mezzanine of the Building.

Considered at the July 23, 2024, Regular Council meeting

722

Attachment 7

CD97.4 Lot Coverage

The maximum permitted lot coverage shall be 90.5%.

CD97.5 Residential Density

No more than 48 market rental residential dwelling units shall be permitted.

CD97.6 Floor Area Ratio (FAR)

The Floor Space Ratio permitted in the CD97 Zone shall be calculated in accordance with section 5.3.4 of the Zoning Bylaw and the maximum permitted Floor Area Ratio shall be 2.63 based on the developable site area, including the road allowance as shown in schedule A.

CD97.7 Building Height

- (a) Building height shall not exceed 6 storeys, excluding basement and all roof projections.
- (b) The maximum height of the Building shall not exceed 23.5m, including enclosed rooftop common amenity structure and all rooftop projections.

CD97.8 Setbacks

- (a) Front: 0m;
- (b) Rear: 0m;
- (c) Exterior Side: 1.1m; and
- (d) Interior Side: 1.3m.

CD97.9 Parking, loading, and Bicycle Parking

- (a) A minimum of 81 off-street Parking Spaces shall be provided for all uses combined, with 53 residential designated parking spaces, minimum 22 commercial ones, and at least 5 visitor-designated parking spaces;
- (b) A minimum of 73 Long-Term Bicycle Parking Spaces.
- (c) 6 Short-Term Bicycle Parking Spaces shall be provided for residential portion.
- (d) 1 Long-Term Bicycle Parking Spaces and 6 Short-Term Bicycle Parking Spaces shall be provided for commercial portion.
- (e) One vehicular access shall be permitted from Queens Street for commercial area.
- (f) One vehicular access shall be permitted from St. Andrews Street for residential area.
- (g) A minimum of one loading bay shall be provided for commercial area.

Considered at the July 23, 2024, Regular Council meeting

723

Attachment 7

CD97.10 Landscaping

Refer to section 5.2.10 of this Bylaw for landscaping requirements.

CD97.11 Common Amenity Space

Amenity spaces in the CD97 Zone shall be in accordance with the following:

- (a) Common Amenity Structures on the rooftop of the building shall not count as a Storey.
- (b) Outdoor Common Amenity Spaces shall not be located within the setbacks.
- (c) The maximum amount of indoor rooftop amenity area is 132.85m².
- (d) The maximum amount of outdoor rooftop amenity area is 363.81m².
- (e) Common amenity structures (including both enclosed and unenclosed area) on the rooftops of the building, excluding roof circulation, shall be limited to a combined total of no more than 50.85% of the Floor Area of the Storey below.
- (f) The enclosed portion of the rooftop common amenity area shall not occupy more than 13.60% of the Floor Area of the Storey below, excluding roof circulation.
- (g) Notwithstanding the above, a separate outdoor amenity space dedicated for a children's play area shall be provided in the minimum amount of 128.76m².

3. Attachments and Schedules

3.1 The following schedules are attached to and form part of this Bylaw:

- Schedule A – Location Map.

4. Severability

4.1 If a portion of this Bylaw is found invalid by a court, it will be severed, and the remainder of the Bylaw will remain in effect.

Read a first time this ___ day of _____, 2024.

Read a second time this ___ day of _____, 2024.

Read a third time this ___ day of _____, 2024.

Adopted this ___ day of _____, 2024.

Considered at the July 23, 2024, Regular Council meeting

724

Attachment 7

M. Lahti
Mayor

S. Lam
City Clerk

I hereby certify that the above is a true copy of Bylaw No. 3470 of the City of Port Moody.

S. Lam
City Clerk

DRAFT

Considered at the July 23, 2024, Regular Council meeting


725

Attachment 7

Schedule A – Location Map

This is a certified true copy of the map referred to in section 2 of City of Port Moody Zoning Bylaw, 2018, No. 2937, Amendment Bylaw No. 97, 2024, No. 3470 (2331-2335 St. Johns Street and a 5.5-metre-wide portion of Queens Street right-of-way) (CD97).

Corporate Officer

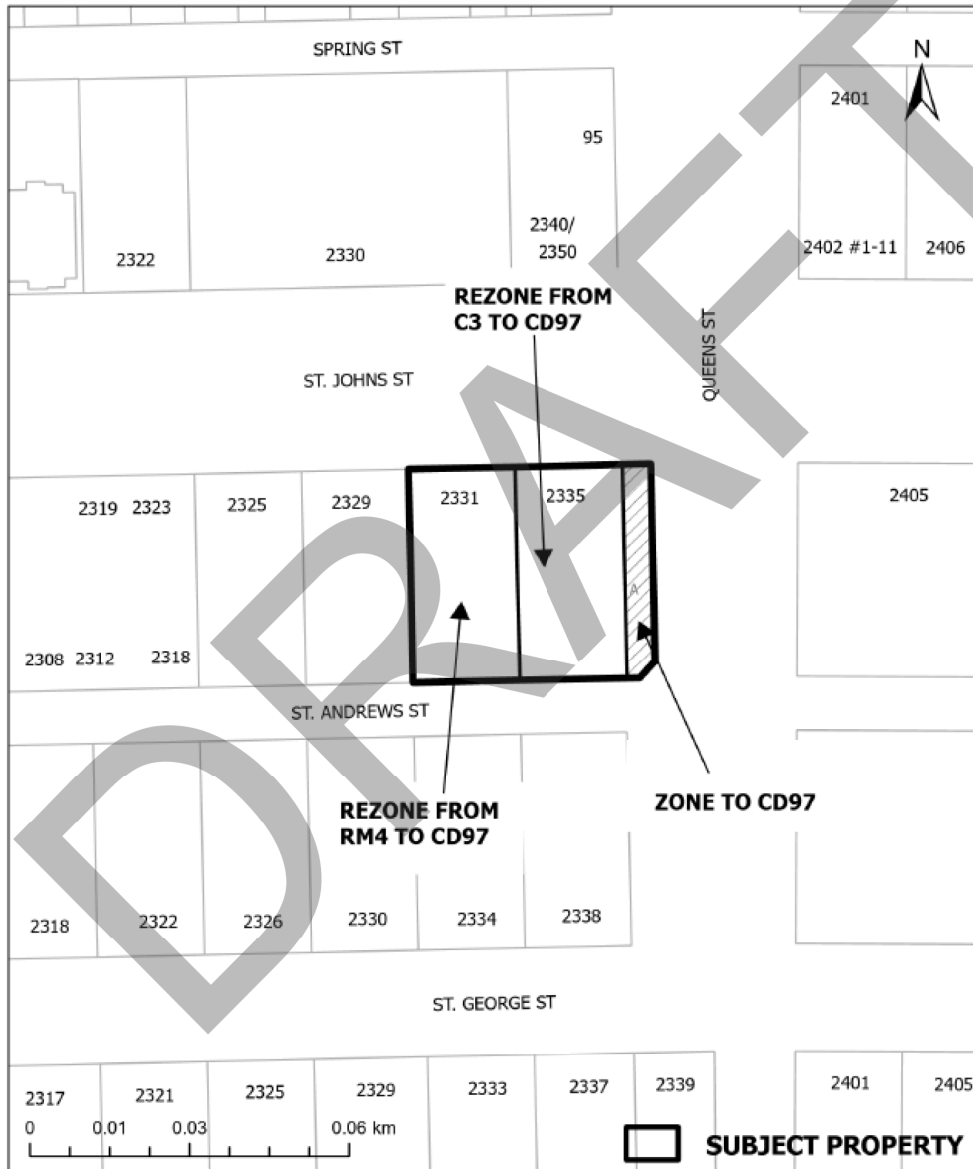

File: M:\Mapping Requests - Internal\LOCATION MAPS - I\St. Johns Street\2331-2335 St. Johns Street\2331-2335 St. Johns Street - Zoning Map V2.pdf

Last Modified: 7/9/2024

Considered at the July 23, 2024, Regular Council meeting

LEGAL: PLAN OF SURVEY OF PROPOSED LOT A, FORMERLY STRATAPLAN NW287 AND LOT 22, BLOCK 1, PLAN 55, BOTH OF DISTRICT LOT 202, GROUP 1, NEW WESTMINSTER DISTRICT



2335 St Johns MIXED-USE RESIDENTIAL DEVELOPMENT 2331, 2335 ST. JOHNS STREET PID(s): 001-257-706

Table with columns: Occupant Loads, Storey, Use, Factor per unit, Quantity, Units, Persons, and various dimensions. Includes a table for occupant loads in worst-case scenarios.



Site Contour Scale: 1/64" = 1'-0"

Owner: Benedet Properties (St Johns) Ltd. Building Envelope: Kan K. Wong & Associates. Geotechnical: Geopacific Consultants Ltd. Mechanical: Rocky Point Engineering. Architectural: Cornerstone Architecture. Surveyor: MPT Engineering Co. Ltd. Landscape: Prospect & Refuge. Fire Suppression: Rocky Point Engineering. Electrical: Weiler Smith Bowers.



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Table with columns: Drawing List, Sheet Number, Title, and Description. Lists various drawing sheets from A0.0 to A8.7.

Main table with columns: Unit Type, Quantity, Distribution, Area (sqft), Commercial, Residential, Common, Wall exclusion, Garbage exclusion, Amenity exclusion, Adaptable exclusion, HRV exclusion. Includes sub-tables for Ground Level, Mezzanine/P2 Parkade, P1 Parkade, and Roof Residential.


Table with columns: Date, Description, and Action. Lists revision dates and descriptions for the drawing.

PROJECT: Bosa Foods 2335 St Johns St

BUILDING CODE: BCRC 2018 DEVELOPMENT PERMIT #: RM, C3 BUILDING PERMIT #:

DRAWING: Cover Sheet and Statistics

Scale: 1/8" = 1'-0" (unless noted otherwise) PLOT DATE: Jun 14, 2024 PROJECT NO: 2119 DRAWING NO: A0.0

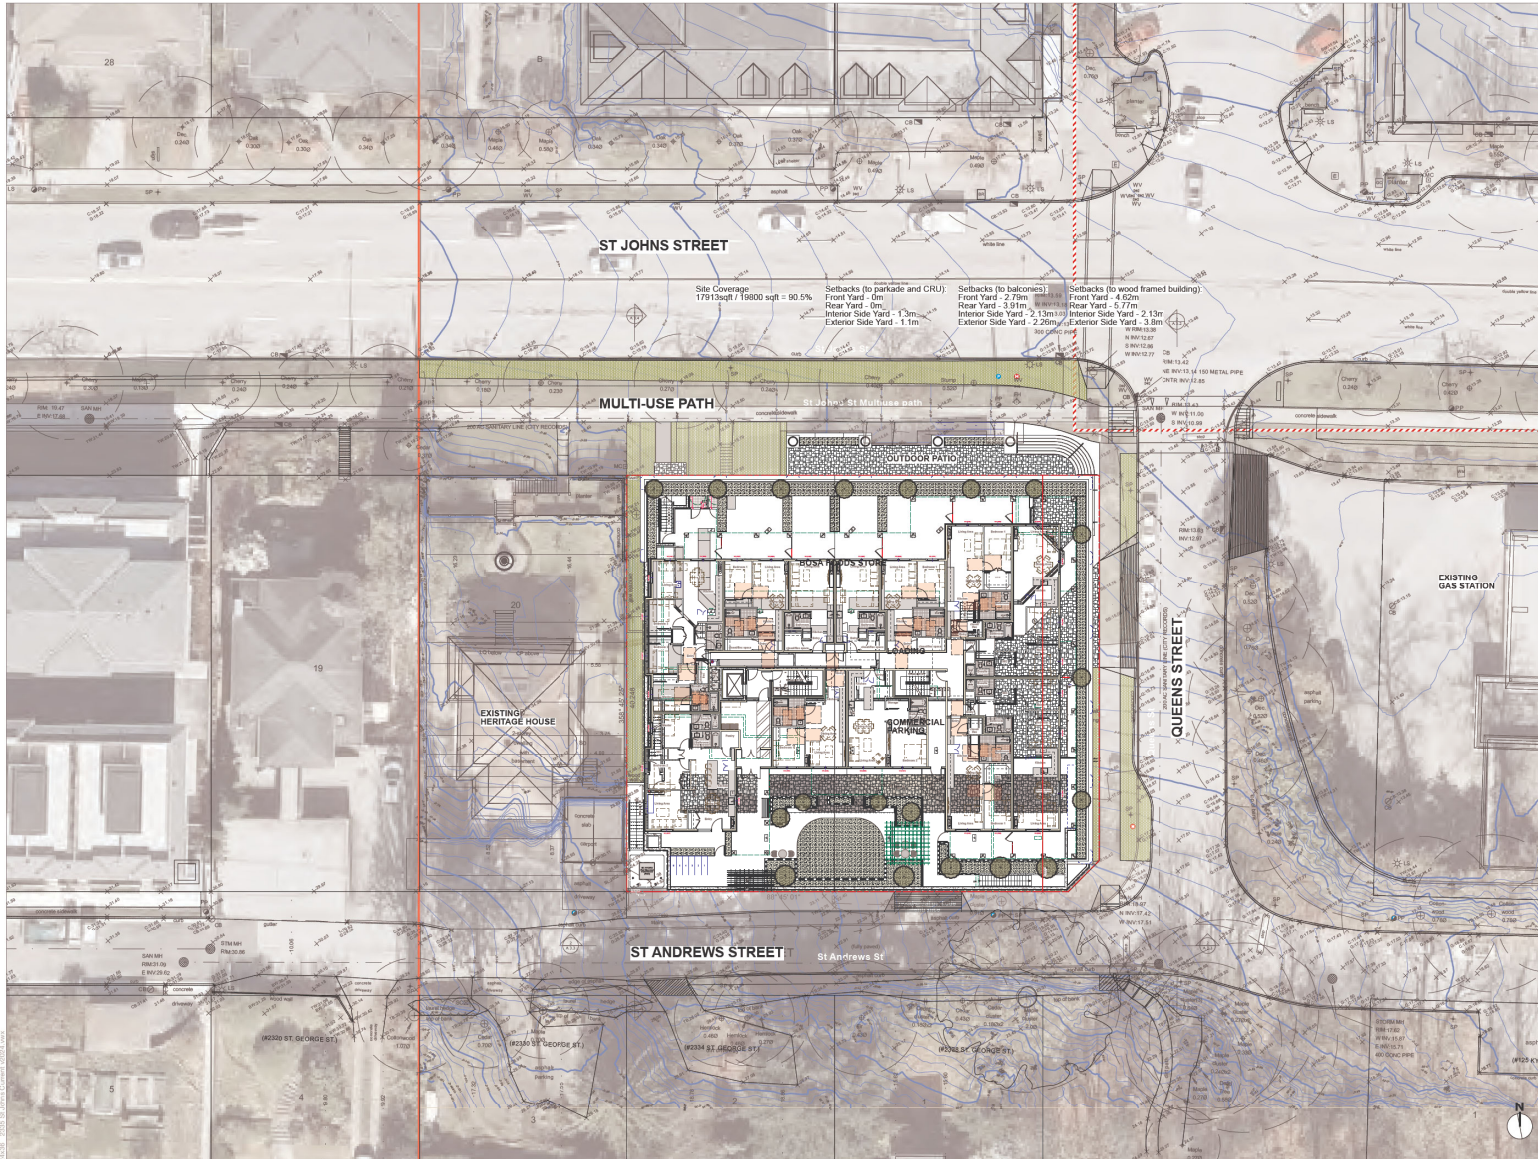

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Num.	YY MM DD	ISSUE / REVISION
7	2024-06-14	Re-issue for CP Application
6	2024-03-22	Re-issue for CP Application
5	2023-06-19	Issue for CP Application
4	2023-06-05	Issue for Review
3	2023-04-18	Issue for Review
2	2022-11-07	Issue for Preliminary CP Application
1	2022-09-05	Issue for Review

PROJECT
Bosa Foods
 2335 St Johns St


BUILDING CODE: BCRC 2018
 ZONING: RM4, C3
 DEVELOPMENT PERMIT #
 BUILDING PERMIT #

DRAWING
Site Plan

Scale: 1/16" = 1'-0" (unless noted otherwise)

PLLOT DATE: Jun 14, 2024

PROJECT NO. 2119
 DRAWING NO. A1.0

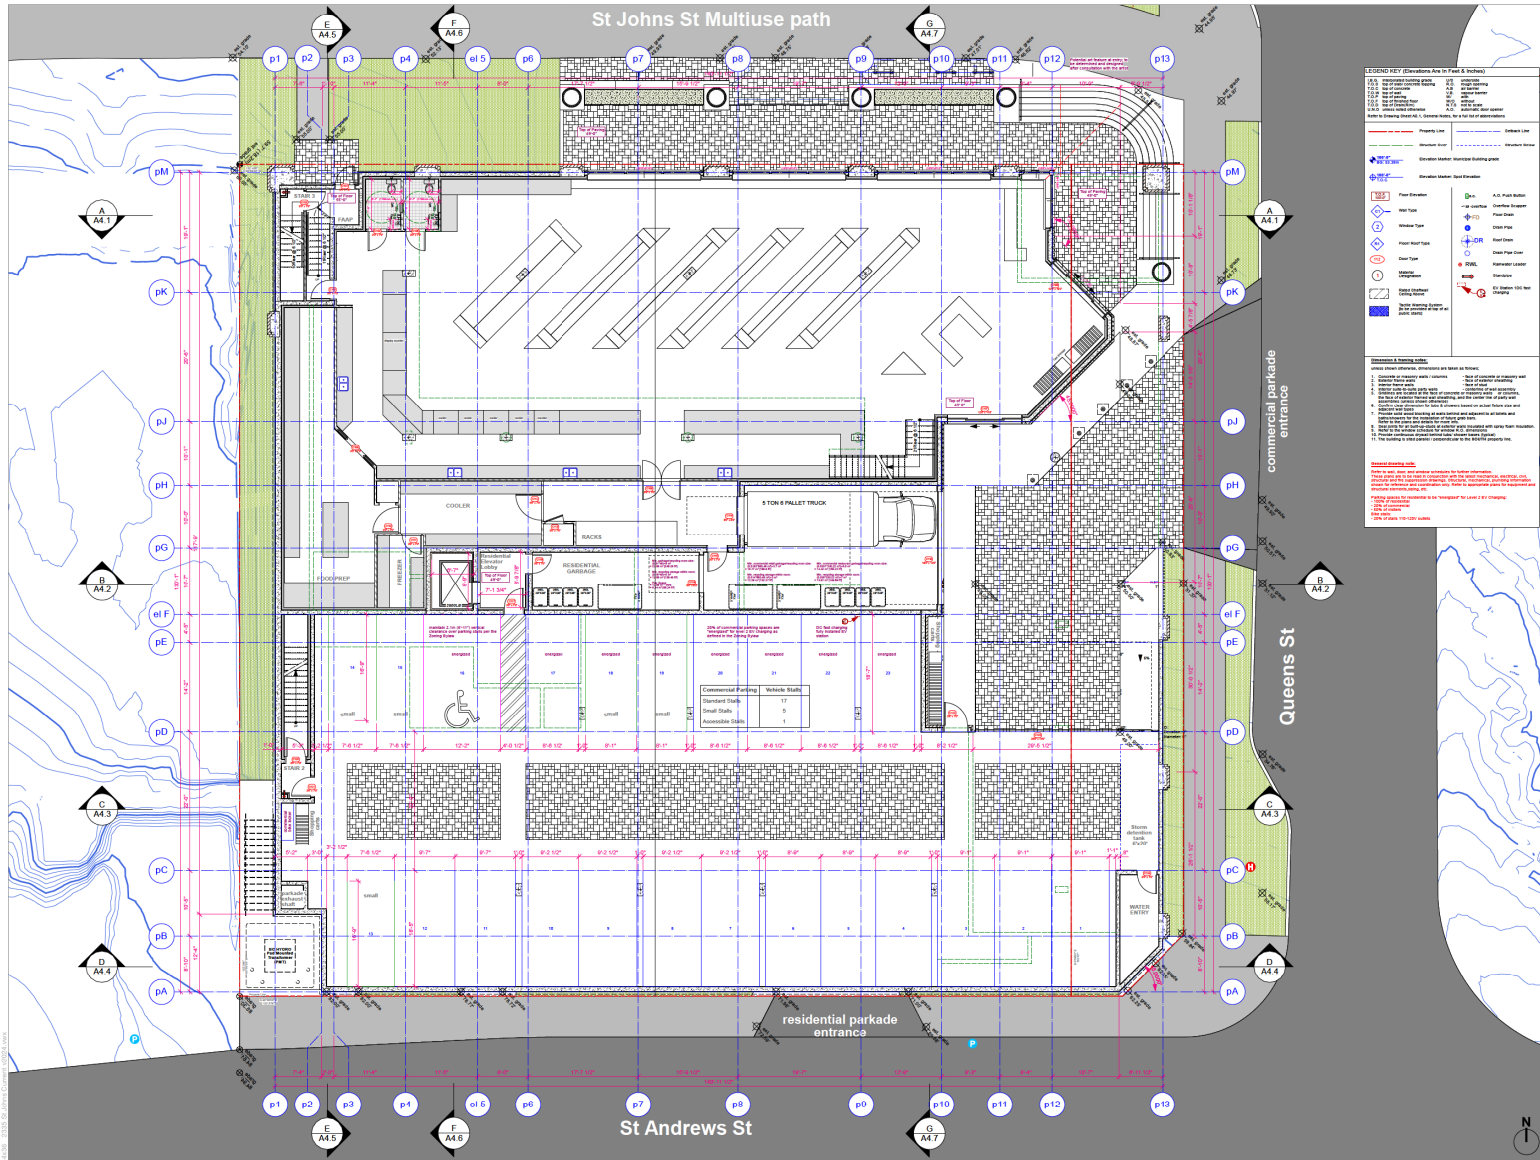

CORNERSTONE
architecture

307 - 811 Alexander Street
Toronto, Ontario, Canada M4A 1E1
Tel: 416-593-8888
www.cornerstonearch.com

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Prior to commencement of the Work, it is the Contractor's responsibility to review and verify drawing dimensions, materials and levels. Discrepancies between information on the drawing and actual site conditions and/or the remaining Contract Documents shall be brought to the attention of the Architect for clarification prior to proceeding with the Work. **DO NOT SCALE THE DRAWINGS.**

REVISIONS & ISSUES LOG

Rev.	YY MM DD	ISSUE / REVISION
7	2024-06-14	Re-issue for OP Application
6	2024-03-22	Re-issue for OP Application
5	2023-08-19	Issue for OP Application
4	2023-06-05	Issue for Review
3	2023-04-18	Issue for Review
2	2022-11-07	Issue for Preliminary OP Application
1	2022-09-05	Issue for Review

PROJECT
Bosa Foods
2335 St Johns St


BUILDING CODE BCRC 2018
ZONING RM, C3
DEVELOPMENT PERMIT #
BUILDING PERMIT #

DRAWING
Ground level
commercial

SCALE 1/8" = 1'-0" (unless noted otherwise)

PLOT DATE Jun 14, 2024

PROJECT NO. 2119
DRAWING NO. A2.1

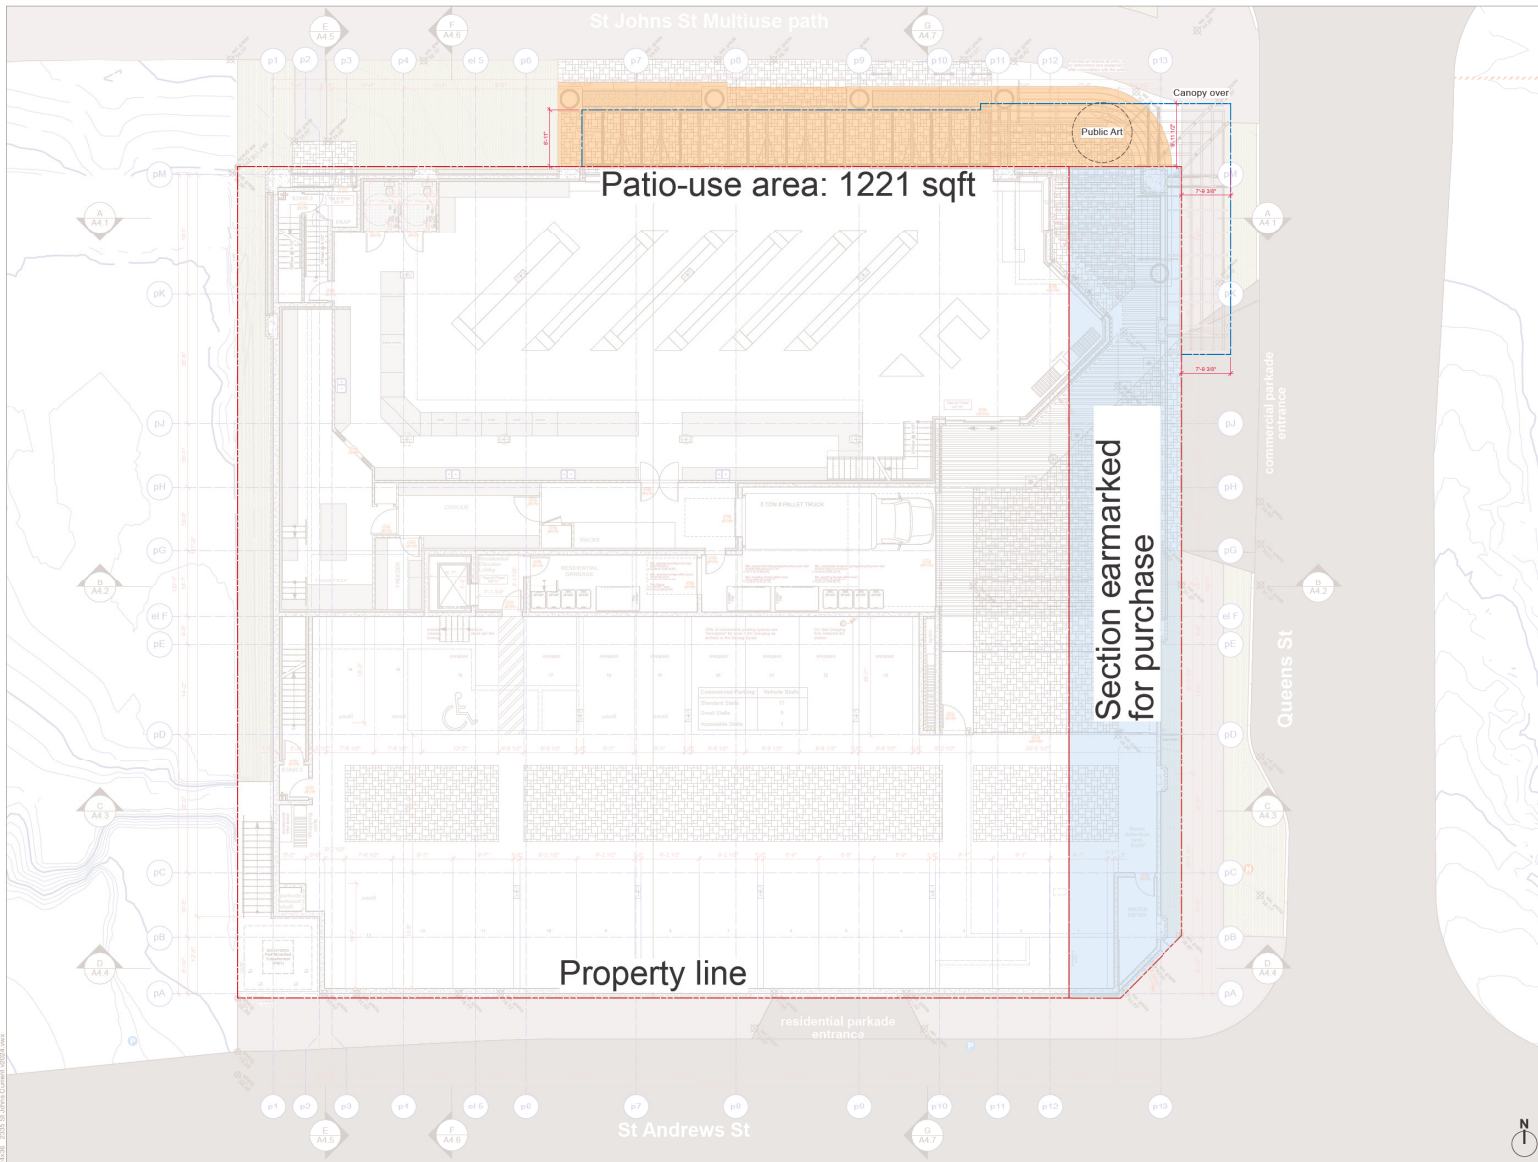

CORNERSTONE
architecture

307-811 Alexander Street
Toronto, Ontario, Canada
M5A 1K1
www.cornerstone.ca
Tel: 904-255-8800

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Prior to commencement of the Work, it is the Contractor's responsibility to review and verify drawing dimensions, details and levels. Discrepancies between information on this drawing and actual site conditions and/or the remaining Contract Documents shall be brought to the attention of the Architect for clarification prior to proceeding with the Work. **DO NOT SCALE THE DRAWINGS.**

Num.	YY MM DD	ISSUE / REVISION
7	2024-05-14	File Issue for DP Application
5	2023-05-15	Issue for DP Application
4	2023-05-05	Issue for Review
3	2023-01-18	Issue for Review
2	2022-11-07	Issue for Preliminary DP Application
1	2022-09-05	Issue for Review

PROJECT
Bosa Foods
2335 St Johns St


BUILDING CODE: BCRC 2018
ZONING: RM4, C3
DEVELOPMENT PERMIT #
BUILDING PERMIT #

DRAWING
Level 1 Patio use

SCALE: 1/8" = 1'-0" (unless noted otherwise)

PLOT DATE: Jun 14, 2024

PROJECT NO. 2119
DRAWING NO. **A2.1.1**

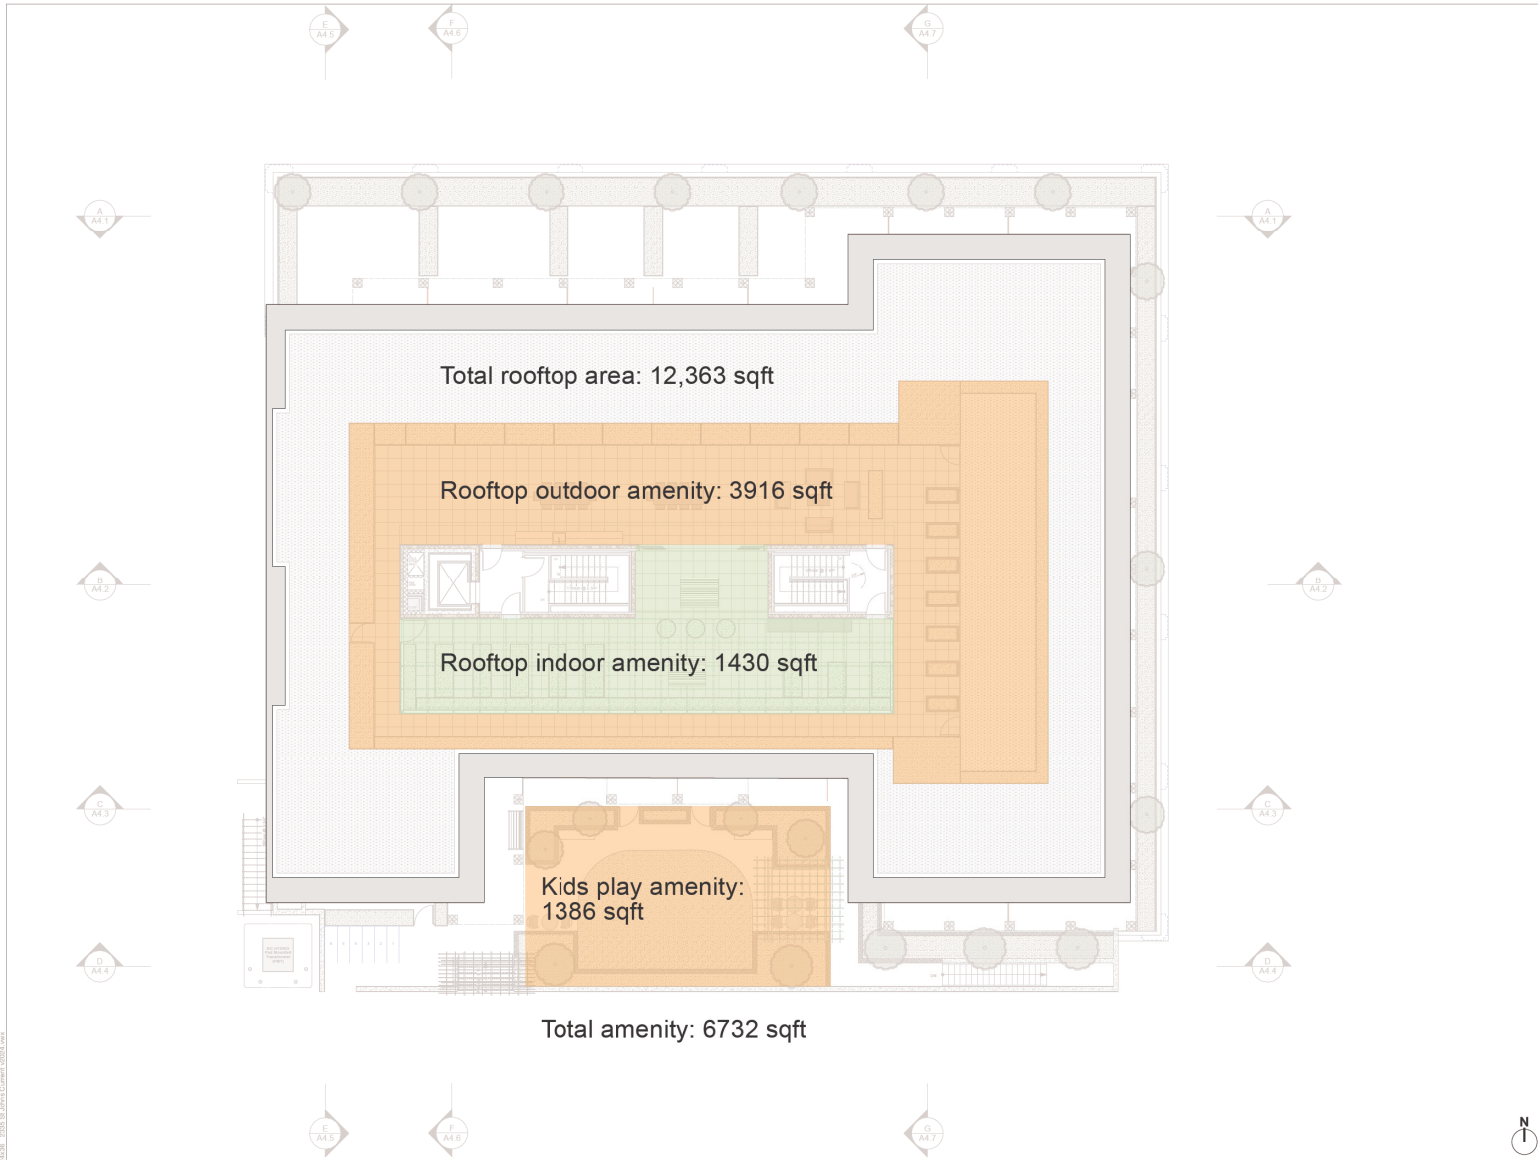

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416-255-8800

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Num.	YY MM DD	ISSUE / REVISION
7	2024-05-14	Re-issue for DP Application
5	2023-05-15	Issue for DP Application
4	2023-05-05	Issue for Review
3	2023-04-18	Issue for Review
2	2022-11-07	Issue for Preliminary DP Application
1	2022-09-05	Issue for Review

PROJECT
Bosa Foods
2335 St Johns St

BUILDING CODE: BCRC 2018
ZONING: RM4, C3
DEVELOPMENT PERMIT #
BUILDING PERMIT #

DRAWING
Amenity Area


SCALE: 1/8" = 1'-0" (unless noted otherwise)

PLOT DATE: Mar 9, 2023

PROJECT NO. 2119
DRAWING NO. **A2.1.2**



2335 St Johns Street, Cornerstone Architecture

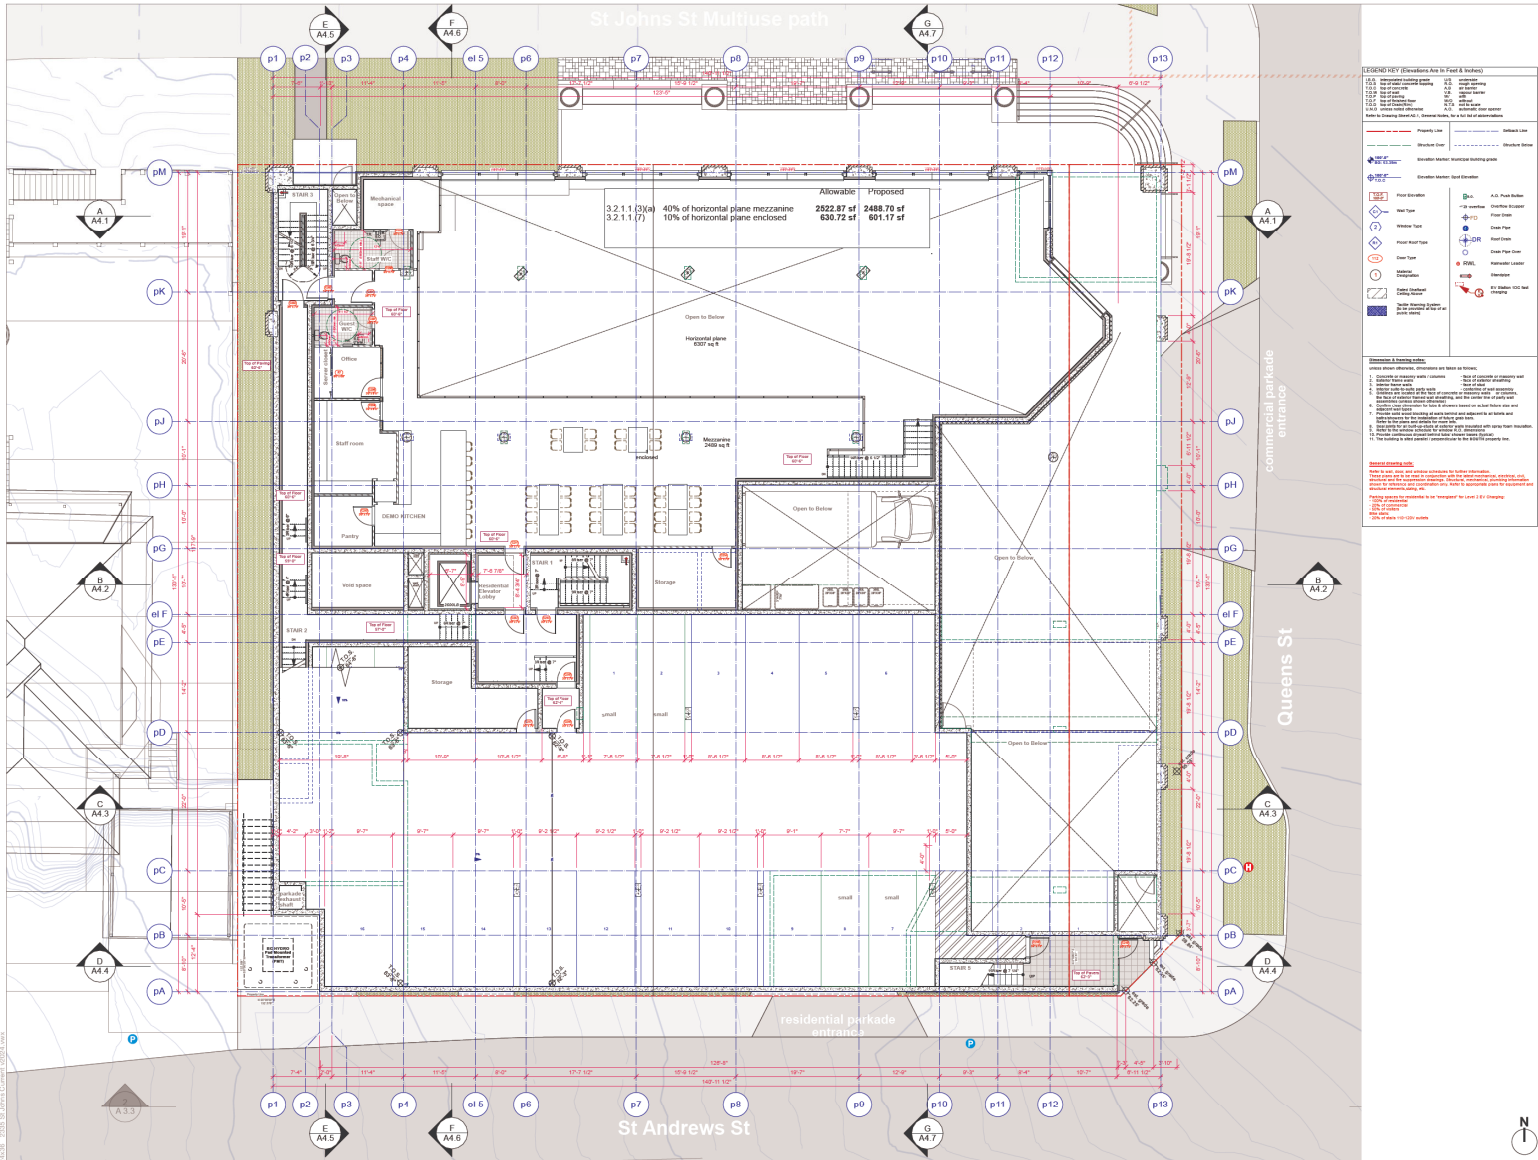

307-811 Alexander Street
 Toronto, ON M5G 1E1
 www.cornerstonearch.com
 Tel: 416-225-8800

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 Prior to commencement of the Work, it is the Contractor's responsibility to review and verify drawing dimensions, details and levels. Discrepancies between information on this drawing and actual site conditions and/or the remaining Contract Documents shall be brought to the attention of the Architect for clarification prior to proceeding with the Work. **DO NOT SCALE THE DRAWINGS.**

- 1. Coordinate with Client
- 2. Coordinate with Engineer
- 3. Coordinate with City
- 4. Coordinate with Fire Department
- 5. Coordinate with Planning Department
- 6. Coordinate with Public Works
- 7. Coordinate with Traffic Department
- 8. Coordinate with Police Department
- 9. Coordinate with Fire Department
- 10. Coordinate with Fire Department
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- 15. Coordinate with Fire Department
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- 17. Coordinate with Fire Department
- 18. Coordinate with Fire Department
- 19. Coordinate with Fire Department
- 20. Coordinate with Fire Department

Rev.	Date	Description
1	2024-08-01	Issue for Review
2	2024-08-01	Issue for Review
3	2024-08-01	Issue for Review
4	2024-08-01	Issue for Review
5	2024-08-01	Issue for Review
6	2024-08-01	Issue for Review
7	2024-08-01	Issue for Review

Rev.	Date	Description	By	App.
1	2024-08-01	Issue for Review		
2	2024-08-01	Issue for Review		
3	2024-08-01	Issue for Review		
4	2024-08-01	Issue for Review		
5	2024-08-01	Issue for Review		
6	2024-08-01	Issue for Review		
7	2024-08-01	Issue for Review		

PROJECT
 Bosa Foods
 2335 St Johns St

BUILDING CODE: BCRC 2018
DEVELOPMENT PERMIT #: RMA, C3
BUILDING PERMIT #:


DRAWING
 Mezzanine / Residential P2

Unless specified, all notes, floor elevations and levels shall be in reference to the datum as shown on the site plan. All dimensions are in feet and inches unless otherwise specified.

SCALE: 1/8" = 1'-0" (unless noted otherwise)

PLOT DATE: Mar 9, 2023

PROJECT NO.: 2119
DRAWING NO.: A2.2

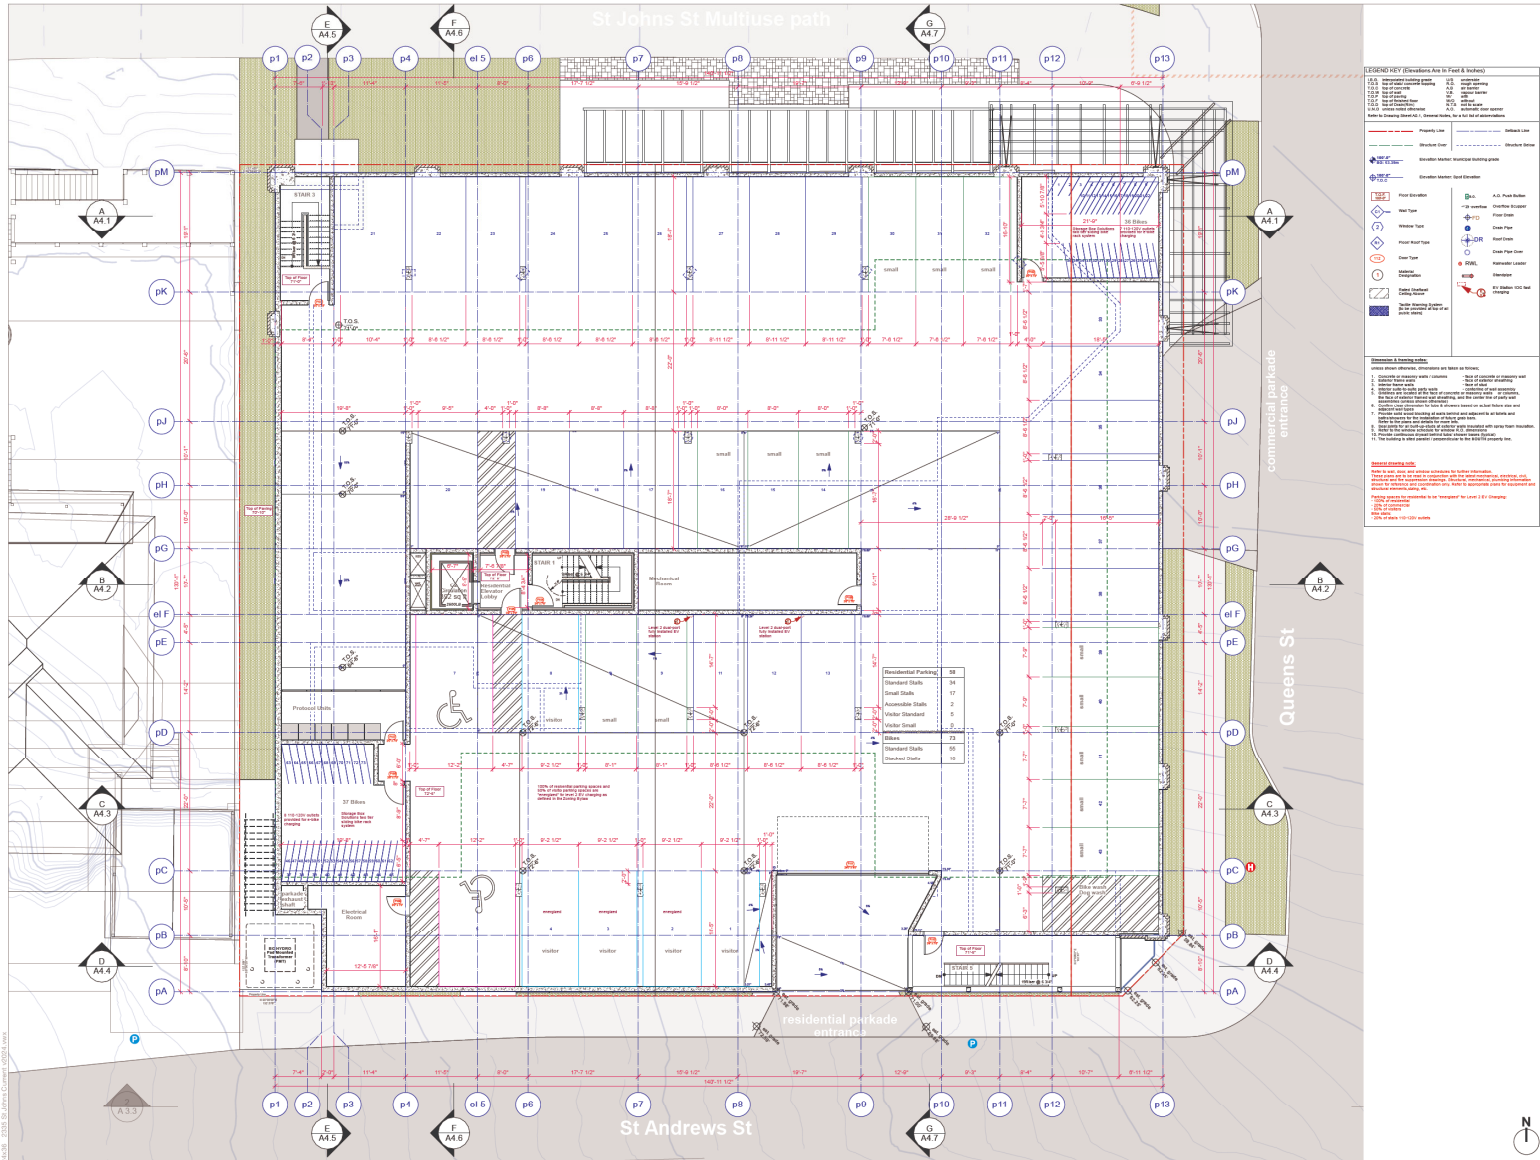

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Prior to commencement of the Work, it is the Contractor's responsibility to review and verify drawing dimensions, details and levels. Discrepancies between information on this drawing and actual field conditions and/or the remaining Contract Documents shall be brought to the attention of the Architect for clarification prior to proceeding with the Work. DO NOT SCALE THE DRAWINGS.

7	2024-06-14	Re-Issue for CP Application
6	2024-03-22	Re-issue for CP Application
5	2023-05-19	Issue for CP Application
4	2023-06-05	Issue for Review
3	2023-01-19	Issue for Review
2	2022-11-07	Issue for Preliminary CP Application
1	2022-09-05	Issue for Review

Num. YY MM DD **▲** ISSUE / REVISION ▼

PROJECT
Bosa Foods
 2335 St Johns St

BUILDING CODE: BCRC 2018
 ZONING: DEVELOPMENT PERMIT # RM4, C3
 BUILDING PERMIT #


DRAWING
**Residential P1
 Parkade**

Issue/Revision Control: These drawings are to be approved by the architect and not to be altered by a client or third party without the prior written consent of the architect.

SCALE: 1/8" = 1'-0" (unless noted otherwise)

PLOT DATE: Mar 9, 2023

PROJECT NO.: 2119 DRAWING NO.: **A2.3**

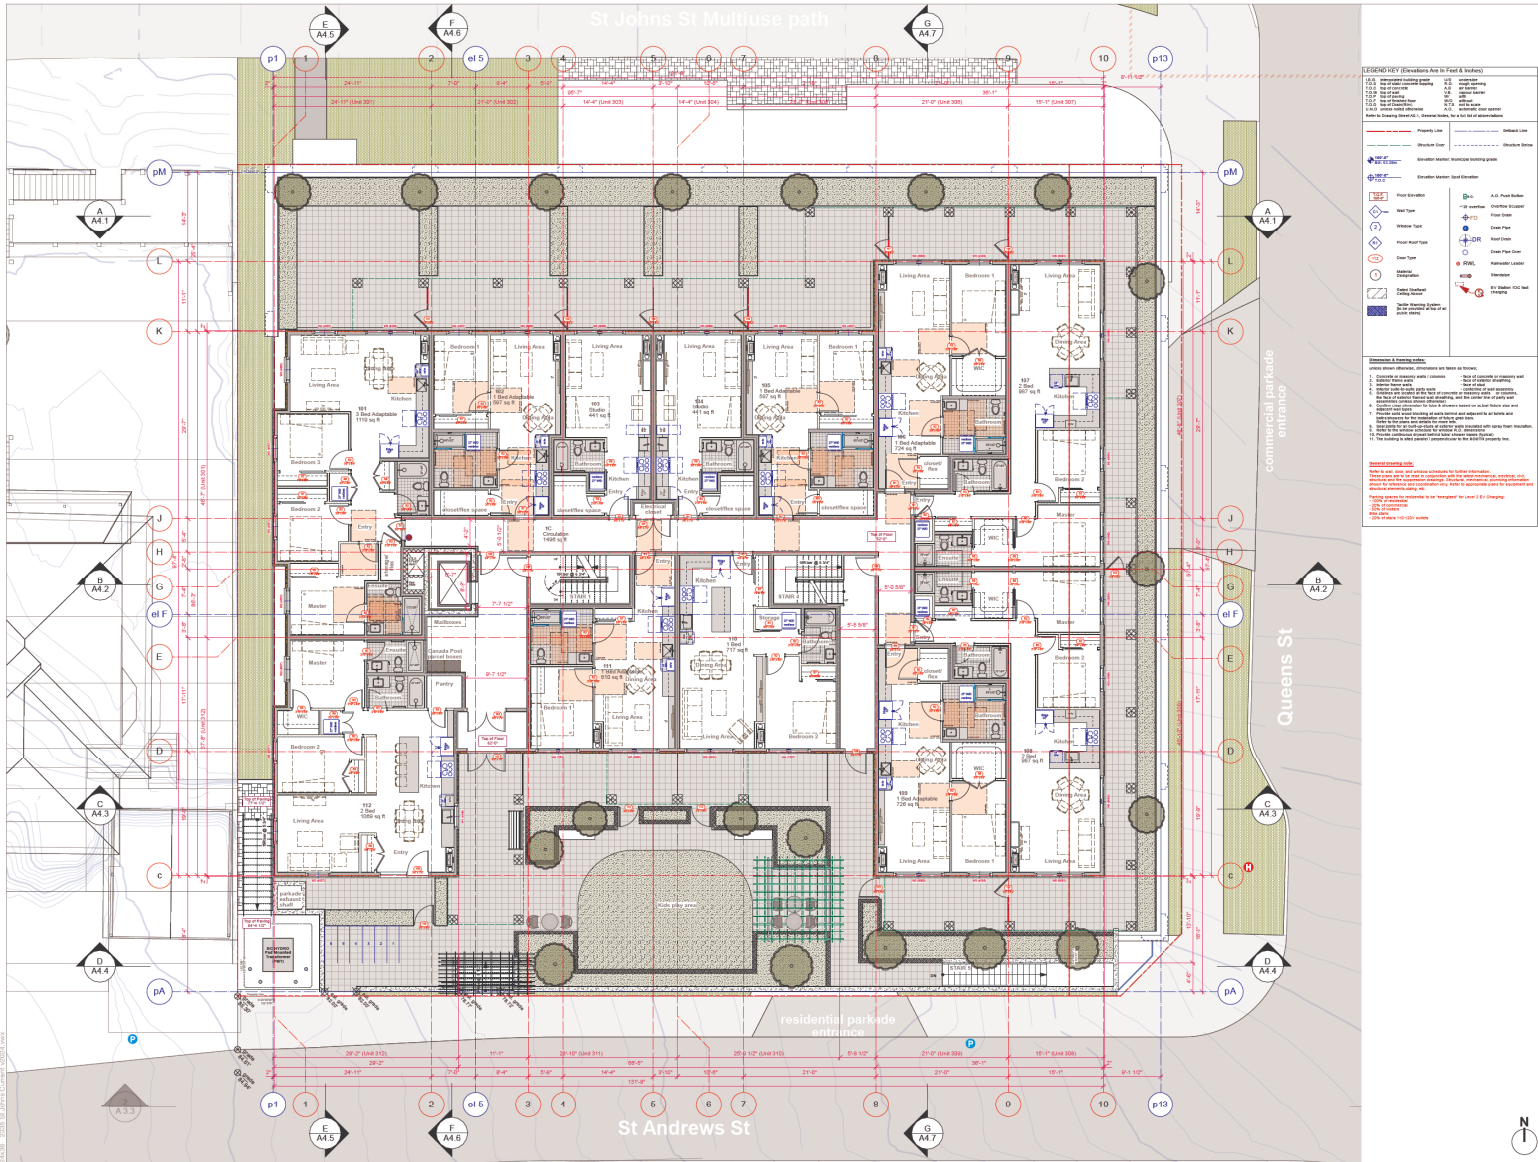

CORNERSTONE
architecture

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- LEGEND**
- | | | | | | | | | | | | |
|-------------------------------|----------------------------|------------------------------|----------------------------|----------------------------|--|------------------------------|------------------------|---------------------|------------------------|---------------------------|----------------------------|
| 1. A.C. (Architect's Callout) | 2. I.C. (Interior Callout) | 3. S.C. (Structural Callout) | 4. E.C. (Exterior Callout) | 5. P.C. (Plumbing Callout) | 6. E.E.C. (Electrical Engineering Callout) | 7. M.C. (Mechanical Callout) | 8. F.C. (Fire Callout) | 9. S.P. (Site Plan) | 10. P.P. (Paving Plan) | 11. L.P. (Landscape Plan) | 12. T.P. (Topography Plan) |
|-------------------------------|----------------------------|------------------------------|----------------------------|----------------------------|--|------------------------------|------------------------|---------------------|------------------------|---------------------------|----------------------------|
- Abbreviations & Symbols:**
- 1. Architect's Callout (A.C.)
 - 2. Interior Callout (I.C.)
 - 3. Structural Callout (S.C.)
 - 4. Exterior Callout (E.C.)
 - 5. Plumbing Callout (P.C.)
 - 6. Electrical Engineering Callout (E.E.C.)
 - 7. Mechanical Callout (M.C.)
 - 8. Fire Callout (F.C.)
 - 9. Site Plan (S.P.)
 - 10. Paving Plan (P.P.)
 - 11. Landscape Plan (L.P.)
 - 12. Topography Plan (T.P.)

Rev.	YY MM DD	ISSUE / REVISION
7	2024-06-14	Re-issue for CP Application
6	2024-03-22	Re-issue for CP Application
5	2023-05-19	Issue for CP Application
4	2023-05-05	Issue for Review
3	2023-01-19	Issue for Review
2	2022-11-07	Issue for Preliminary CP Application
1	2022-08-05	Issue for Review

PROJECT
Bosa Foods
2335 St Johns St


BUILDING CODE BCRC 2018
ZONING DEVELOPMENT PERMIT # RM4, C3
BUILDING PERMIT #

DRAWING
Residential Level 1

Scale: 1/8" = 1'-0" (unless noted otherwise)

PLOT DATE Jun 14, 2024

PROJECT NO. 2119
DRAWING NO. **A2.4**

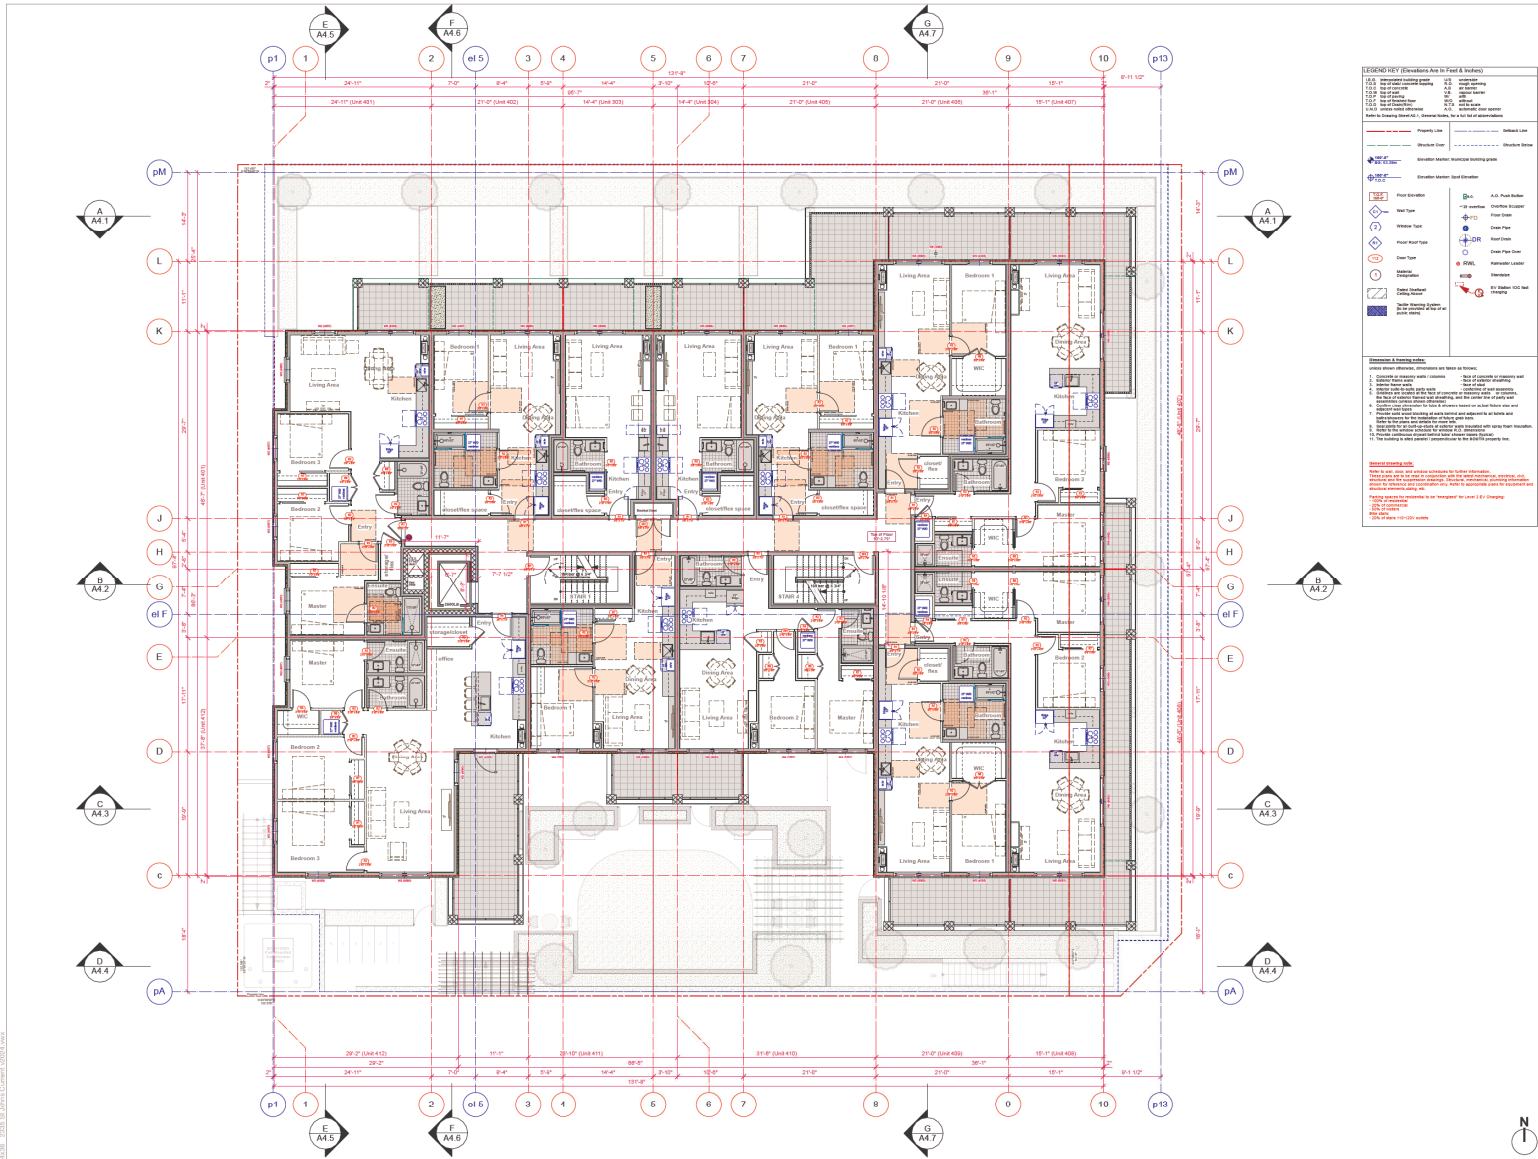

GENERAL NOTES (Residential Area - Floor & Section)

1. All dimensions are in feet and inches.
2. All work shall be in accordance with the current editions of the Building Code of Canada and the National Building Code of Canada.
3. All work shall be in accordance with the current editions of the International Building Code and the International Residential Code.
4. All work shall be in accordance with the current editions of the National Electrical Code and the National Fire Protection Association (NFPA) codes.
5. All work shall be in accordance with the current editions of the International Plumbing Code and the International Mechanical Code.
6. All work shall be in accordance with the current editions of the International Fire Code and the International Fire Marshals Association (IFMA) codes.
7. All work shall be in accordance with the current editions of the International Energy Conservation Code and the International Green Building Code.
8. All work shall be in accordance with the current editions of the International Accessibility and Mobility Code and the International Building Code.
9. All work shall be in accordance with the current editions of the International Building Code and the International Residential Code.
10. All work shall be in accordance with the current editions of the International Building Code and the International Residential Code.

REVISIONS

NO.	DATE	DESCRIPTION
1	2022-09-05	Issue for Review
2	2022-11-07	Issue for Preliminary CP Application
3	2023-01-09	Issue for Review
4	2023-05-05	Issue for Review
5	2023-05-19	Issue for CP Application
6	2024-03-22	Re-issue for CP Application
7	2024-06-14	Re-issue for CP Application

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Num.	YY MM DD	ISSUE / REVISION
1	2022-09-05	Issue for Review
2	2022-11-07	Issue for Preliminary CP Application
3	2023-01-09	Issue for Review
4	2023-05-05	Issue for Review
5	2023-05-19	Issue for CP Application
6	2024-03-22	Re-issue for CP Application
7	2024-06-14	Re-issue for CP Application

PROJECT
Bosa Foods
 2335 St Johns St


BUILDING CODE BCRC 2018
ZONING RM4, C3
DEVELOPMENT PERMIT #
BUILDING PERMIT #

DRAWING
Residential Level 2

SCALE 1/8" = 1'-0" (unless noted otherwise)

PLOT DATE Jun 14, 2024

PROJECT NO. 2119
DRAWING NO. A2.5

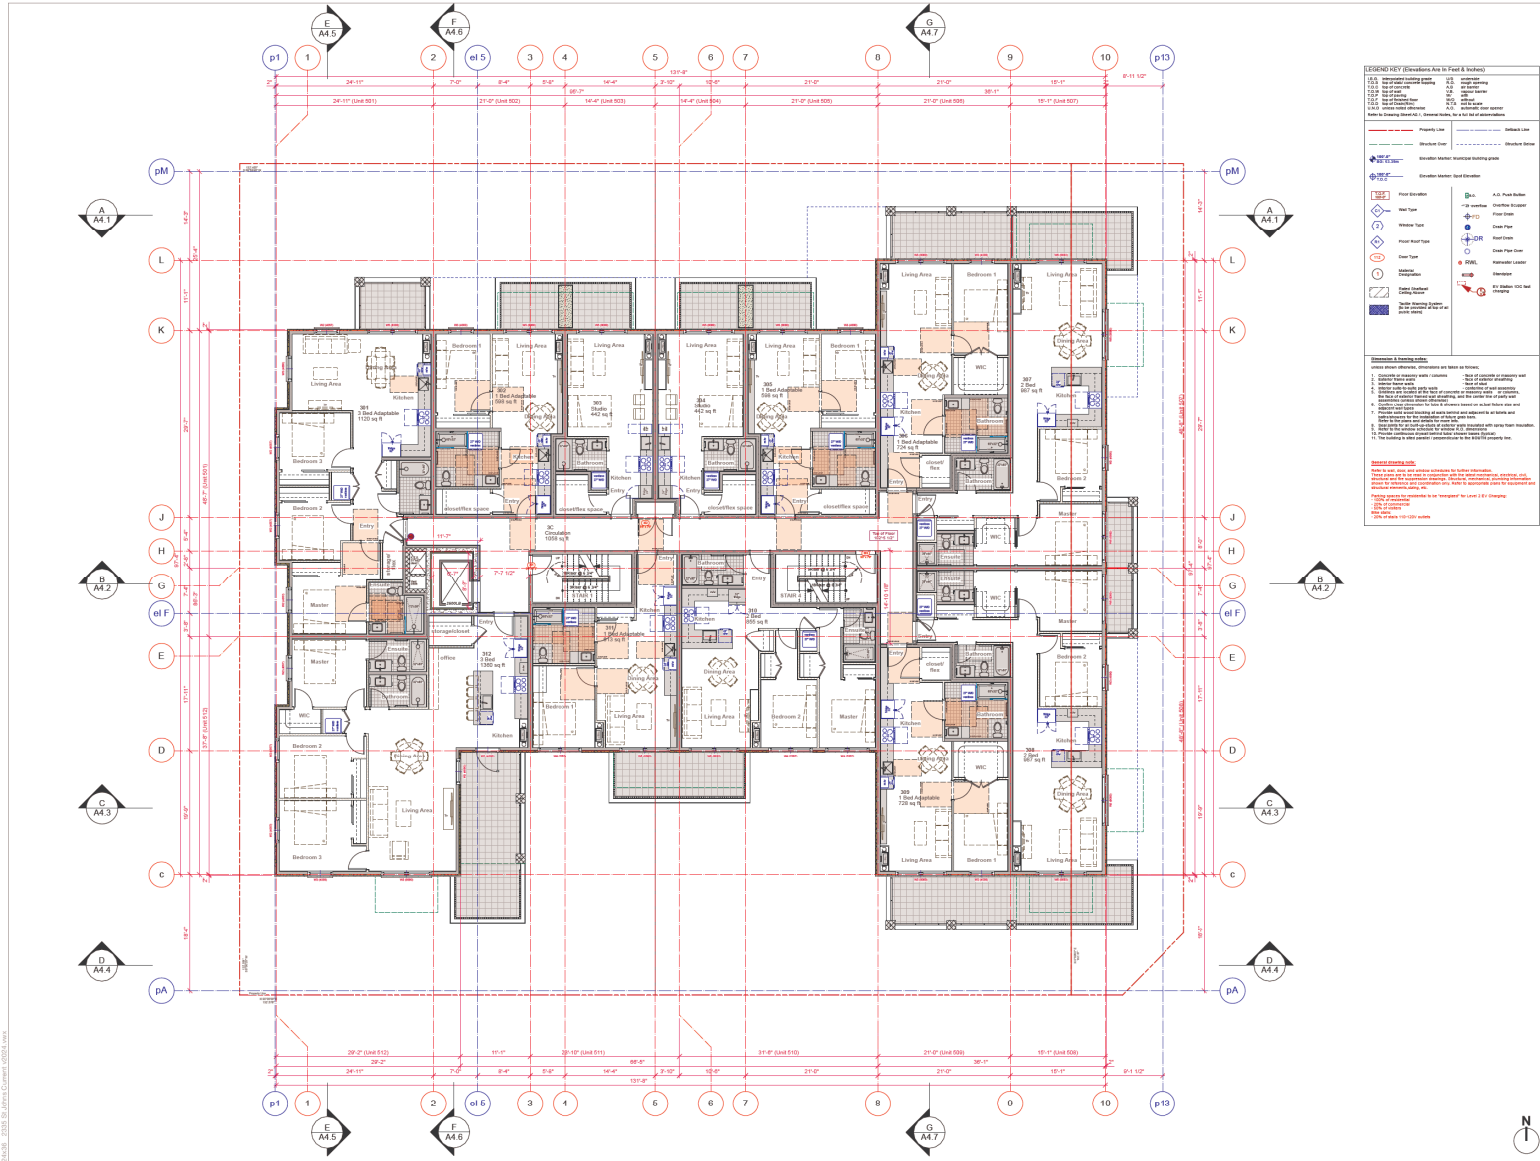

GENERAL NOTES (Residential Area - Floor & Levels)

1. ALL dimensions are in feet and inches unless otherwise noted.

2. ALL dimensions are to the centerline of the member unless otherwise noted.

3. ALL dimensions are to the finished surface unless otherwise noted.

4. ALL dimensions are to the centerline of the member unless otherwise noted.

5. ALL dimensions are to the finished surface unless otherwise noted.

6. ALL dimensions are to the centerline of the member unless otherwise noted.

7. ALL dimensions are to the finished surface unless otherwise noted.

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29. ALL dimensions are to the finished surface unless otherwise noted.

30. ALL dimensions are to the centerline of the member unless otherwise noted.

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Rev.	YY MM DD	ISSUE / REVISION
7	2024-06-14	Re-issue for CP Application
6	2024-03-22	Re-issue for CP Application
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4	2023-05-05	Issue for Review
3	2023-01-09	Issue for Review
2	2022-11-07	Issue for Preliminary CP Application
1	2022-09-05	Issue for Review

PROJECT
Bosa Foods
 2335 St Johns St

BUILDING CODE BCRC 2018
ZONING RM4, C3
DEVELOPMENT PERMIT #
BUILDING PERMIT #


DRAWING
Residential Level 3

SCALE 1/8" = 1'-0" (unless noted otherwise)

PLOT DATE Jun 14, 2024

PROJECT NO. 2119
DRAWING NO. A2.6



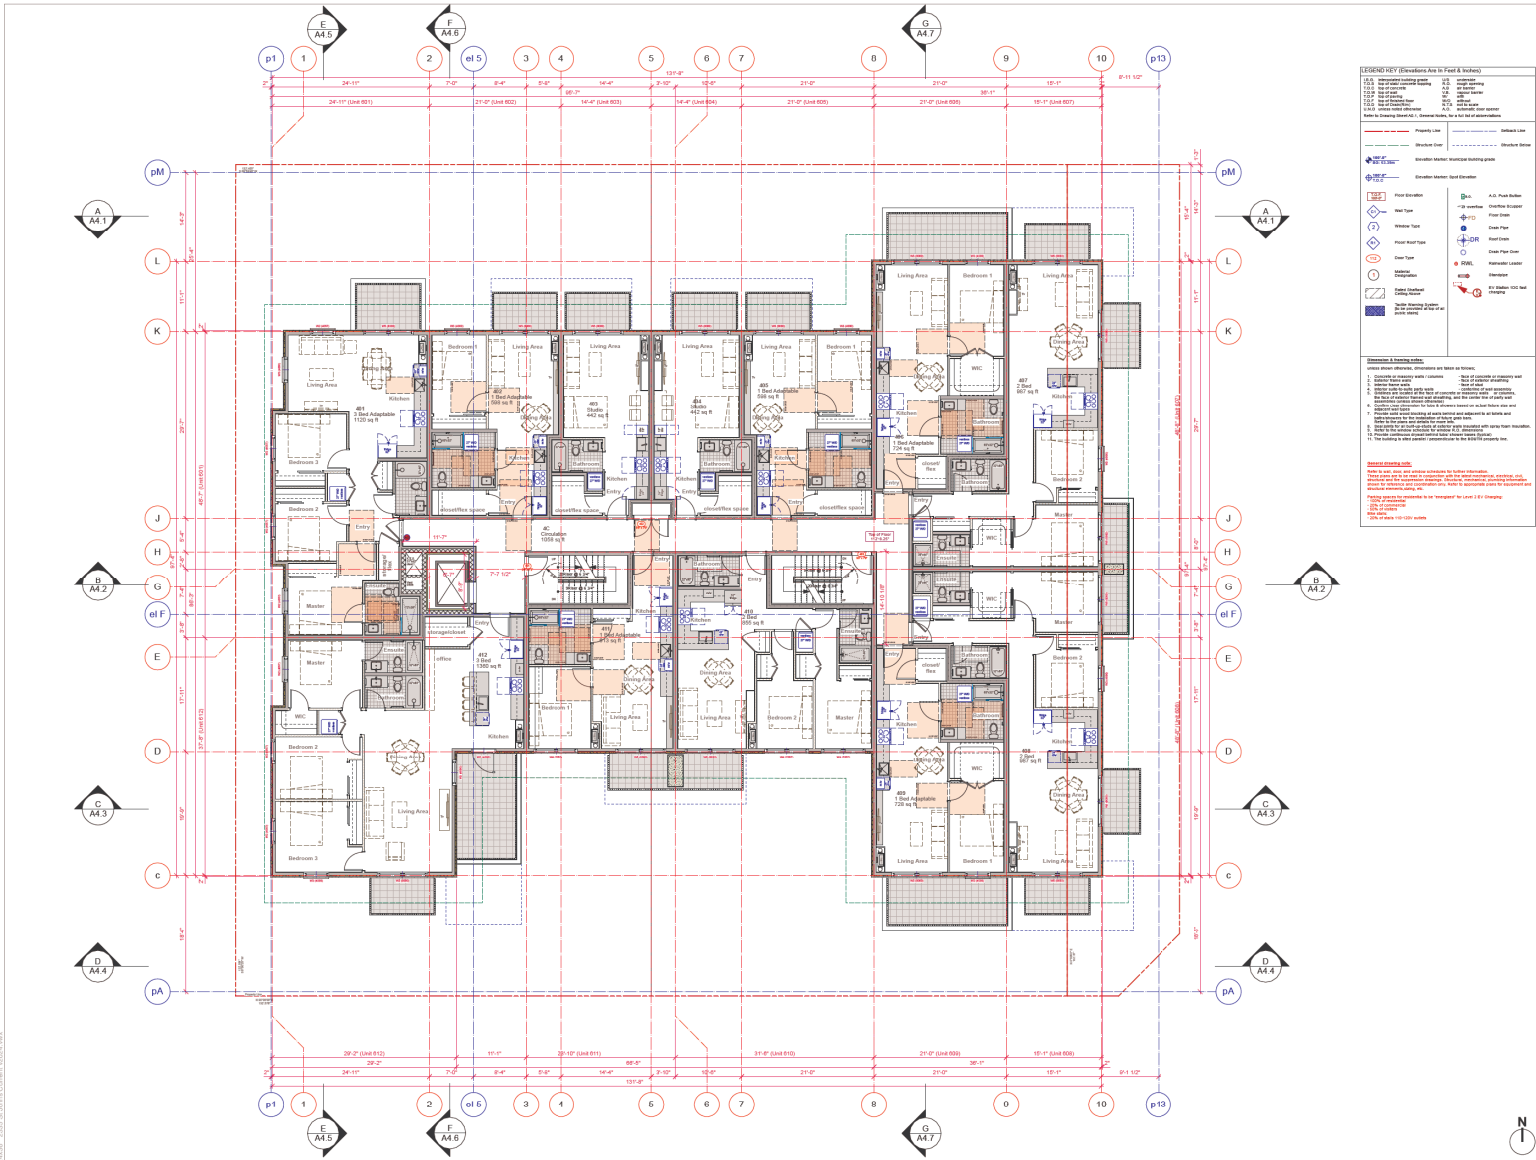

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GENERAL NOTES (Residential Area - Floor & Levels)	
1. ALL dimensions are in feet and inches.	2. All dimensions are to the centerline of the member unless otherwise indicated.
3. All dimensions are to the finished surface unless otherwise indicated.	4. All dimensions are to the centerline of the member unless otherwise indicated.
5. All dimensions are to the centerline of the member unless otherwise indicated.	6. All dimensions are to the centerline of the member unless otherwise indicated.
7. All dimensions are to the centerline of the member unless otherwise indicated.	8. All dimensions are to the centerline of the member unless otherwise indicated.
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49. All dimensions are to the centerline of the member unless otherwise indicated.	50. All dimensions are to the centerline of the member unless otherwise indicated.
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95. All dimensions are to the centerline of the member unless otherwise indicated.	96. All dimensions are to the centerline of the member unless otherwise indicated.
97. All dimensions are to the centerline of the member unless otherwise indicated.	98. All dimensions are to the centerline of the member unless otherwise indicated.
99. All dimensions are to the centerline of the member unless otherwise indicated.	100. All dimensions are to the centerline of the member unless otherwise indicated.

Revisions	Issue Date	Issue Description
7	2024-06-14	Re-Issue for CP Application
6	2024-03-22	Re-issue for CP Application
5	2023-05-19	Issue for CP Application
4	2023-05-05	Issue for Review
3	2023-01-05	Issue for Review
2	2022-11-07	Issue for Preliminary CP Application
1	2022-09-05	Issue for Review

Num.	YY MM DD	ISSUE / REVISION
7	2024-06-14	Re-Issue for CP Application
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5	2023-05-19	Issue for CP Application
4	2023-05-05	Issue for Review
3	2023-01-05	Issue for Review
2	2022-11-07	Issue for Preliminary CP Application
1	2022-09-05	Issue for Review

PROJECT
Bosa Foods
 2335 St Johns St

BUILDING CODE BCRC 2018
ZONING RM4, C3
DEVELOPMENT PERMIT #
BUILDING PERMIT #

DRAWING
Residential Level 4

Issued subject to contract. These drawings are not to be approved by a building official or a contractor. The contractor is responsible for verifying the accuracy of the information on this drawing and actual field conditions and/or the remaining Contract Documents shall be brought to the attention of the Architect for clarification prior to proceeding with the Work.

SCALE 1/8" = 1'-0" (unless noted otherwise)

PLOT DATE Jun 14, 2024

PROJECT NO. 2119
DRAWING NO. A2.7



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Toronto, Ontario, Canada
M5A 1K1
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416 924 255 8800

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GENERAL NOTES (Revisions, Add to Foot & Notes)

1. A.C.I. Reinforcing Steel Bars	2. A.C.I. Reinforcing Steel Bars
3. A.C.I. Reinforcing Steel Bars	4. A.C.I. Reinforcing Steel Bars
5. A.C.I. Reinforcing Steel Bars	6. A.C.I. Reinforcing Steel Bars
7. A.C.I. Reinforcing Steel Bars	8. A.C.I. Reinforcing Steel Bars
9. A.C.I. Reinforcing Steel Bars	10. A.C.I. Reinforcing Steel Bars
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17. A.C.I. Reinforcing Steel Bars	18. A.C.I. Reinforcing Steel Bars
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21. A.C.I. Reinforcing Steel Bars	22. A.C.I. Reinforcing Steel Bars
23. A.C.I. Reinforcing Steel Bars	24. A.C.I. Reinforcing Steel Bars
25. A.C.I. Reinforcing Steel Bars	26. A.C.I. Reinforcing Steel Bars
27. A.C.I. Reinforcing Steel Bars	28. A.C.I. Reinforcing Steel Bars
29. A.C.I. Reinforcing Steel Bars	30. A.C.I. Reinforcing Steel Bars
31. A.C.I. Reinforcing Steel Bars	32. A.C.I. Reinforcing Steel Bars
33. A.C.I. Reinforcing Steel Bars	34. A.C.I. Reinforcing Steel Bars
35. A.C.I. Reinforcing Steel Bars	36. A.C.I. Reinforcing Steel Bars
37. A.C.I. Reinforcing Steel Bars	38. A.C.I. Reinforcing Steel Bars
39. A.C.I. Reinforcing Steel Bars	40. A.C.I. Reinforcing Steel Bars
41. A.C.I. Reinforcing Steel Bars	42. A.C.I. Reinforcing Steel Bars
43. A.C.I. Reinforcing Steel Bars	44. A.C.I. Reinforcing Steel Bars
45. A.C.I. Reinforcing Steel Bars	46. A.C.I. Reinforcing Steel Bars
47. A.C.I. Reinforcing Steel Bars	48. A.C.I. Reinforcing Steel Bars
49. A.C.I. Reinforcing Steel Bars	50. A.C.I. Reinforcing Steel Bars
51. A.C.I. Reinforcing Steel Bars	52. A.C.I. Reinforcing Steel Bars
53. A.C.I. Reinforcing Steel Bars	54. A.C.I. Reinforcing Steel Bars
55. A.C.I. Reinforcing Steel Bars	56. A.C.I. Reinforcing Steel Bars
57. A.C.I. Reinforcing Steel Bars	58. A.C.I. Reinforcing Steel Bars
59. A.C.I. Reinforcing Steel Bars	60. A.C.I. Reinforcing Steel Bars
61. A.C.I. Reinforcing Steel Bars	62. A.C.I. Reinforcing Steel Bars
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97. A.C.I. Reinforcing Steel Bars	98. A.C.I. Reinforcing Steel Bars
99. A.C.I. Reinforcing Steel Bars	100. A.C.I. Reinforcing Steel Bars

Revisions & Issuance Dates:

- 2024-06-14: Issue for CP Application
- 2024-03-22: Release for CP Application
- 2023-05-19: Issue for CP Application
- 2023-05-05: Issue for Review
- 2023-04-19: Issue for Review
- 2022-11-07: Issue for Preliminary CP Application
- 2022-09-05: Issue for Review

Revisions:

Num.	YY MM DD	ISSUE / REVISION
7	2024-06-14	Issue for CP Application
6	2024-03-22	Release for CP Application
5	2023-05-19	Issue for CP Application
4	2023-05-05	Issue for Review
3	2023-04-19	Issue for Review
2	2022-11-07	Issue for Preliminary CP Application
1	2022-09-05	Issue for Review

Project Information:

PROJECT: **Bosa Foods**
2335 St Johns St


BUILDING CODE: BCRC 2018
ZONING: RM4, C3
DEVELOPMENT PERMIT #: [Blank]
BUILDING PERMIT #: [Blank]

DRAWING: **Roof**


SCALE: 1/8" = 1'-0" (unless noted otherwise)

PLOT DATE: Jun 14, 2024

PROJECT NO.: 2119
DRAWING NO.: **A2.8**

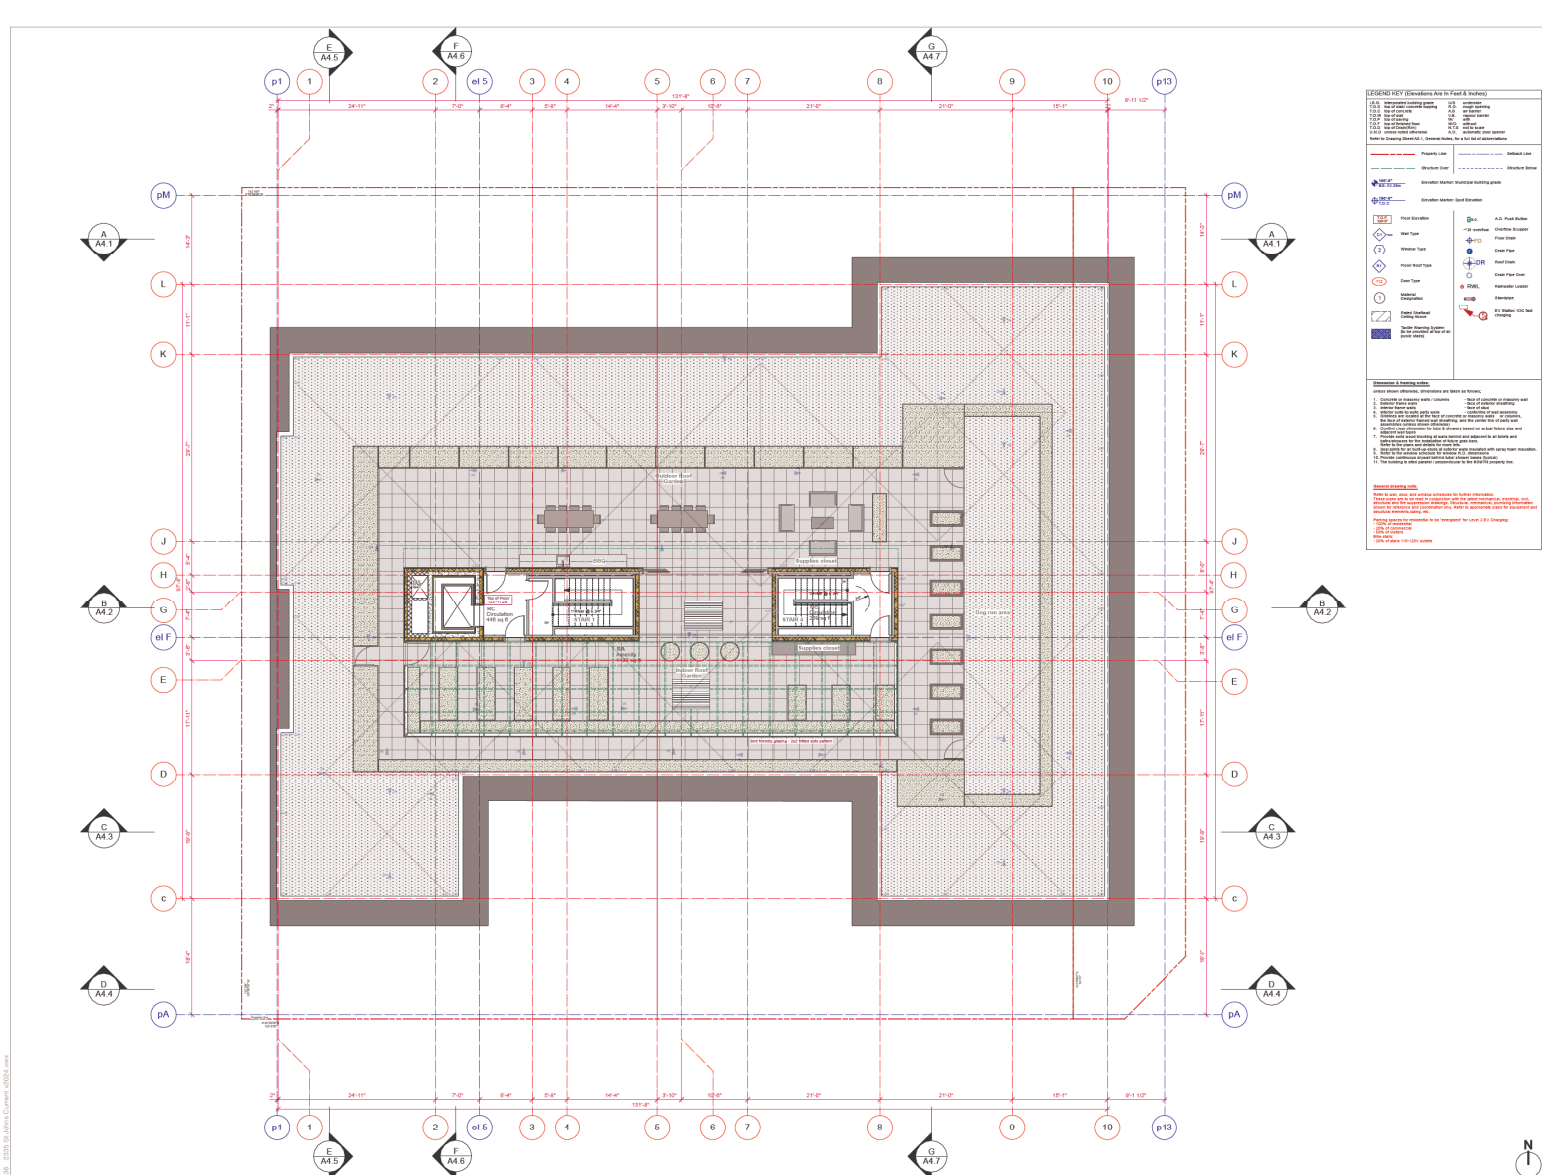

2335 St Johns St - Cornerstone Architecture

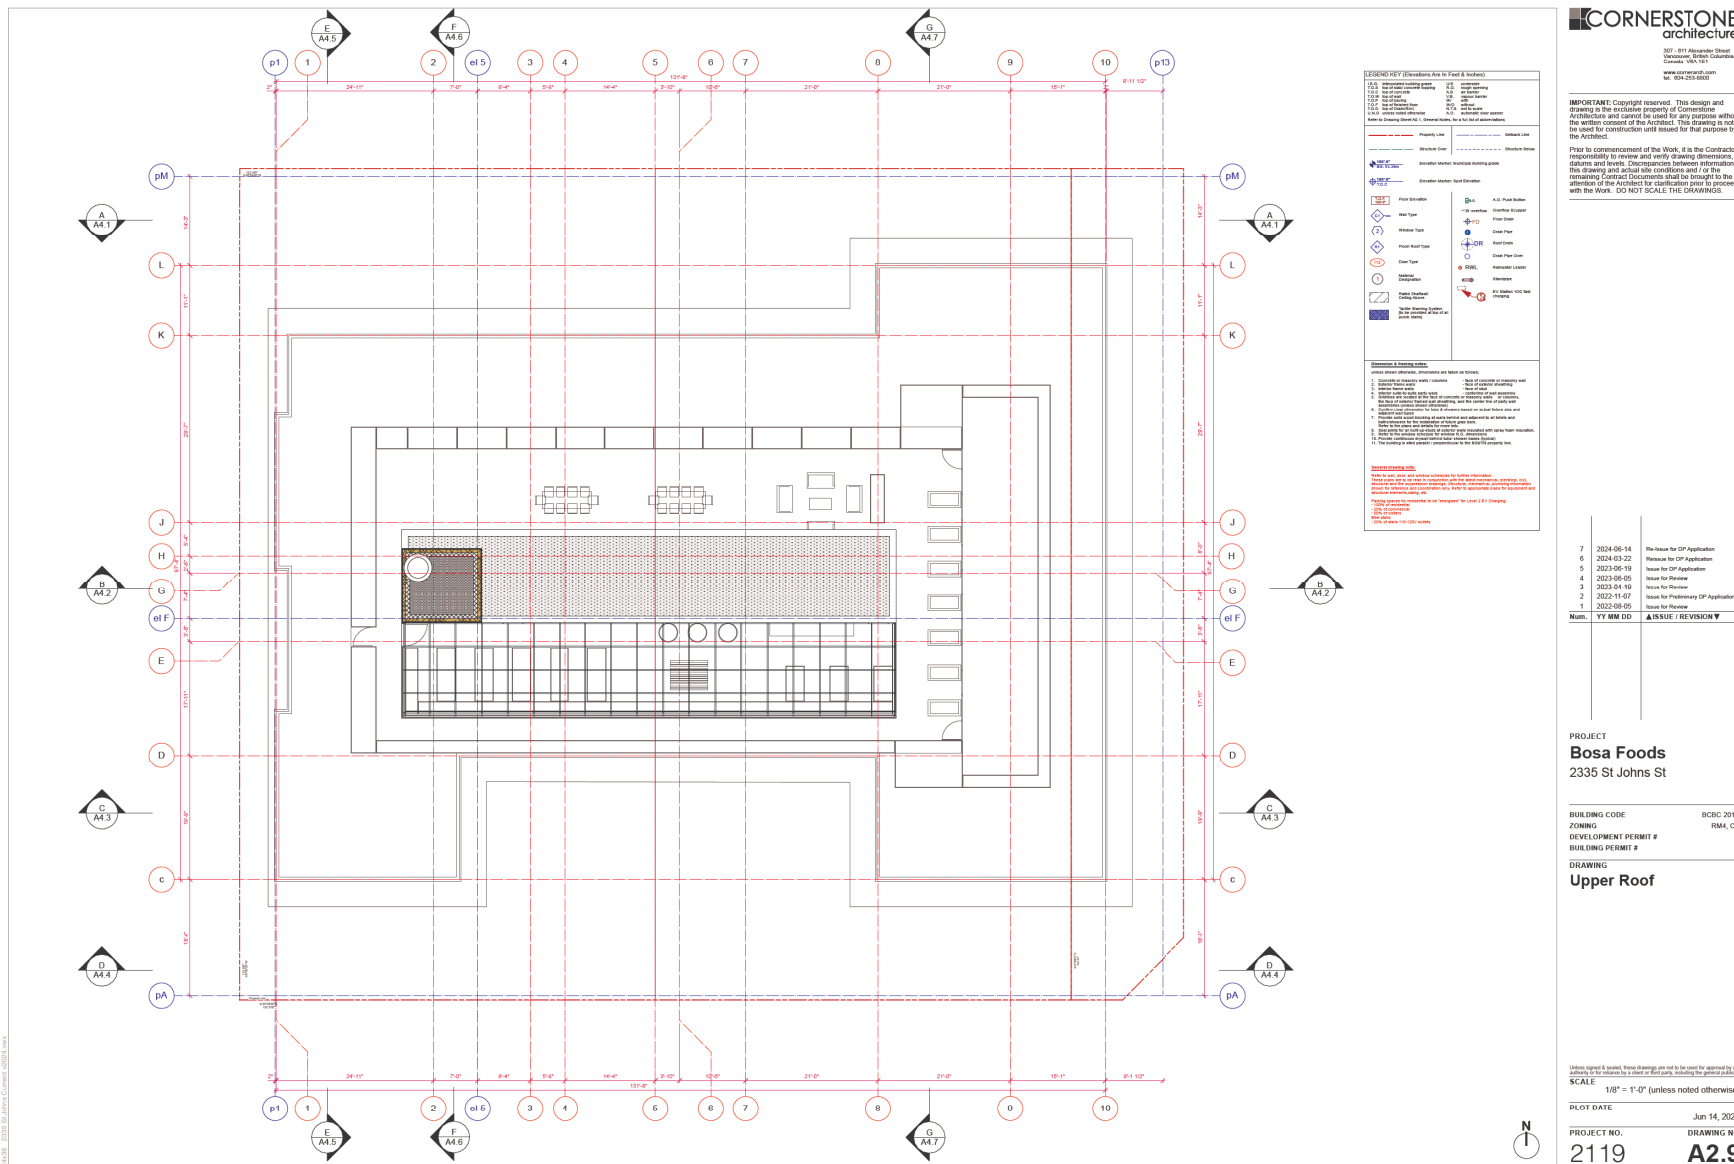

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 Canada V6A 1K1
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 Tel. 604-255-8800

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GENERAL NOTES (Revisions Add to Front of Notes)

1. ALL dimensions shown on this drawing are in feet and inches.	2. ALL dimensions are shown to the center of the member unless otherwise noted.	3. ALL dimensions are shown to the center of the member unless otherwise noted.	4. ALL dimensions are shown to the center of the member unless otherwise noted.
5. ALL dimensions are shown to the center of the member unless otherwise noted.	6. ALL dimensions are shown to the center of the member unless otherwise noted.	7. ALL dimensions are shown to the center of the member unless otherwise noted.	8. ALL dimensions are shown to the center of the member unless otherwise noted.
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45. ALL dimensions are shown to the center of the member unless otherwise noted.	46. ALL dimensions are shown to the center of the member unless otherwise noted.	47. ALL dimensions are shown to the center of the member unless otherwise noted.	48. ALL dimensions are shown to the center of the member unless otherwise noted.
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REVISIONS & ISSUES LOG:

No.	DATE	DESCRIPTION
7	2024-06-14	Re-issue for CP Application
6	2024-03-22	Re-issue for CP Application
5	2023-05-19	Issue for CP Application
4	2023-05-05	Issue for Review
3	2022-11-18	Issue for Review
2	2022-11-07	Issue for Preliminary CP Application
1	2022-09-05	Issue for Review

NUM. YY MM DD | **ISSUE / REVISION**

PROJECT
Bosa Foods
 2335 St Johns St

BUILDING CODE BCRC 2018
 ZONING RM4, C3
 DEVELOPMENT PERMIT #
 BUILDING PERMIT #

DRAWING
Upper Roof

SCALE 1/8" = 1'-0" (unless noted otherwise)

PLOT DATE Jun 14, 2024

PROJECT NO. 2119
 DRAWING NO. A2.9



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7	2024-06-14	Re-Issue for CP Application
6	2024-03-22	Re-issue for CP Application
5	2023-06-19	Issue for CP Application
4	2023-06-05	Issue for Review
3	2023-04-18	Issue for Review
2	2022-11-07	Issue for Preliminary CP Application
1	2022-09-05	Issue for Review

Revis: YY MM DD **▲ ISSUE / REVISION ▼**

PROJECT
Bosa Foods
 2335 St Johns St

BUILDING CODE BCRC 2018
ZONING RM4, C3
DEVELOPMENT PERMIT #
BUILDING PERMIT #

DRAWING
North Elevation

Unless noted, all window, door, and hardware shall be as specified in the schedule and shall be subject to a color and finish selection by the contractor.
SCALE 1/8" = 1'-0" (unless noted otherwise)

PLOT DATE Jun 14, 2024

PROJECT NO. 2119
DRAWING NO. A3.1

Bosa Foods - St. Johns St.				
FINISH SCHEDULE No.	Material	Manufacturer	Texture	Colour
1.1	pragor c/w prefinished metal counter and c/w flashing			Iron Ore
1.2	metal built in air vent hood	Lux Metal	Wood grain	Black
1.3	prefinished metal cap flashing over cement board fascia	James Harbe	Charcoal grey	
2.1	V groove siding	Lux metal siding cladding	Wood grain	Black
2.2	Flare cement panel cladding	James Harbe	Smooth	Antic White
2.3	Flare cement vertical siding	James Harbe	Smooth	Antic White
2.4	Flare cement horizontal lap siding	James Harbe	Smooth	Antic Gray
2.5	Painted concrete wall	Concrete	Cedarnit	Charcoal
2.6	Architectural stone c/w grot	Shoussac	Isoprey	Disent Blue
2.7	Architectural stone c/w grot	Shoussac	Isoprey	Disent Blue
2.8	Through wall flashing and band	James Harbe and metal	Charcoal grey	
2.9	Wavy window & doors		Charcoal grey	
2.10	Painted wood entry door		Iron Ore	
3.1	Class glazing system c/w glass & cap	AF Glo term		Clear
3.2	Aluminum flat bar glazing			Iron Ore
3.3	Painted garage door recessed			Iron Ore
3.4	Double-glazed aluminum windows & sliding glass door (w/tilt)		Charcoal grey	
3.5	Painted garage door rear		Iron Ore	
4.1	Aluminum screen & glass c/w opaque glass		Black	
4.2	Aluminum screen & glass c/w opaque glass		Iron Ore	
4.3	Aluminum screens		Iron Ore	

Bosa Foods - St. Johns St.				
FINISH SCHEDULE No.	Material	Manufacturer	Texture	Colour
4.5	heavy timber wood canopy (w/ transparent hand kno) c/w painted black metal connectors and full cap where exposed	S&S landscape		
4.6	heavy timber architectural canopy w/ c/w clear elastomeric paint or Allen block details	S&S landscape		
5.1	wood slat steel canopy c/w glass & cables			None Color
5.2	steel canopy c/w glass & cables			None Color
5.3	steel canopy hung canopy			None Color
5.4	concrete wall, canopy and decorative ledge	CSG/SH	Black Hub	None Color
5.5	aluminum decorative screen			Charcoal grey
5.6	concrete grimey system			Aluminum
5.7	aluminum signage			Aluminum

202406 2335 St Johns Street 1025111111



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Prior to commencement of the Work, it is the Contractor's responsibility to review and verify drawing dimensions, details and levels. Discrepancies between information on this drawing and actual field conditions shall be the Contractor's responsibility. All information on the remaining Contract Documents shall be brought to the attention of the architect by clarification prior to proceeding with the Work. **DO NOT SCALE THE DRAWINGS.**

7	2024-06-14	Re-issue for CP Application
6	2024-03-22	Re-issue for CP Application
5	2023-09-19	Issue for CP Application
4	2023-06-05	Issue for Review
3	2023-04-18	Issue for Review
2	2022-11-07	Issue for Preliminary CP Application
1	2022-09-05	Issue for Review

PROJECT
Bosa Foods
 2335 St Johns St

BUILDING CODE BCRC 2018
ZONING RM4, C3
DEVELOPMENT PERMIT #
BUILDING PERMIT #

DRAWING
East Elevation

Bosa Foods - St. Johns St.				
FINISH SCHEDULE	Material	Manufacturer	Texture	Colour
1.1	pragor c/w prefinished metal counter and c/w flashing			iron ore
1.2	metal roof c/w steel structural	lori harsco	wood grain	peach
1.3	prefinished metal cap flashing over cement board fascia	jamies harsco	charcoal grey	
2.1	1/2" x 1/2" double siding	lori metal siding c/w flashing	wood grain	peach
2.2	1/2" fire cement panel cladding	jamies harsco	smooth	alric white
2.3	1/2" fire cement vertical siding	jamies harsco	smooth	iron grey
2.4	1/2" fire cement horizontal lap siding	jamies harsco	cedarmill	charcoal
2.5	1/2" painted concrete wall	concrete		disent buff
2.6	architectural stone c/w grotto	troussard	rough	disent buff
2.7	architectural stone c/w grotto	troussard	rough	disent buff
2.8	through wall flashing and band	jamies harsco and metal		charcoal grey
2.9	1/2" vinyl window & doors			charcoal grey
2.10	1/2" painted wood entry door			iron grey
3.1	glass glazing system c/w glass & cap	af-co	smooth	clear
3.2	aluminum flat bar glazing			iron ore
3.3	1/2" painted garage door recessed			iron ore
3.4	1/2" double-glazed aluminum windows & sliding glass door (w/ rail)			charcoal grey
3.5	1/2" painted garage door rear			iron grey
4.1	aluminum screen & glass c/w opaque glass			iron grey
4.2	aluminum screen			iron grey
4.3	aluminum screen			haze color

Bosa Foods - St. Johns St.				
FINISH SCHEDULE	Material	Manufacturer	Texture	Colour
4.5	heavy timber wood canopy (w/ resistant brackets and full cap where exposed)	see landscape		
4.6	heavy timber architectural concrete wall c/w clear elastomeric paint or allen block panels	see landscape		
5.1	1/2" roof and steel canopy c/w glass & cables			haze color
5.2	1/2" steel canopy c/w glass & cables			haze color
5.3	1/2" steel canopy c/w glass & cables			haze color
5.4	concrete wall, canopy and decorative ledge	concrete	brick rub	haze color
5.5	aluminum decorative screen			charcoal grey
5.6	concrete glazing system	aluminum		
5.7	aluminum signage	aluminum		

Unless noted, all finish drawings are to be used for approval by the authority to be obtained by a client of Bosa Foods. This drawing is not to be used for construction until issued for that purpose by the architect.

SCALE 1/8" = 1'-0" (unless noted otherwise)

PLOT DATE Jun 14, 2024

PROJECT NO. 2119 **DRAWING NO.** A3.2

2335 St. Johns St. Johns St. Johns St.



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7	2024-06-14	Re-Issue for CP Application
6	2024-03-22	Re-Issue for CP Application
5	2023-06-19	Issue for CP Application
4	2023-06-05	Issue for Review
3	2023-04-18	Issue for Review
2	2022-11-07	Issue for Preliminary CP Application
1	2022-08-05	Issue for Review

PROJECT
Bosa Foods
 2335 St Johns St

BUILDING CODE BCRC 2018
ZONING RM4, C3
DEVELOPMENT PERMIT #
BUILDING PERMIT #

DRAWING
South Elevation

Unless indicated, all window, door, and hardware shall be as specified in the schedule. For details, refer to the schedule or the general notes.
SCALE 1/8" = 1'-0" (unless noted otherwise)


PLOT DATE Jun 14, 2024

PROJECT NO. 2119
DRAWING NO. A3.3

Bosa Foods - St. Johns St.				
FINISH SCHEDULE No.	Material	Manufacturer	Texture	Colour
1.1	Parapet c/w prefinished metal counter and c/w flashing			Iron Ore
1.2	Mezz floor c/w steel structural	Luxi Harle	Wood grain	Black
1.3	Prefinished metal cap flashing over cement base	James Harle	Charcoal grey	
2.1	C/S concrete siding	Luxi metal siding c/w flashing	Wood grain	Black
2.2	Finish cement plaster c/w flashing	James Harle	Smooth	Alcic White
2.3	Finish cement vertical lap siding	James Harle	Alcic White	Iron Gray
2.4	Finish cement horizontal lap siding	James Harle	Cedarmill	Charcoal
2.5	Painted concrete wall	Concrete		Charcoal
2.6	Architectural stone c/w grout	Shoussac	Isoprey	Disent Blue
2.7	Architectural stone c/w grout	Shoussac	Isoprey	Disent Blue
2.8	Through wall flashing and band	James Harle and metal		Charcoal grey
2.9	Wavy window & door			Charcoal grey
2.10	Painted metal entry door			Iron Gray
2.11	Class glazing system c/w glass & cap	AF-GLU System		Clear
3.1	Aluminum flat bar glazing			Iron Ore
3.2	Painted garage door recessed			Charcoal grey
3.3	Double-glazed aluminum windows & sliding glass door (w/ rail)			Charcoal grey
3.4	Painted garage door rear			Iron Gray
4.1	Aluminum screen & glass c/w opaque glass			Iron Gray
4.2	Aluminum screen			Iron Gray
4.3	Aluminum screen			Iron Gray

Bosa Foods - St. Johns St.				
FINISH SCHEDULE No.	Material	Manufacturer	Texture	Colour
4.4	Heavy timber wood canopy (w/ resistant treated wood) c/w painted iron metal connectors and full cap where exposed	See landscape		
4.5	Heavy timber wood canopy (w/ resistant treated wood) c/w painted iron metal connectors and full cap where exposed	See landscape		
4.6	Heavy timber architectural concrete cap c/w clear elastomeric paint or Allen block details	See landscape		
5.1	Wood slat steel canopy c/w glass & cables			
5.2	Steel canopy c/w glass & cables			
5.3	Steel cable hung canopy			
5.4	Concrete wall, canopy and decorative ledge	CSG/HEP	Black Hub	White Coat
5.5	Aluminum decorative screen			
5.6	Decorative glazing system	Aluminum		Charcoal grey
5.7	Aluminum signage	Aluminum		

202406-14 2335 St. Johns Street (2024).dwg

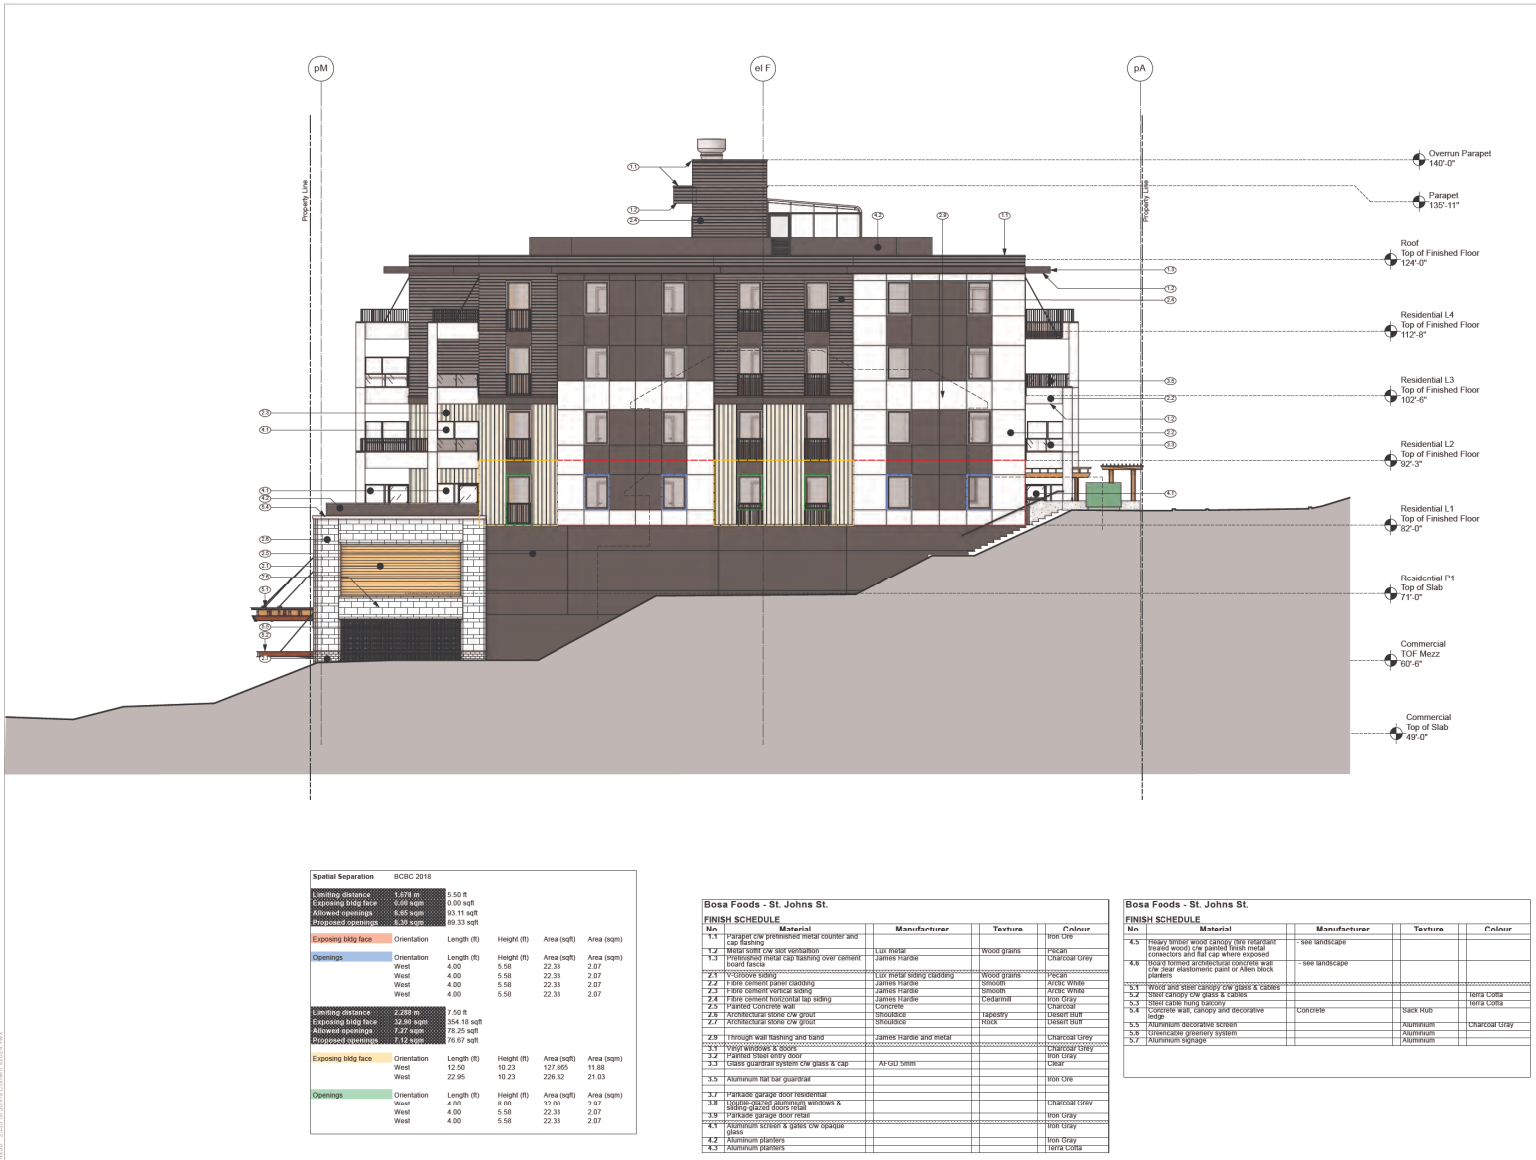

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Num.	YY MM DD	ISSUE / REVISION
7	2024-06-14	Re-Name for CP Application
6	2024-03-22	Revisions for CP Application
5	2023-06-19	Issue for CP Application
4	2023-06-05	Issue for Review
3	2022-11-18	Issue for Review
2	2022-11-07	Issue for Preliminary CP Application
1	2022-09-05	Issue for Review

PROJECT
Bosa Foods
2335 St Johns St

BUILDING CODE BCRC 2018
ZONING RM4, C3
DEVELOPMENT PERMIT #
BUILDING PERMIT #

DRAWING
West Elevation

Spatial Separation BCRC 2018

Opening distance	5.50 m
Exposing bldg face	0.00 sqm
Exposed openings	88.50 sqm
Proposed openings	89.33 sqm

Exposing bldg face	Orientation	Length (ft)	Height (ft)	Area (sqft)	Area (sqm)
Openings	Orientation	4.00	5.50	22.00	2.07
	West	4.00	5.50	22.00	2.07
	West	4.00	5.50	22.00	2.07
	West	4.00	5.50	22.00	2.07

Opening distance	7.50 m
Exposing bldg face	32.99 sqm
Exposed openings	78.20 sqm
Proposed openings	76.67 sqm

Exposing bldg face	Orientation	Length (ft)	Height (ft)	Area (sqft)	Area (sqm)
Openings	Orientation	12.50	10.23	127.85	11.88
	West	12.50	10.23	127.85	11.88
	West	12.50	10.23	127.85	11.88
	West	12.50	10.23	127.85	11.88

Bosa Foods - St. Johns St.

FINISH SCHEDULE	Material	Manufacturer	Texture	Colour
1.1	pragor c/w prefinished metal counter and c/w flashing	LOWE	Wood grain	Iron Ore
1.2	Prefinished metal cap flashing over cement board finish	James Hardie	Smooth	Charcoal grey
2.1	W/colours siding	LOWE metal siding	Wood grain	Iron Ore
2.2	Flare cement panel cladding	James Hardie	Smooth	Alloy White
2.3	Flare cement vertical siding	James Hardie	Smooth	Alloy White
2.4	Flare cement horizontal lap siding	James Hardie	Smooth	Iron Gray
2.5	Painted concrete wall	Concrete	Cedarnit	Charcoal
2.6	Architectural stone c/w grotto	Shoupside	Random	Dissect Buff
2.7	Architectural stone c/w grotto	Shoupside	Random	Dissect Buff
2.8	Through wall flashing and band	James Hardie and metal		Charcoal grey
2.9	Wavy window & doors			Charcoal grey
2.10	Painted metal entry door			Iron Gray
3.1	Clear quartzite system c/w glass & cap	AF CAP Stone		Clear
3.2	Aluminum flat bar quartzite			Iron Ore
3.3	Painted garage door mechanism			Charcoal grey
3.4	Double-pane aluminum windows & sliding glass door (w/tilt)			Iron Gray
3.5	Painted garage door rear			Iron Gray
4.1	Aluminum screen & glass c/w opaque glass			Iron Gray
4.2	Aluminum screen			Iron Gray
4.3	Aluminum screen			Iron Gray

Bosa Foods - St. Johns St.

FINISH SCHEDULE	Material	Manufacturer	Texture	Colour
4.5	Heavy indoor wood canopy (w/ transparent frame) w/tilt c/w partial frame metal connectors and full cap where exposed	See landscape		
5	Heavy topped architectural concrete wall c/w clear elastomeric paint or Allen block pavers	See landscape		
5.1	Wood slat steel canopy c/w glass & cables			None Color
5.2	Steel canopy c/w glass & cables			None Color
5.3	Steel canopy c/w glass & cables			None Color
5.4	Concrete wall, canopy and decorative ledge	CONCRETE	Stack Rub	None Color
5.5	Aluminum decorative screen	Aluminum	Charcoal grey	
5.6	Concrete groutery system	Aluminum		
5.7	Aluminum signage			

Unless noted, all finish drawings are to be in accordance with the BCRC 2018 Building Code. This drawing is not to be used for construction until issued for that purpose by the Architect.

SCALE 1/8" = 1'-0" (unless noted otherwise)

PLOT DATE Jun 14, 2024

PROJECT NO. 2119
DRAWING NO. A3.4



A
A 4.1 Section A-A
Scale: 1/8" = 1'-0"

CORNERSTONE
architecture

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Toronto, Ontario, Canada
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www.cornerstone.ca
Tel: 904-255-8800

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7	2024-06-14	Re-issue for CP Application
6	2024-03-22	Re-issue for CP Application
5	2023-06-19	Issue for CP Application
4	2023-06-05	Issue for Review
3	2023-04-09	Issue for Review
2	2022-11-07	Issue for Preliminary CP Application
1	2022-09-05	Issue for Review

Num. YY MM DD **▲ ISSUE / REVISION ▼**

PROJECT
Bosa Foods
2335 St Johns St

BUILDING CODE BCRC 2018
ZONING RM4, C3
DEVELOPMENT PERMIT #
BUILDING PERMIT #

DRAWING
Building Section A-A

Unless indicated, all other drawings are to be used for reference only as authority is for release by a client of that party, including the general public.

SCALE 1/8" = 1'-0" (unless noted otherwise)

PLOT DATE Jun 14, 2024

PROJECT NO. 2119
DRAWING NO. **A4.1**



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Num.	YY MM DD	ISSUE / REVISION
7	2024-06-14	Re-issue for CP Application
6	2024-03-22	Re-issue for CP Application
5	2023-06-19	Issue for CP Application
4	2023-06-05	Issue for Review
3	2023-01-18	Issue for Review
2	2022-11-07	Issue for Preliminary CP Application
1	2022-09-05	Issue for Review

PROJECT
Bosa Foods
2335 St Johns St


BUILDING CODE: BCRC 2018
ZONING: RM4, C3
DEVELOPMENT PERMIT #
BUILDING PERMIT #

DRAWING
Building Section B-B

SCALE: 1/8" = 1'-0" (unless noted otherwise)

PLOT DATE: Jun 14, 2024

PROJECT NO. DRAWING NO.
2119 A4.2

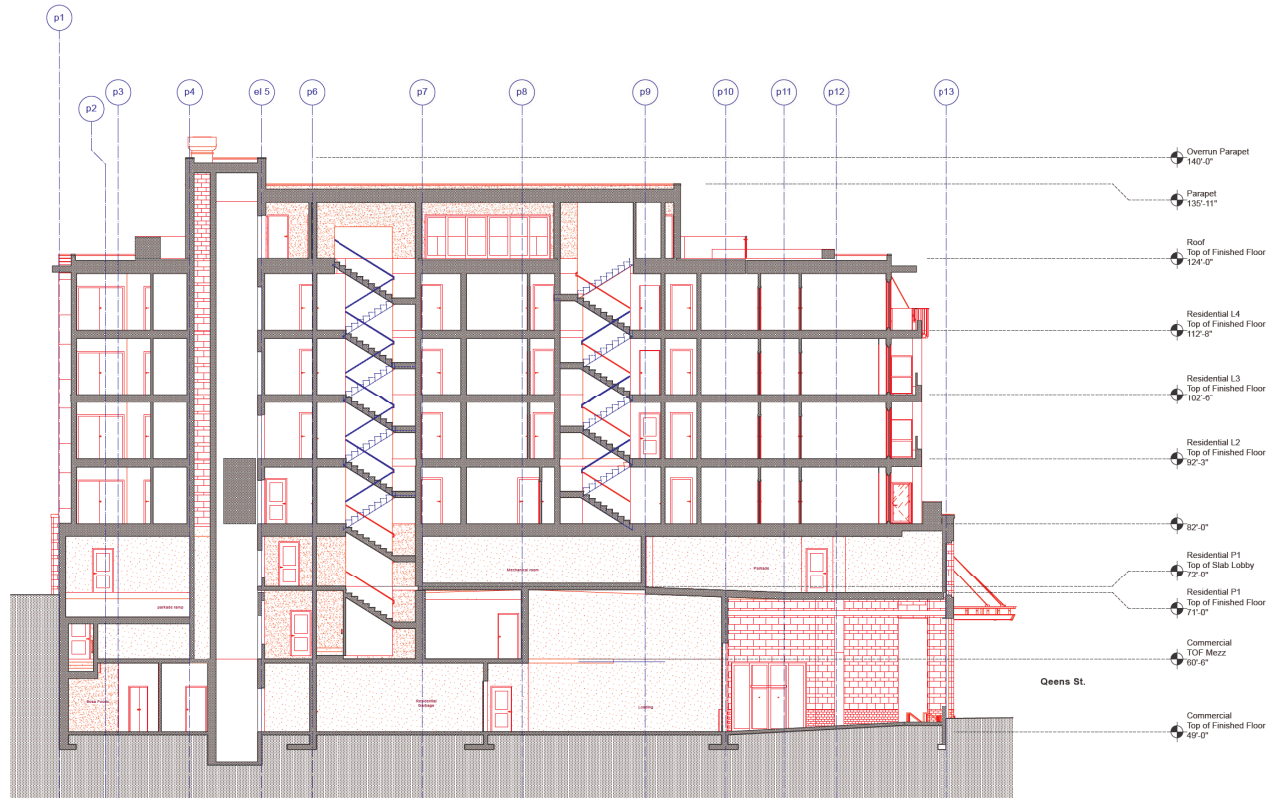

B Section B-B
A-4.2 Scale: 1/8" = 1'-0"



C
A 4.3 Section C-C
Scale: 1/8" = 1'-0"

CORNERSTONE
architecture

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Rev.	YY MM DD	ISSUE / REVISION
7	2024-06-14	Re-issue for OP Application
6	2024-03-22	Re-issue for OP Application
5	2023-06-19	Issue for OP Application
4	2023-06-05	Issue for Review
3	2023-01-18	Issue for Review
2	2022-11-07	Issue for Preliminary OP Application
1	2022-09-05	Issue for Review

PROJECT
Bosa Foods
2335 St Johns St


BUILDING CODE BCRC 2018
ZONING RM4, C3
DEVELOPMENT PERMIT #
BUILDING PERMIT #

DRAWING
Building Section C-C

Unless indicated, all notes, floor elevations and levels are to be verified by the contractor for accuracy. It is the contractor's responsibility to verify all dimensions and levels.
SCALE 1/8" = 1'-0" (unless noted otherwise)

PLOT DATE Jun 14, 2024

PROJECT NO. 2119
DRAWING NO. A4.3

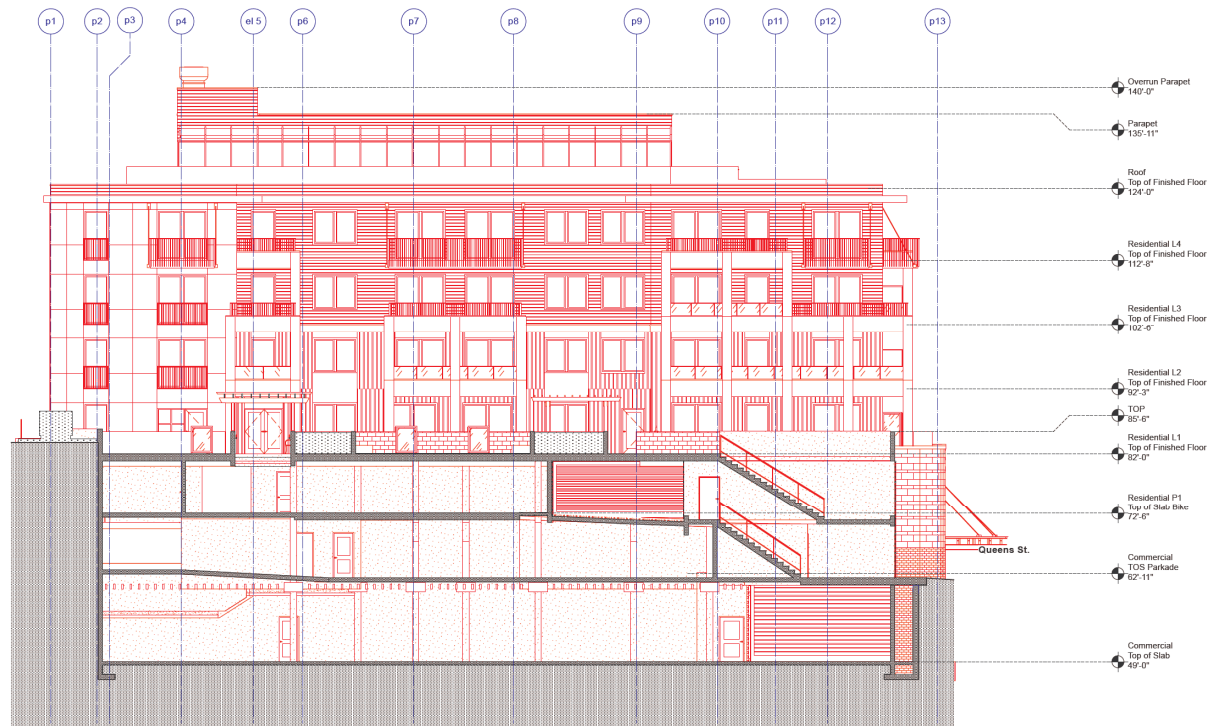

D
A4.4 Section D-D
Scale: 1/8" = 1'-0"

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Rev.	YY MM DD	ISSUE / REVISION
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4	2023-06-05	Issue for Review
3	2023-04-09	Issue for Review
2	2022-11-07	Issue for Preliminary CP Application
1	2022-09-05	Issue for Review

PROJECT
Bosa Foods
2335 St Johns St

BUILDING CODE BCRC 2018
ZONING RM4, C3
DEVELOPMENT PERMIT #
BUILDING PERMIT #

DRAWING
Building Section D-D


Unless indicated, all dimensions are to be taken from the approved 2D plan. Accuracy is for reference by a client of that party. Accuracy is general in this drawing.

SCALE 1/8" = 1'-0" (unless noted otherwise)

PLOT DATE Jun 14, 2024

PROJECT NO. 2119
DRAWING NO. **A4.4**

2335 St. Johns Street, Cornerstone 2024.06.14

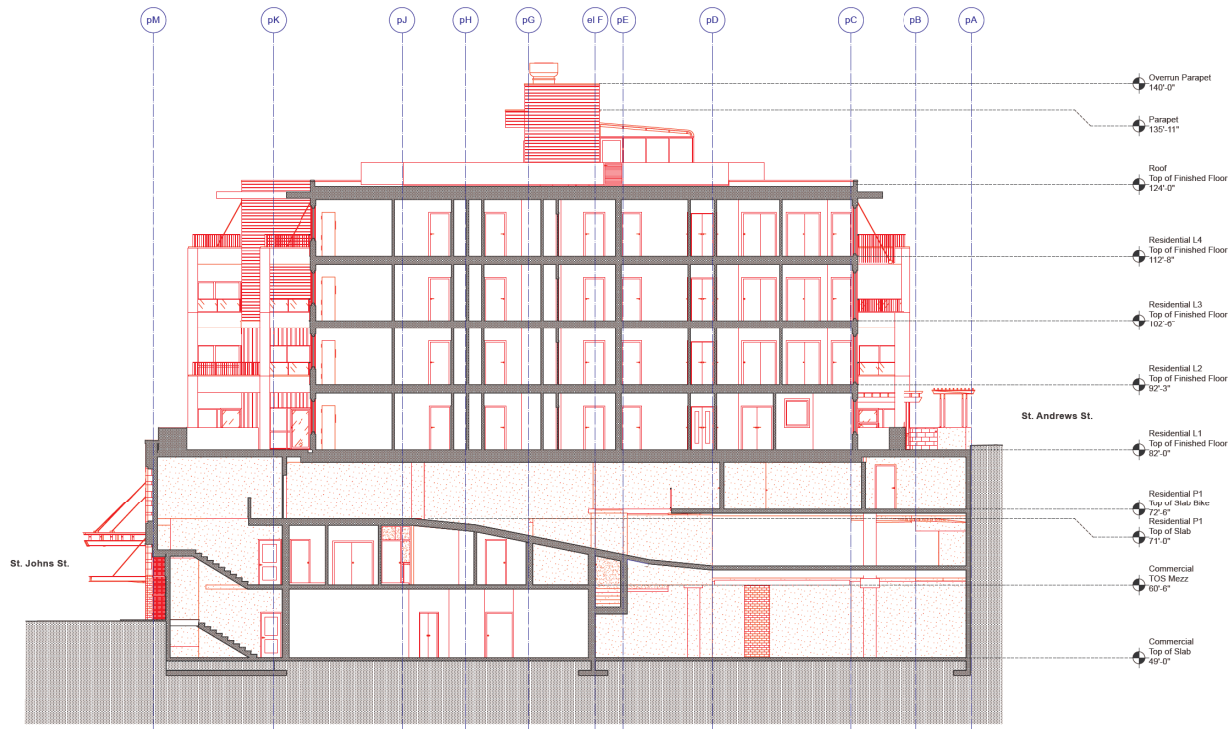

E
A 4.5 Section E-E
Scale: 1/8" = 1'-0"

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307 - 811 Alexander Street
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Tel: 904-255-8800

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7	2024-06-14	Re-issue for CP Application
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2	2022-11-07	Issue for Preliminary CP Application
1	2022-09-05	Issue for Review

Revis: YY MM DD **▲ ISSUE / REVISION ▼**

PROJECT
Bosa Foods
2335 St John's St

BUILDING CODE: BCRC 2018
ZONING: RM4, C3
DEVELOPMENT PERMIT #
BUILDING PERMIT #

DRAWING
Building Section E-E

SCALE: 1/8" = 1'-0" (unless noted otherwise)


PLOT DATE: Jun 14, 2024

PROJECT NO. DRAWING NO.
2119 A4.5



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F Section F-F
A 4.6 Scale: 1/8" = 1'-0"

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Notes: YY MM DD **▲ ISSUE / REVISION ▼**

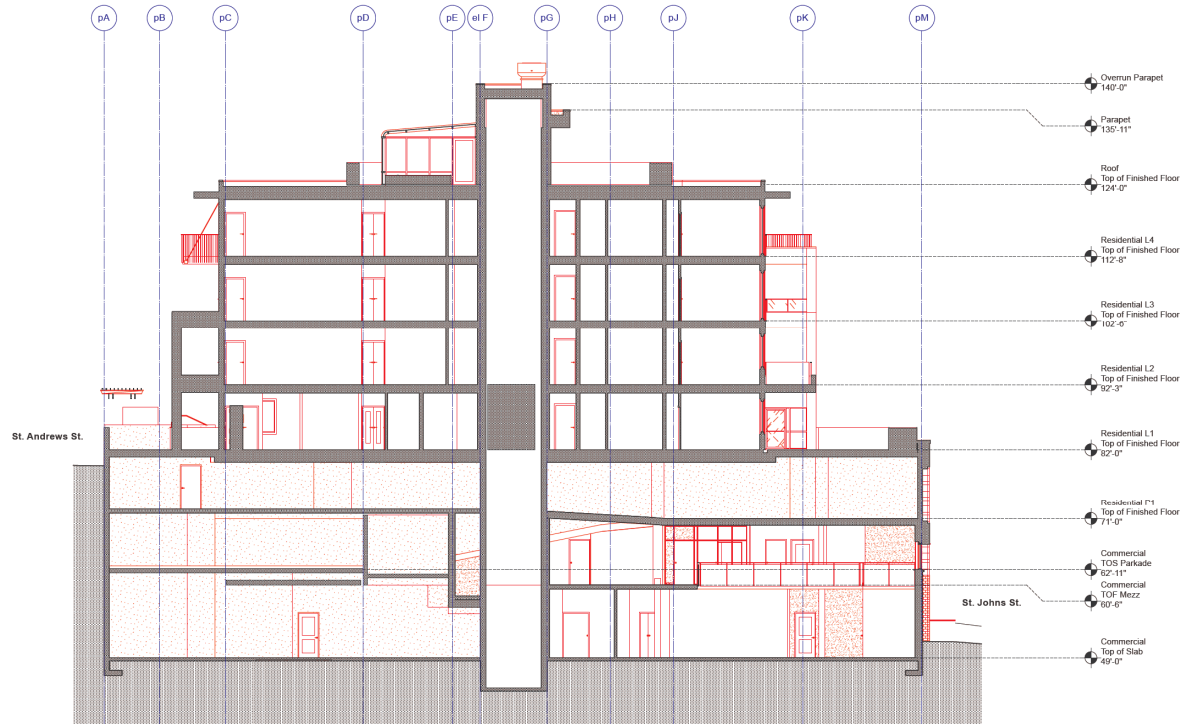PROJECT
Bosa Foods
2335 St Johns St


BUILDING CODE BCRC 2018
ZONING RM4, C3
DEVELOPMENT PERMIT #
BUILDING PERMIT #

DRAWING
Building Section F-F

Scale: 1/8" = 1'-0" (unless noted otherwise)

PLOT DATE Jun 14, 2024

PROJECT NO. DRAWING NO.
2119 **A4.6**

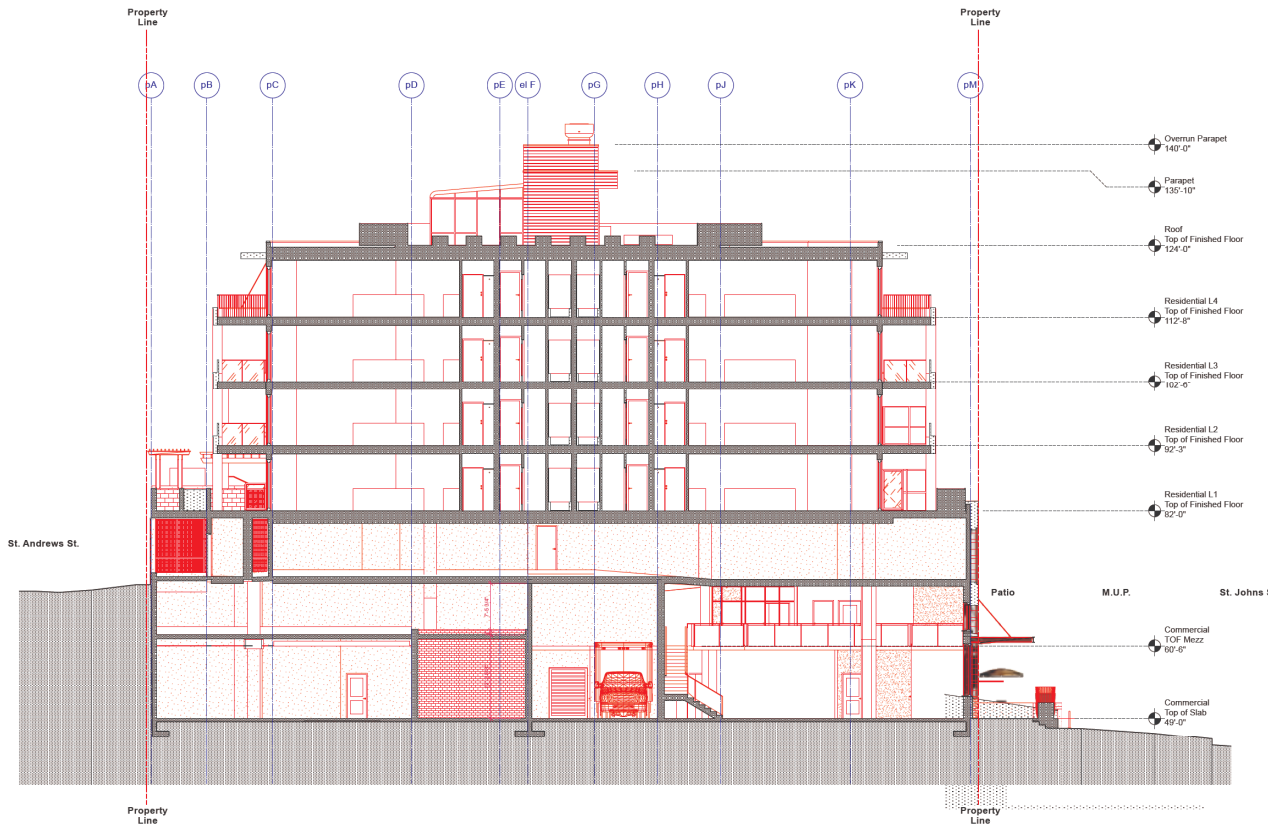

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Num. YY MM DD **▲ ISSUE / REVISION ▼**

PROJECT
Bosa Foods
2335 St Johns St

BUILDING CODE BCRC 2018
ZONING RM4, C3
DEVELOPMENT PERMIT #
BUILDING PERMIT #


DRAWING
Building Section G-G

SCALE 1/8" = 1'-0" (unless noted otherwise)

PLOT DATE Jun 14, 2024

PROJECT NO. 2119
DRAWING NO. **A4.7**

2335 St. Johns Street, Toronto, Ontario

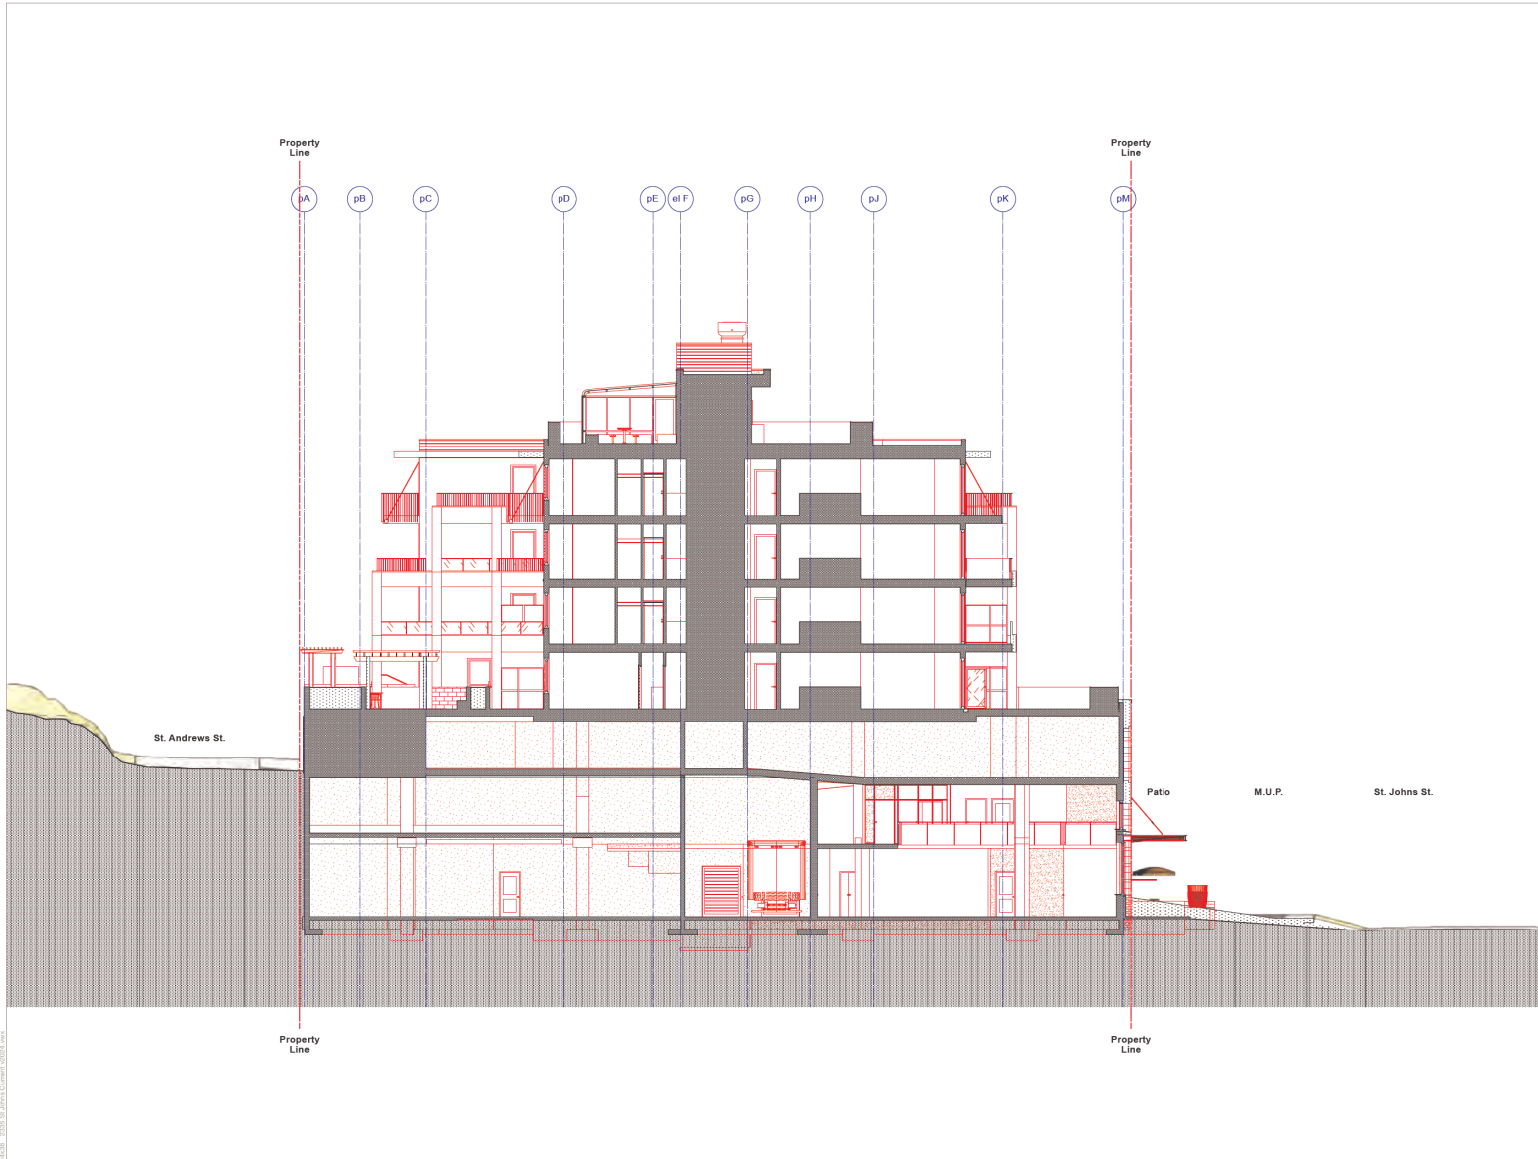

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1	2022-09-05	Issue for Review

Num. YY MM DD **▲ ISSUE / REVISION ▼**

PROJECT
Bosa Foods
2335 St Johns St

BUILDING CODE BCRC 2018
ZONING RM4, C3
DEVELOPMENT PERMIT #
BUILDING PERMIT #


DRAWING
Building Section G-2

SCALE 1/8" = 1'-0" (unless noted otherwise)

PLOT DATE Jun 14, 2024

PROJECT NO. 2119
DRAWING NO. **A4.7.1**

2119B - 2335 St Johns Street - 2024.rvt

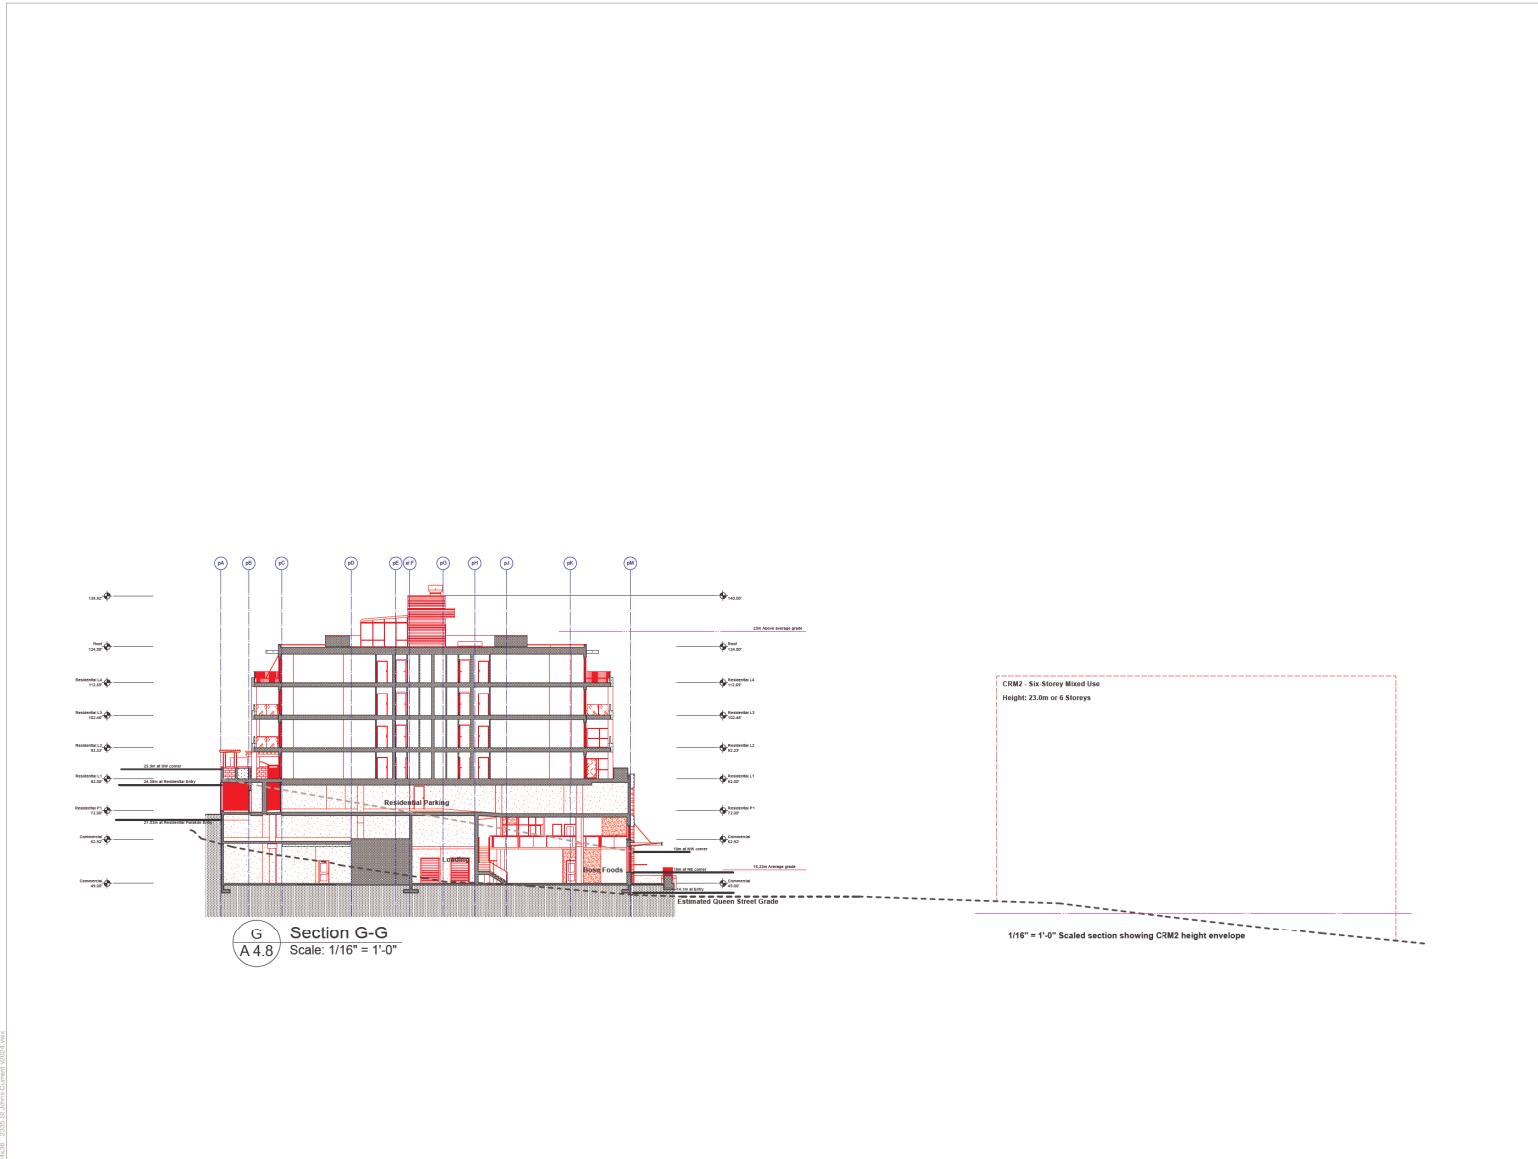

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Num. YY MM DD **▲ ISSUE / REVISION ▼**

PROJECT
Bosa Foods
2335 St Johns St

BUILDING CODE BCRC 2018
ZONING RM4, C3
DEVELOPMENT PERMIT #
BUILDING PERMIT #


DRAWING
Building Section G-G
Context

Unless indicated, all drawings are to be used for approval only and are not to be used for construction without the written consent of the Architect. This drawing is not to be used for construction until issued for that purpose by the Architect.


SCALE 1/8" = 1'-0" (unless noted otherwise)

PLOT DATE Jun 14, 2024


PROJECT NO. 2119 **DRAWING NO.** **A4.8**

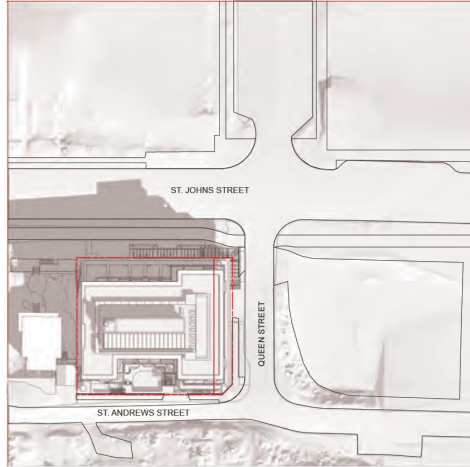


1 March 21st - 10:00AM

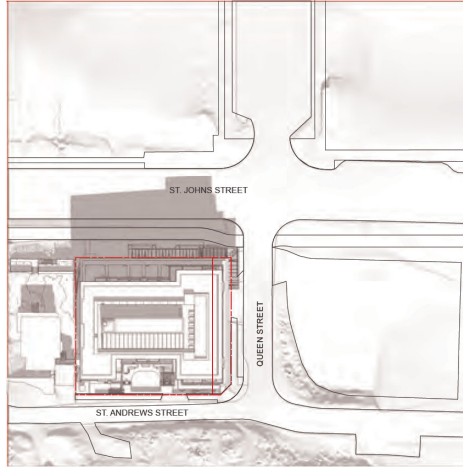


2 March 21st - 12:00PM

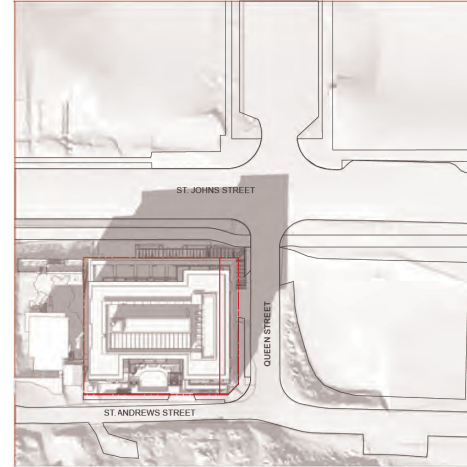


3 March 21st - 2:00PM

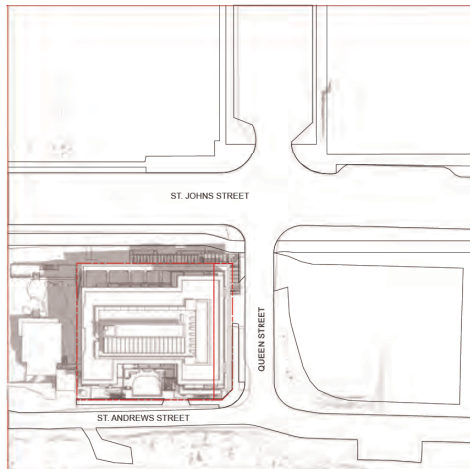

4 June 21st - 10:00AM

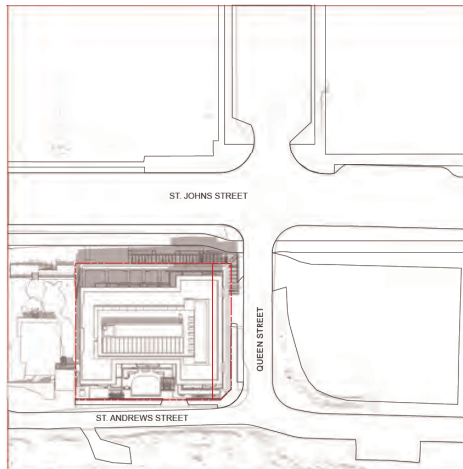

5 June 21st - 12:00PM

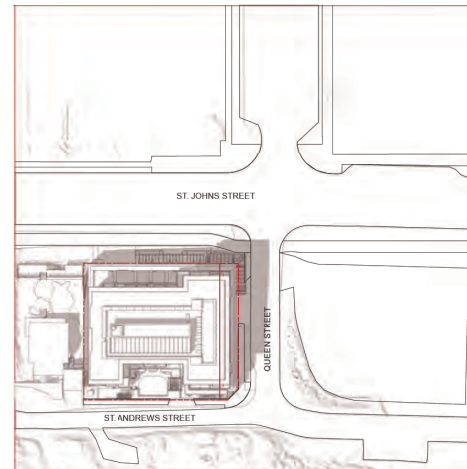

6 June 21st - 2:00PM

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Num. YY MM DD **▲ ISSUE / REVISION ▼**

PROJECT
Bosa Foods
2335 St Johns St


BUILDING CODE BCRC 2018
ZONING RM4, C3
DEVELOPMENT PERMIT #
BUILDING PERMIT #

DRAWING
Shadow Analysis

Scale: 1/8" = 1'-0" (unless noted otherwise)

PLOT DATE Jun 14, 2024

PROJECT NO. DRAWING NO.
2119 A5.1

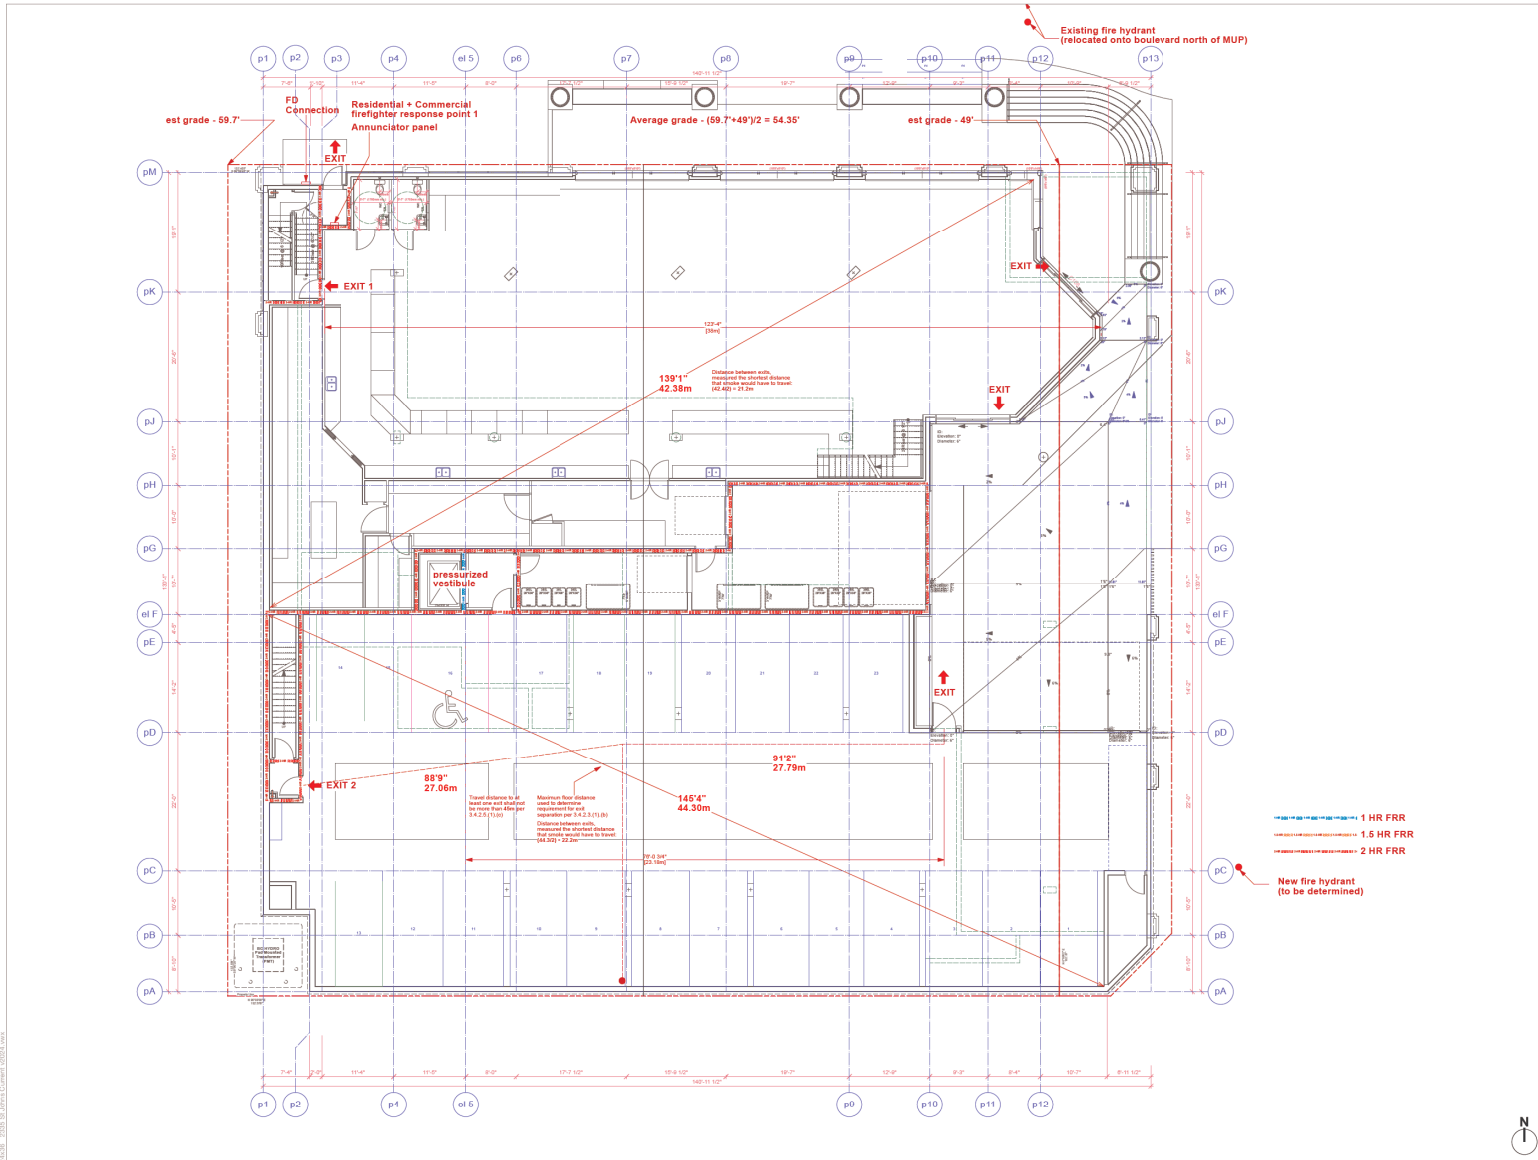

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PROJECT
Bosa Foods
2335 St Johns St

BUILDING CODE: BCRC 2018
ZONING: RM4, C3
DEVELOPMENT PERMIT #
BUILDING PERMIT #

DRAWING
Level 1 Code


SCALE: 1/8" = 1'-0" (unless noted otherwise)

PLOT DATE: Jun 14, 2024

PROJECT NO. 2119
DRAWING NO. A5.2



2/21/24 - 2335 St Johns Current 100% Area

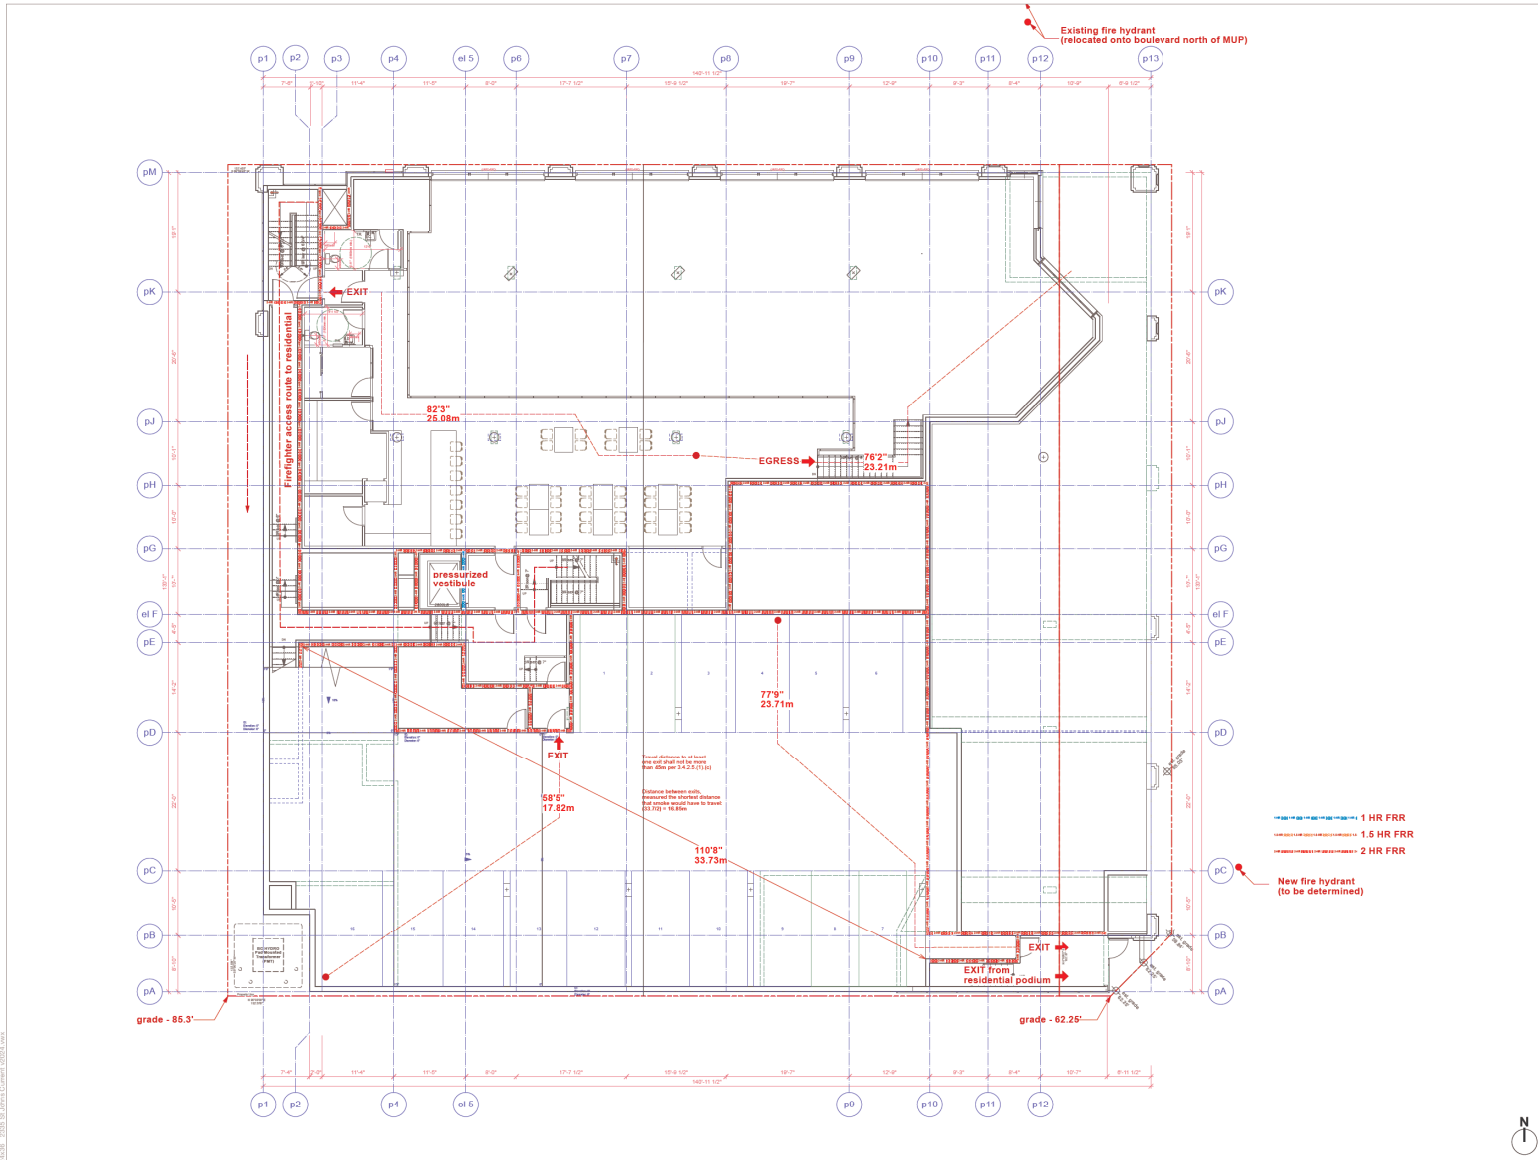

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1	2022-09-05	Issue for Review

PROJECT
Bosa Foods
 2335 St Johns St

BUILDING CODE BCRC 2018
ZONING RM4, C3
DEVELOPMENT PERMIT #
BUILDING PERMIT #


DRAWING
Level 1 Mezzanine Code

SCALE 1/8" = 1'-0" (unless noted otherwise)

PLOT DATE Jun 14, 2024

PROJECT NO. 2119
DRAWING NO. A5.3



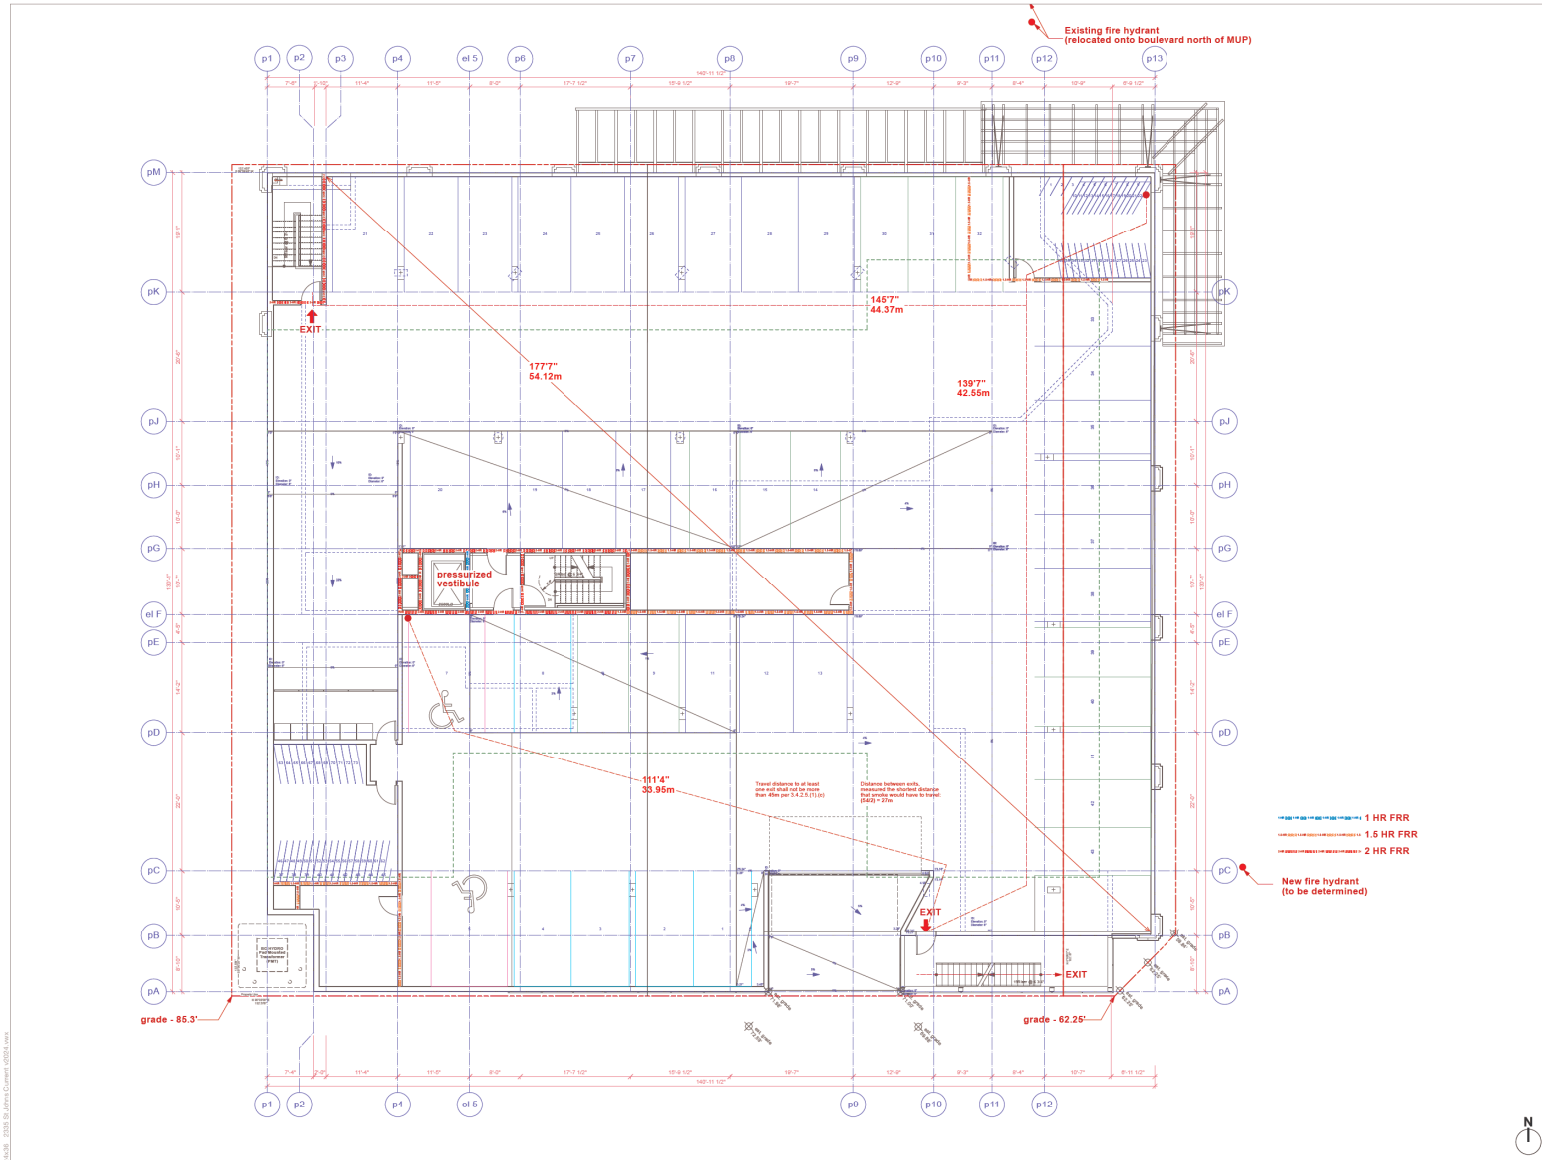

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PROJECT
Bosa Foods
2335 St Johns St


BUILDING CODE: BCRC 2018
ZONING: RM4, C3
DEVELOPMENT PERMIT #
BUILDING PERMIT #

DRAWING
Level 2 Parkade Code

SCALE: 1/8" = 1'-0" (unless noted otherwise)

PLOT DATE: Jun 14, 2024

PROJECT NO.: 2119
DRAWING NO.: A5.4

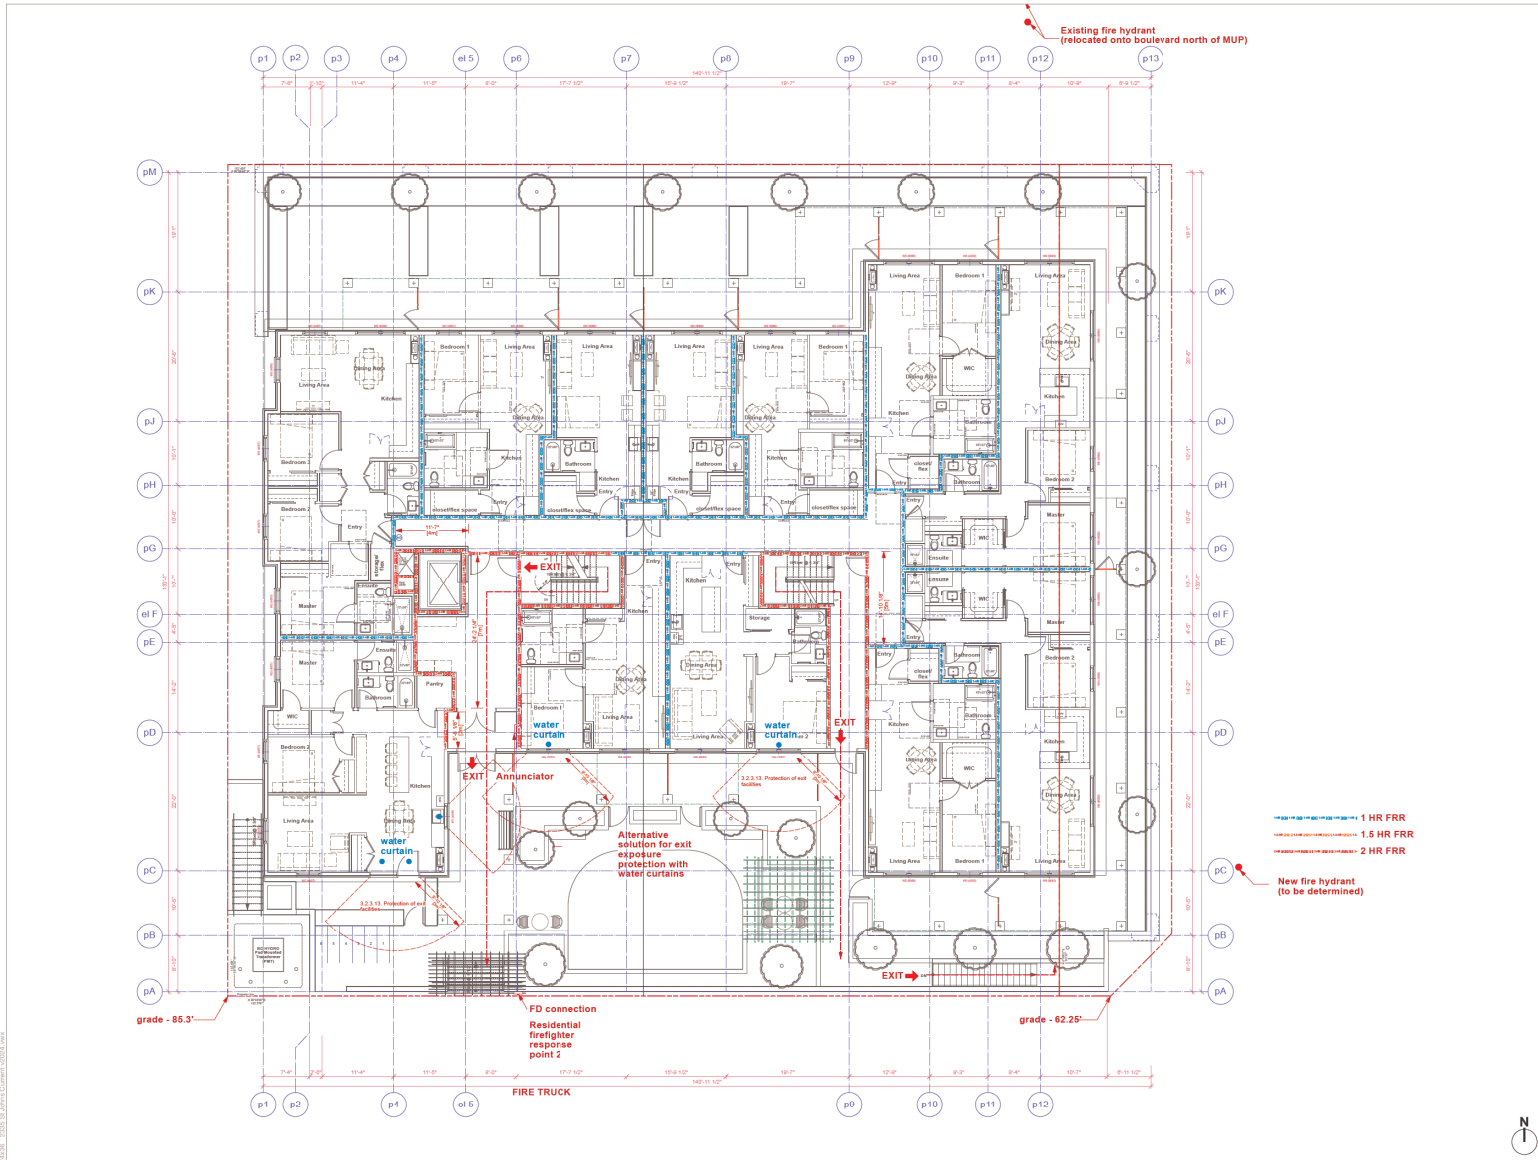

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7	2024-05-14	Rev Issue for DP Application
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PROJECT
Bosa Foods
2335 St Johns St

BUILDING CODE: BCRC 2018
ZONING: RM4, C3
DEVELOPMENT PERMIT #
BUILDING PERMIT #


DRAWING
Level 3 Code

SCALE: 1/8" = 1'-0" (unless noted otherwise)

PLOT DATE: Jun 14, 2024

PROJECT NO. 2119
DRAWING NO. **A5.5**

2/21/24 - 2335 St Johns Current 100% Rev.

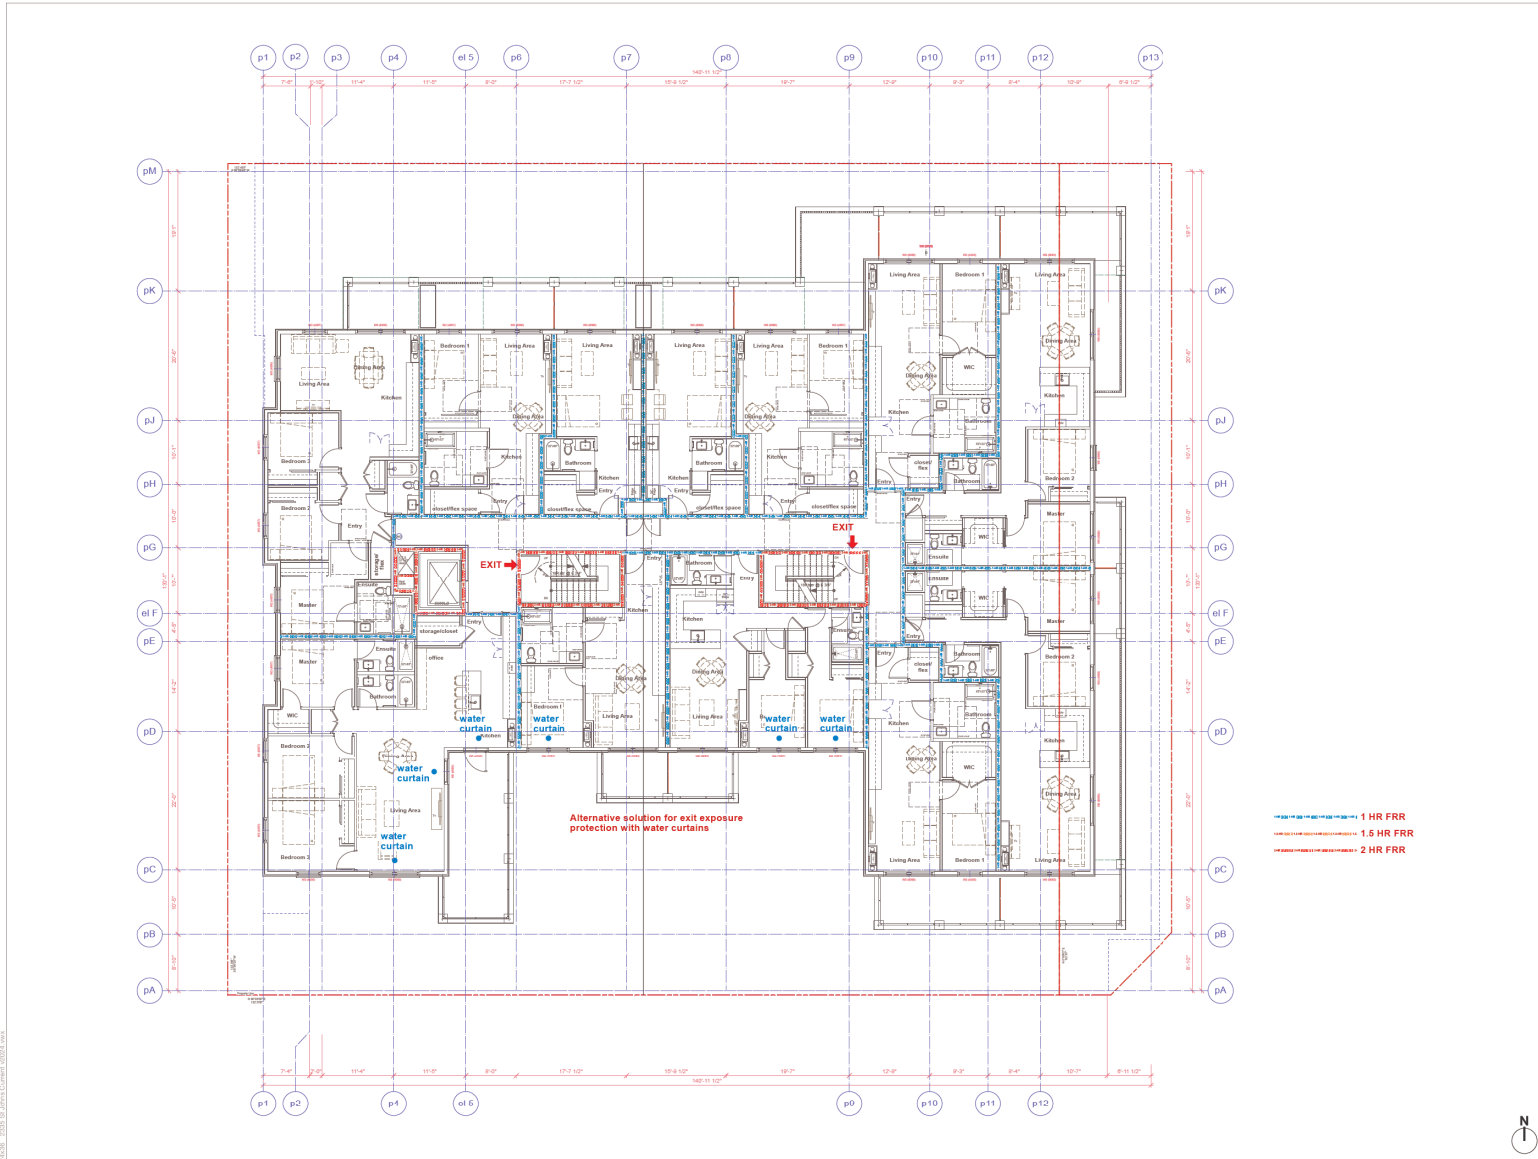

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PROJECT
Bosa Foods
 2335 St Johns St

BUILDING CODE BCRC 2018
ZONING RM4, C3
DEVELOPMENT PERMIT #
BUILDING PERMIT #


DRAWING
Level 4 Code

SCALE 1/8" = 1'-0" (unless noted otherwise)

PLOT DATE Jun 14, 2024

PROJECT NO. 2119
DRAWING NO. A5.6



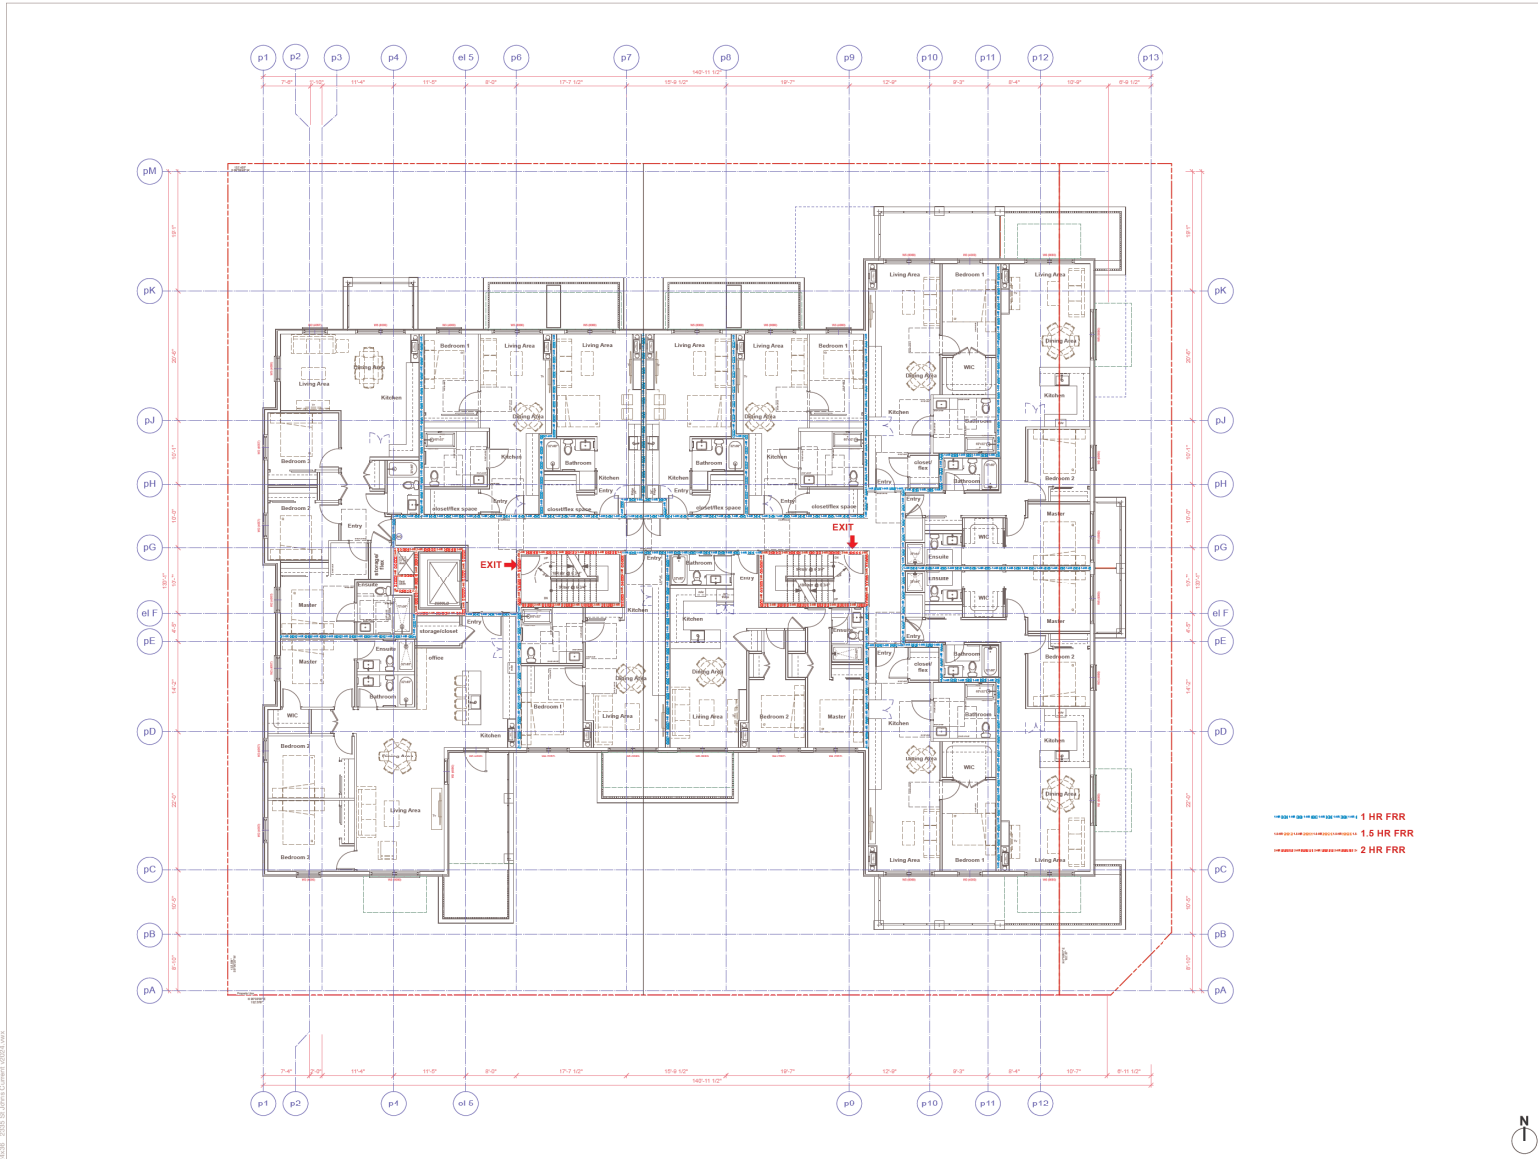

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PROJECT
Bosa Foods
 2335 St Johns St

BUILDING CODE BCRC 2018
ZONING RM4, C3
DEVELOPMENT PERMIT #
BUILDING PERMIT #

DRAWING
Level 5 Code


SCALE 1/8" = 1'-0" (unless noted otherwise)

PLOT DATE Jun 14, 2024

PROJECT NO. 2119
DRAWING NO. A5.7



2/21/24 - 2335 St Johns Court 100% Area

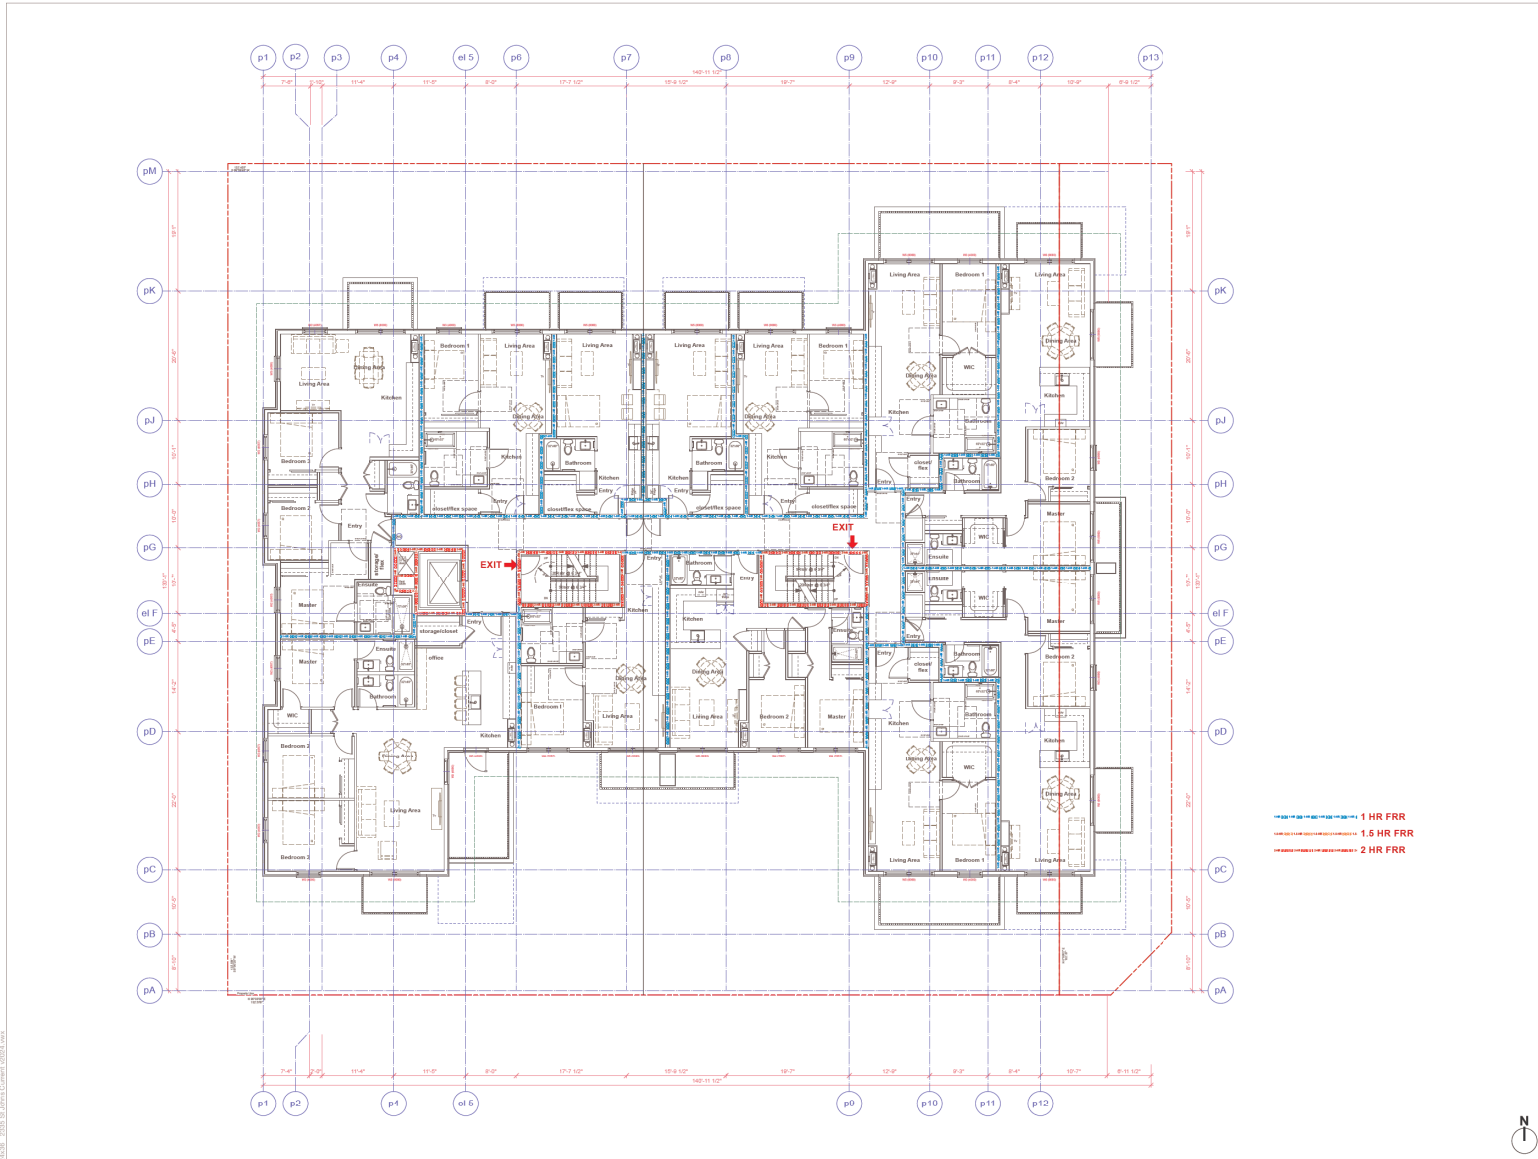

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PROJECT
Bosa Foods
 2335 St Johns St

BUILDING CODE BCRC 2018
ZONING RM4, C3
DEVELOPMENT PERMIT #
BUILDING PERMIT #

DRAWING
Level 6 Code


SCALE 1/8" = 1'-0" (unless noted otherwise)

PLOT DATE Jun 14, 2024

PROJECT NO. 2119
DRAWING NO. A5.8



2/21/24 - 2335 St Johns Current 100% Area

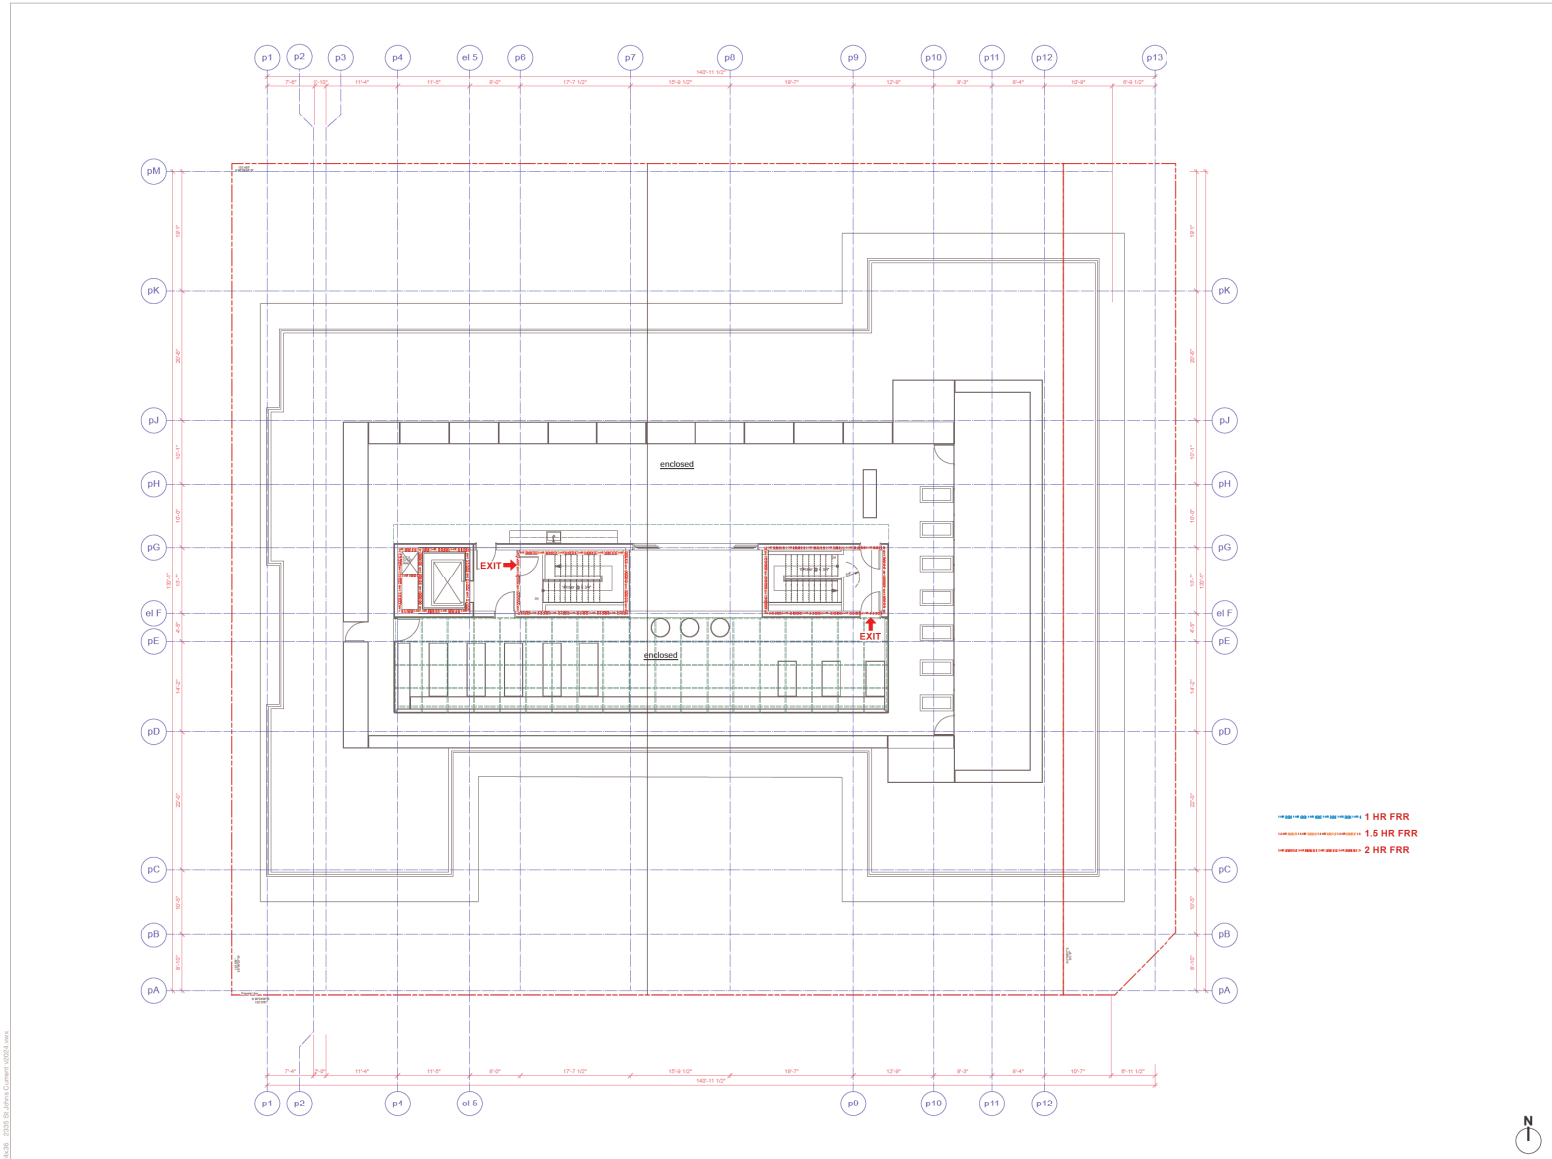

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PROJECT
Bosa Foods
2335 St Johns St

BUILDING CODE BCRC 2018
ZONING RM4, C3
DEVELOPMENT PERMIT #
BUILDING PERMIT #

DRAWING
Roof Code


SCALE 1/8" = 1'-0" (unless noted otherwise)

PLOT DATE Jun 14, 2024

PROJECT NO. 2119
DRAWING NO. A5.9



2335 St Johns St, Durham, NC 27611

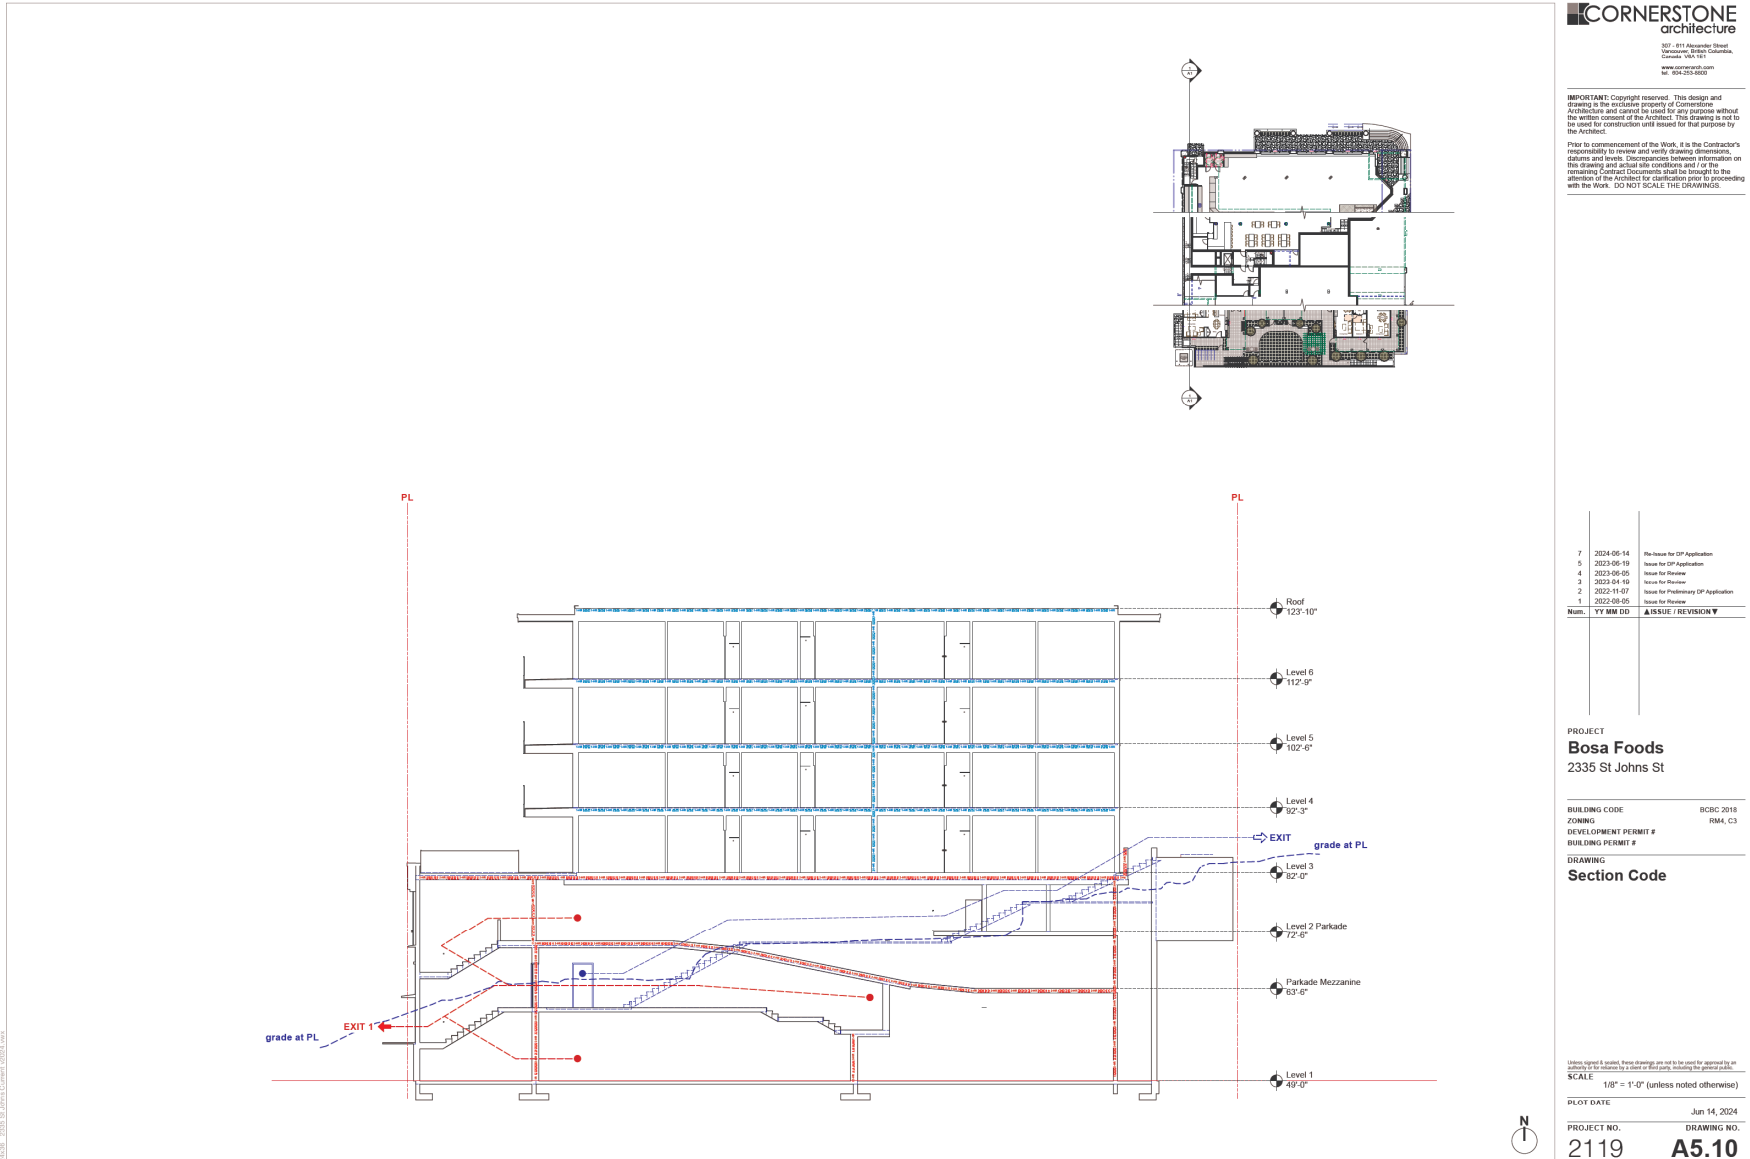

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PROJECT
Bosa Foods
2335 St Johns St

BUILDING CODE: BCRC 2018
ZONING: RM4, C3
DEVELOPMENT PERMIT #
BUILDING PERMIT #

DRAWING
Section Code

SCALE: 1/8" = 1'-0" (unless noted otherwise)

PLOT DATE: Jun 14, 2024

PROJECT NO. 2119
DRAWING NO. **A5.10**



2335 St Johns St, Toronto, Ontario M5A 1K1

Precedence Heritage Buildings



Old City Hall
2425 St. Johns St



P Burns & Co. Butcher Shop
2419 Clarke St



John's Barber Shop
2337 Clarke St



Tremaine Residence
205 Second Ave



Ioco Groceteria
Third Ave



Roe & Abernethy Grocery Store
2407-2409 Clarke St




Terra Cotta Colour




JamesHardie - Panel Siding
Cedarmill - Iron Gray




Shouldice Stone - Tapestry Finish
Desert Buff

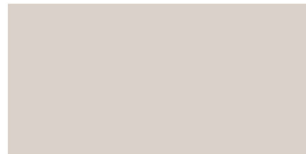

JamesHardie - Panel Siding
Smooth - Arctic White

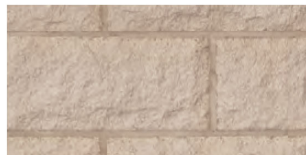

Shouldice Stone - Rock Finish
Desert Buff

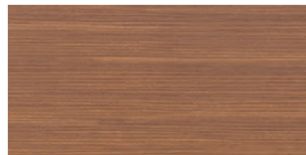

LUX metal - V-Groove Siding
Wood Grains - Pecan



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5	2023-06-19	Issue for CP Application
4	2023-06-05	Issue for Review
3	2023-05-18	Issue for Review
2	2022-11-07	Issue for Preliminary CP Application
1	2022-09-05	Issue for Review

Num. YY MM DD ▲ ISSUE / REVISION ▼

PROJECT
Bosa Foods
2335 St Johns St

BUILDING CODE BCRC 2018
ZONING RM4, C3
DEVELOPMENT PERMIT #
BUILDING PERMIT #

DRAWING
Material Board

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SCALE 1/8" = 1'-0" (unless noted otherwise)

PLOT DATE Jun 14, 2024

PROJECT NO. DRAWING NO.
2119 A6.0

Considered at the July 23, 2024, Regular Council meeting

763

Attachment 8



Top down view of the site



Northeast aerial view



Northwest aerial view



Southeast aerial view

CORNERSTONE
architecture

307-811 Alexander Street
Vancouver, British Columbia,
Canada V6A 1K1
www.cornerstone.ca
Tel: 604-255-8800

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7	2024-06-14	Re-issue for CP Application
6	2024-03-22	Re-issue for CP Application
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1	2022-09-05	Issue for Review

Num. YY MM DD ▲ ISSUE / REVISION ▼

PROJECT
Bosa Foods
2335 St Johns St

BUILDING CODE BCRC 2018
ZONING RM4, C3
DEVELOPMENT PERMIT #
BUILDING PERMIT #

DRAWING
Site Photos

(Unless specified, all units, floor dimensions and such to be used for approval by the authority to be obtained by a client of that party, including the owner or the contractor.)
SCALE 1/8" = 1'-0" (unless noted otherwise)

PLOT DATE Jun 14, 2024

PROJECT NO. 2119 DRAWING NO. **A6.1**



View across the Northwest intersection from the proposed podium level



View towards the West from the proposed level 6 deck



View towards the East from the proposed level 6 deck



View towards the North from the proposed level 6 deck

CORNERSTONE
architecture

307-311 Alexander Street
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2	2022-11-07	Issue for Preliminary CP Application
1	2022-09-05	Issue for Review

Num. YY MM DD ▲ ISSUE / REVISION ▼

PROJECT
Bosa Foods
2335 St Johns St

BUILDING CODE BCRC 2018
ZONING RM4, C3
DEVELOPMENT PERMIT #
BUILDING PERMIT #

DRAWING
Site Photos

(Unless specified, all notes, floor drawings and sets to be issued for approval are the property of the Architect and shall remain the property of the Architect.)

SCALE 1/8" = 1'-0" (unless noted otherwise)

PLOT DATE Jun 14, 2024

PROJECT NO. 2119
DRAWING NO. **A6.2**

Considered at the July 23, 2024, Regular Council meeting

765

Attachment 8



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architecture

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Vancouver, British Columbia,
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604.255.8800

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Prior to commencement of the Work, it is the Contractor's responsibility to review and verify drawing dimensions, details and levels. Discrepancies between information on this drawing and actual site conditions and/or the remaining Contract Documents shall be brought to the attention of the Architect for clarification prior to proceeding with the Work. **DO NOT SCALE THE DRAWINGS.**

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2	2022-11-07	Issue for Preliminary CP Application
1	2022-09-05	Issue for Review

Num. YY MM DD ▲ ISSUE / REVISION ▼

PROJECT
Bosa Foods
2335 St Johns St

BUILDING CODE BCRC 2018
ZONING RM4, C3
DEVELOPMENT PERMIT #
BUILDING PERMIT #

DRAWING
**Northeast
Perspective view**

(Unless specified, all units, floor elevations and such for the drawing are given in feet and inches. All units for a given set of drawings shall be given in the same units.)

SCALE 1/8" = 1'-0" (unless noted otherwise)

PLOT DATE Jun 14, 2024

PROJECT NO. DRAWING NO.
2119 A6.3

Considered at the July 23, 2024, Regular Council meeting

Attachment 8

East commercial parkade entry
from Queens St



Northeast retail entry
from St Johns St



CORNERSTONE
architecture

307 - 811 Alexander Street
Toronto, Ontario M5G 1S7
Canada V5A 1K1
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Tel: 904-255-8800

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6	2024-03-22	Re-issue for CP Application
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4	2023-06-05	Issue for Review
3	2023-01-18	Issue for Review
2	2022-11-07	Issue for Preliminary CP Application
1	2022-09-05	Issue for Review

Num. YY MM DD **▲ ISSUE / REVISION ▼**

PROJECT
Bosa Foods
2335 St Johns St

BUILDING CODE BCRC 2018
ZONING RM4, C3
DEVELOPMENT PERMIT #
BUILDING PERMIT #

DRAWING
Perspective view

Unless specified, all notes, floor drawings and work to be done are approved by the Authority to be obtained by a member of the party. The general contractor shall be responsible for obtaining all necessary permits and approvals.

SCALE 1/8" = 1'-0" (unless noted otherwise)

PLOT DATE Jun 14, 2024

PROJECT NO. DRAWING NO.
2119 A6.4

Considered at the July 23, 2024, Regular Council meeting

767

Attachment 8



Residential entry from St Andrews St



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architecture

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Victoria, British Columbia,
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www.cornerstone.ca
Tel: 250-255-8800

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1	2022-08-05	Issue for Review

Num. YY MM DD **▲ ISSUE / REVISION ▼**

PROJECT
Bosa Foods
2335 St Johns St

BUILDING CODE BCRC 2018
ZONING RM4, C3
DEVELOPMENT PERMIT #
BUILDING PERMIT #

DRAWING
Perspective view

Unless specified, standard floor drawings are not to be scaled for approval but are intended to be shown by a contractor at their own risk.
SCALE 1/8" = 1'-0" (unless noted otherwise)

PLOT DATE Jun 14, 2024

PROJECT NO. 2119
DRAWING NO. A6.5

2119B - 2335 St Johns Street 2024.06.14

Considered at the July 23, 2024, Regular Council meeting

Attachment 8



Northwest view from St Johns St



West view from the neighbour's yard

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Vancouver, British Columbia,
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Tel: 604-255-8800

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Prior to commencement of the Work, it is the Contractor's responsibility to review and verify drawing dimensions, details and levels. Discrepancies between information on this drawing and actual site conditions and/or the remaining Contract Documents shall be brought to the attention of the Architect for clarification prior to proceeding with the Work. **DO NOT SCALE THE DRAWINGS.**

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1	2022-09-05	Issue for Review

Num. YY MM DD **▲ ISSUE / REVISION ▼**

PROJECT
Bosa Foods
2335 St Johns St

BUILDING CODE BCRC 2018
ZONING RM4, C3
DEVELOPMENT PERMIT #
BUILDING PERMIT #

DRAWING
Perspective view

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SCALE 1/8" = 1'-0" (unless noted otherwise)

PLOT DATE Jun 14, 2024

PROJECT NO. DRAWING NO.
2119 A6.6

2119A - 2335 St Johns Street - 2024.06.14

Considered at the July 23, 2024, Regular Council meeting

769

Attachment 8



Southeast view from Queens St



Bird's eye view

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604-255-8800

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1	2022-08-05	Issue for Review

Num. YY MM DD **▲ ISSUE / REVISION ▼**

PROJECT
Bosa Foods
2335 St Johns St

BUILDING CODE BCRC 2018
ZONING RM4, C3
DEVELOPMENT PERMIT #
BUILDING PERMIT #


DRAWING
Perspective view

Unless specified, standard design practices shall be used for all drawings. The user is responsible for verifying the accuracy of the information provided by the client and for obtaining the necessary permits for the project.

SCALE 1/8" = 1'-0" (unless noted otherwise)

PLOT DATE Jun 14, 2024

PROJECT NO. 2119
DRAWING NO. **A6.7**

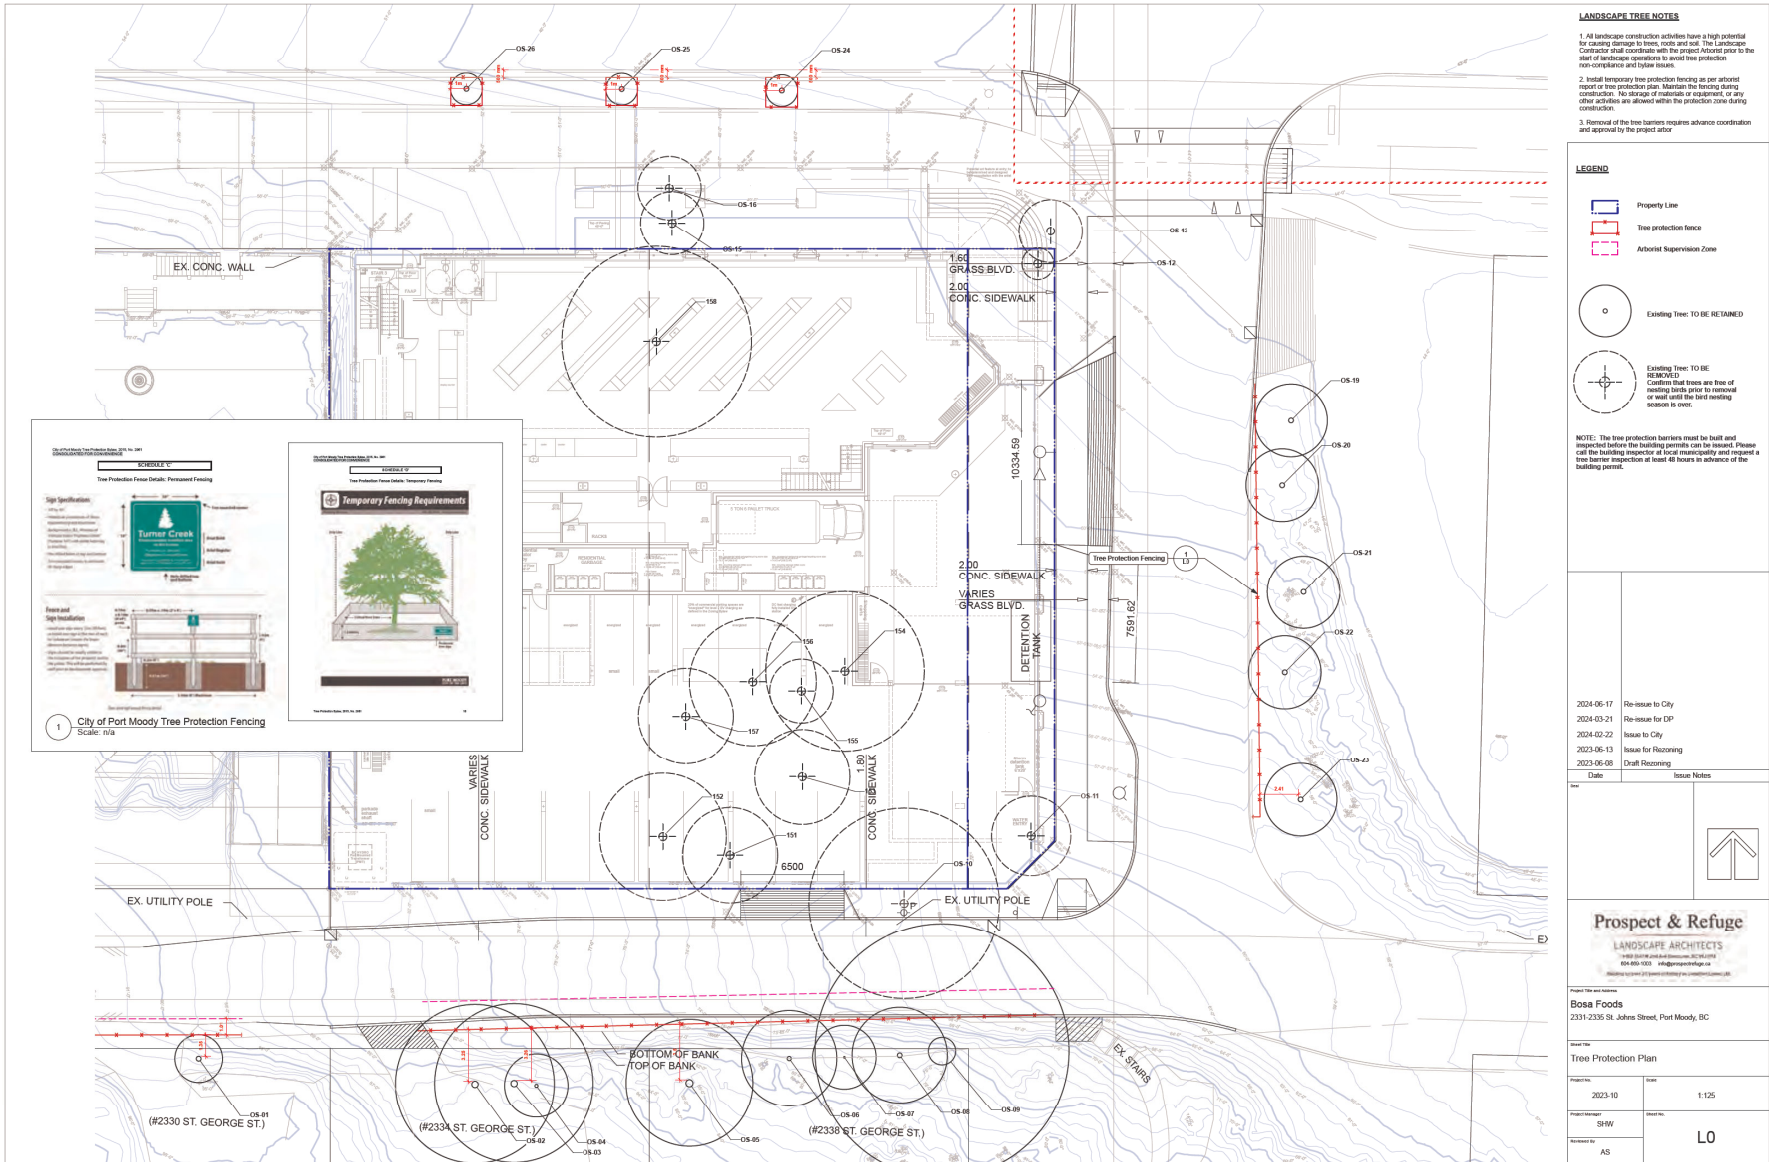

- LANDSCAPE TREE NOTES**
- All landscape construction activities have a high potential for causing damage to trees, roots and soil. The Landscape Contractor shall coordinate with the project architect prior to the start of landscape operations to avoid tree protection non-compliance and future issues.
 - Install temporary tree protection fencing as per arborist report or tree protection plan. Maintain the fencing during construction. No storage of materials or equipment, or any other activities are allowed within the protection zone during construction.
 - Removal of the tree barriers requires advance coordination and approval for the project arborist.

LEGEND

- Property Line
- Tree protection fence
- Arborist Supervision Zone

Existing Tree: TO BE RETAINED
 Existing Tree: TO BE REMOVED
 Confirm that trees are free of building debris prior to removal or wait until the fall planting season to event.

NOTE: The tree protection barriers must be built and inspected before the building permits can be issued. Please call the building inspector at local municipality and request a tree barrier inspection at least 48 hours in advance of the building permit.

2024-06-17	Re-issue to City
2024-03-21	Re-issue for DP
2024-02-22	Issue to City
2023-06-13	Issue for Re-zoning
2023-06-08	Draft Re-zoning

Date	Issue Notes
↑	

Prospect & Refuge
 LANDSCAPE ARCHITECTS
 1030 10th Ave West, Port Moody, BC V3H 2L6
 604-466-1022 | info@prospectandrefuge.ca

Project Site and Address:
Bosa Foods
 2331-2335 St. Johns Street, Port Moody, BC

Tree Protection Plan

Project No:	2023-10	Scale:	1:125
Project Manager:	SHW	Sheet No.:	LO
Author:	AS		


SCHEDULE C
 Tree Protection Fence Details: Permanent Fencing

SCHEDULE D
 Tree Protection Fence Details: Temporary Fencing

Sign Specifications

Tree and Sign Installation

City of Port Moody Tree Protection Fencing
 Scale: n/a

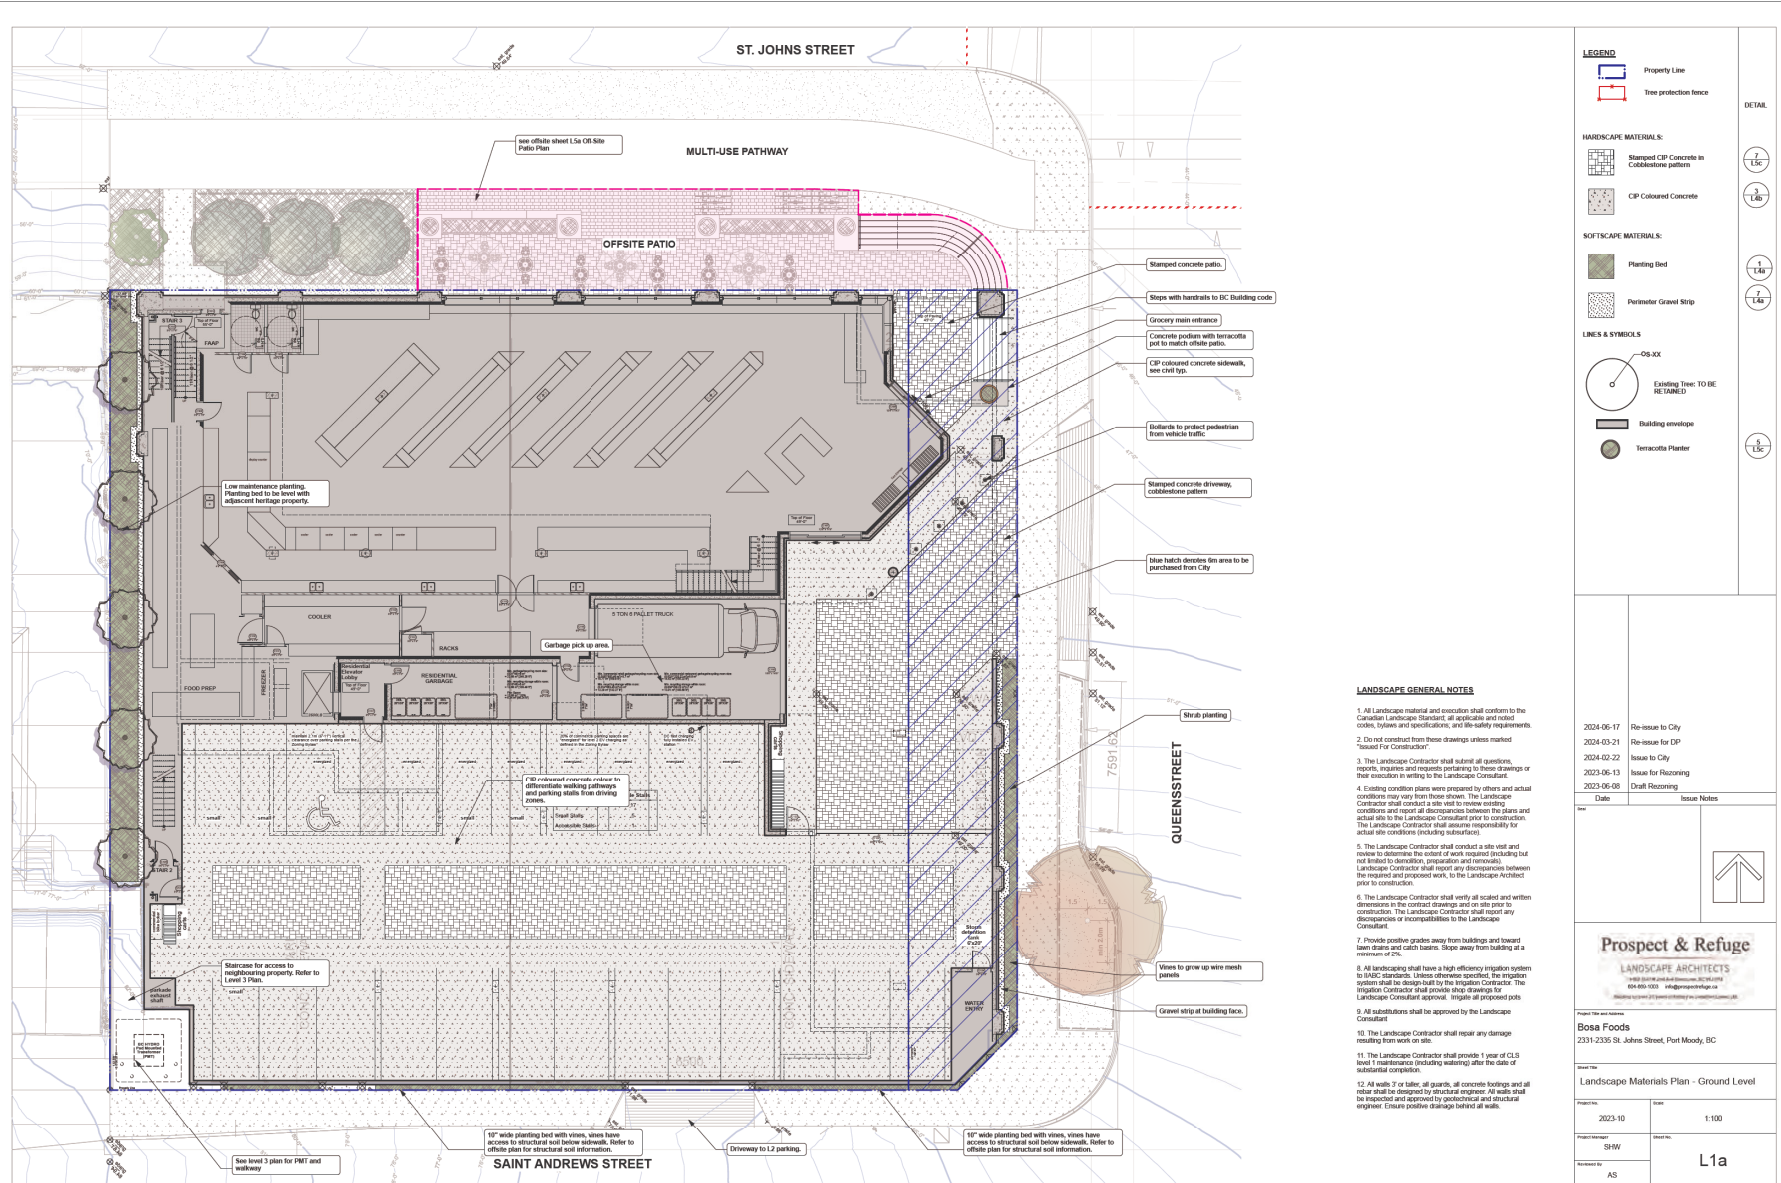



LEGEND

- Property Line
- HARDSCAPE MATERIALS:**
 - Hydrated Slab pavers
 - Artificial Turf Resilient Surfacing
- SOFTSCAPE MATERIALS:**
 - Planting Bed
- LINE & SYMBOLS**
 - Building envelope
 - Building roof overhang

DETAIL

- 1 L16
- 1 L16
- 1 L16

2024-06-17	Re-issue to City
2024-03-21	Re-issue for DP
2024-02-22	Issue to City
2023-06-13	Issue for Rezoning
2023-06-08	Draft Rezoning
Date	Issue Notes





Prospect & Refuge
 LANDSCAPE ARCHITECTS
 604-490-0323 | info@prospectandrefuge.com

Project Site and Address
Bosa Foods
 2331-2335 St. Johns Street, Port Moody, BC

Project Title
 Landscape Materials Plan - Level 3

Project No.	2023-10	Scale	1:100
-------------	---------	-------	-------

Project Manager	SHW	Detail No.	L1b
Architect	AS		

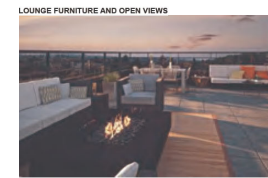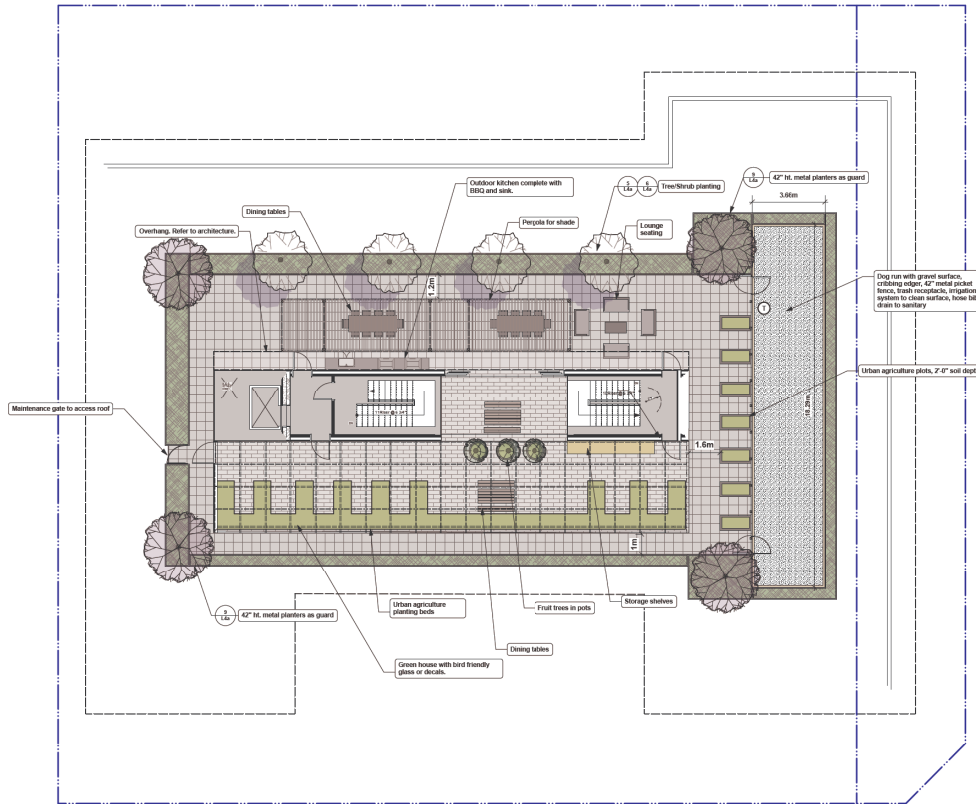

LEGEND

- Property Line
- Tree protection fence

HARDSCAPE MATERIALS:

- Hydrated Slab pavers

SOFTSCAPE MATERIALS:

- Planting Bed
- Urban Agriculture Bed
- Gravel Surface

LINE & SYMBOLS

- Building envelope
- Building roof overhang

DETAIL

L1B

L1C

Date	Issue Notes
2024-06-17	Re-issue to City
2024-03-21	Re-issue for DP
2024-02-22	Issue to City
2023-06-13	Issue for Rezoning
2023-06-08	Draft Rezoning
2023-05-17	Preliminary Concept



Prospect & Refuge

LANDSCAPE ARCHITECTS
 1008 2019th and 4th Street, Suite 201
 604-696-1022 info@prospectandrefuge.ca


Project Site and Address
Bosa Foods
 2331-2335 St. Johns Street, Port Moody, BC

Sheet Title
Landscape Materials Plan - Roof level

Project No. 2023-10 Date 1:100

Project Manager: SHW

Revised to: L1c

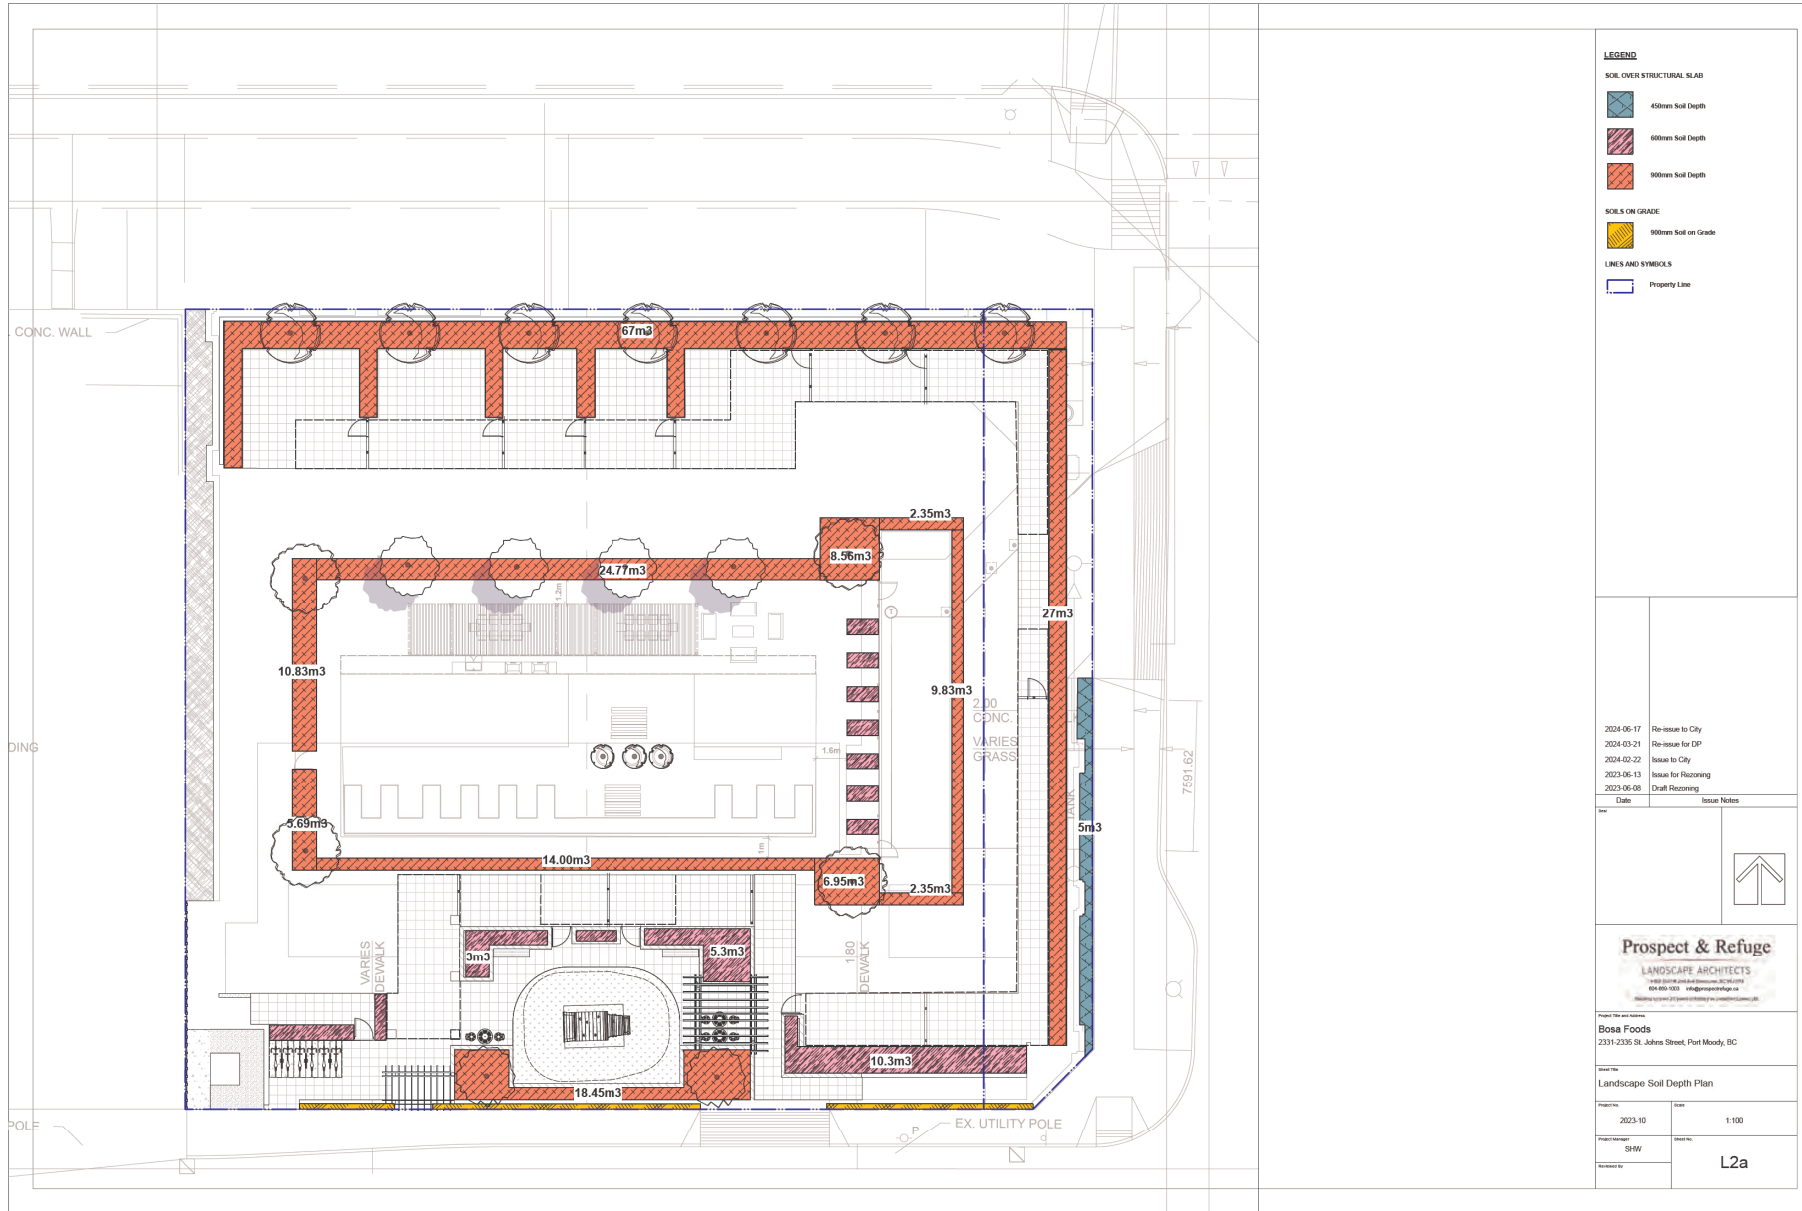

LEGEND

SOIL OVER STRUCTURAL SLAB

- 40mm Soil Depth
- 60mm Soil Depth
- 90mm Soil Depth

SOILS ON GRADE

- 90mm Soil on Grade

LINE AND SYMBOLS

- Property Line

2024-06-17	Re-issue to City
2024-03-21	Re-issue for DP
2024-02-22	Issue to City
2023-06-13	Issue for Rezoning
2023-06-08	Draft Rezoning
Date	Issue Notes



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 LANDSCAPE ARCHITECTS
 604-496-9333 | info@prospectandrefuge.ca


Project Site and Address
Bosa Foods
 2331-2335 St. Johns Street, Port Moody, BC

Project Name
 Landscape Soil Depth Plan


Project No. 2023-10 Scale 1:100

Project Manager: SHW
 Drawn by: L2a

Revised by:

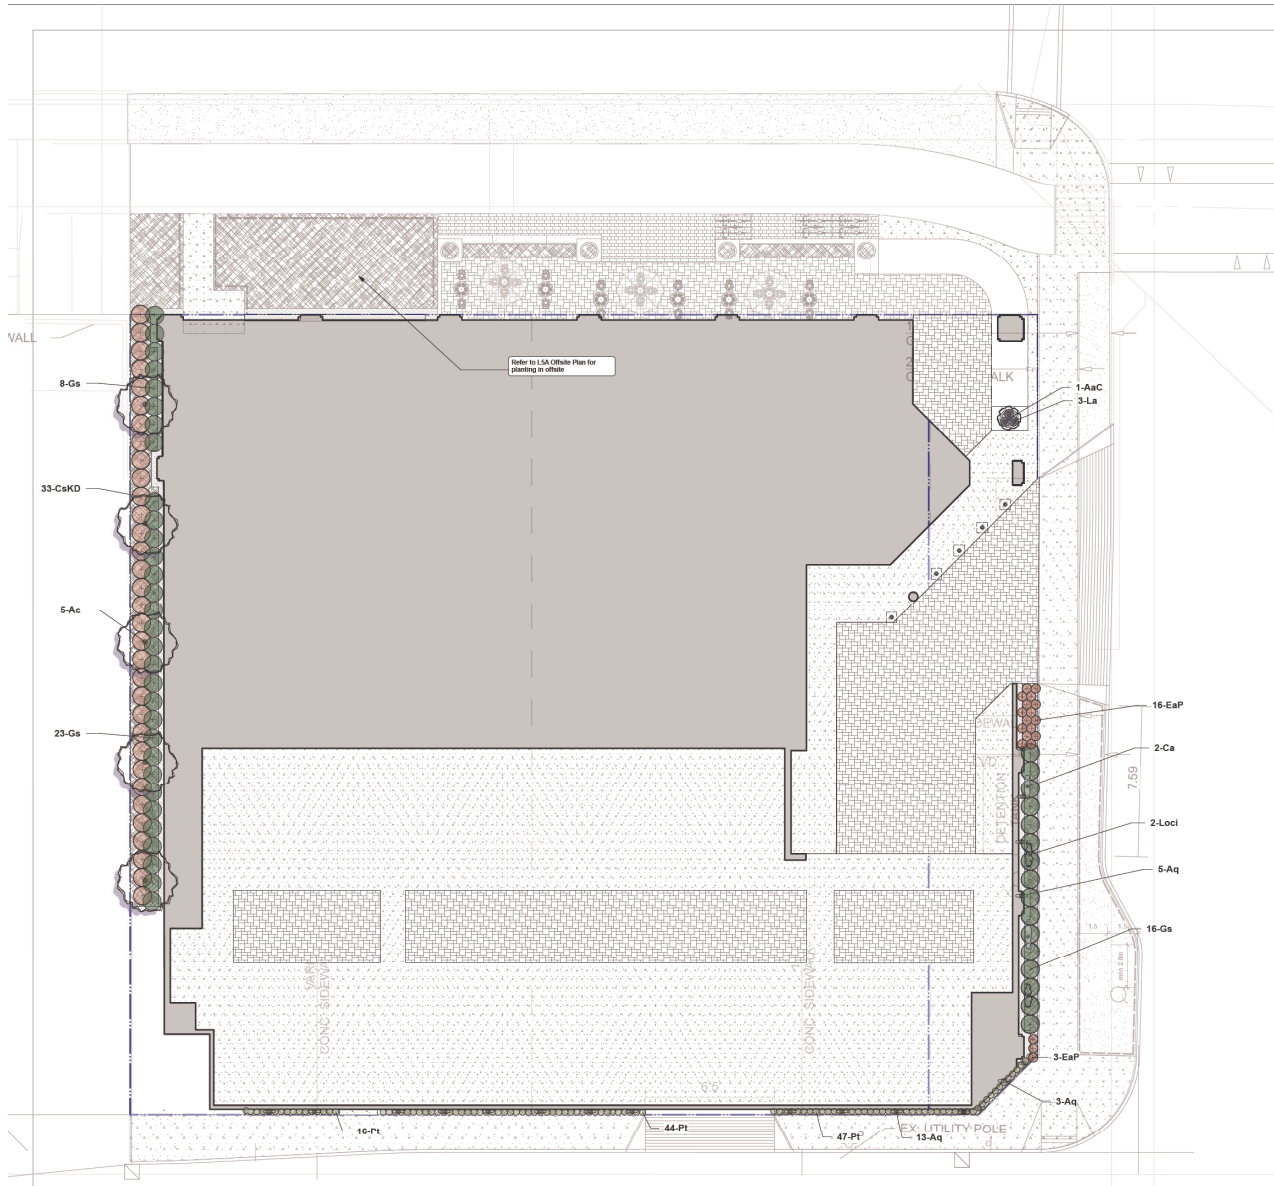

PLANT LIST - GROUND LEVEL					
ID	Latin Name	Common Name	Quantity	Scheduled Size	Notes
TREES					
Tc	<i>Acer circinnatum</i>	Vine maple	5	2.5 m H.	85% Native REPLACEMENT
SHRUBS					
Aa	<i>Abelia quercifolia</i>	Flowering Abelia	21	#1 pot	Cont.
AaC	<i>Andromeda amanda 'Compacta'</i>	Compact Andromeda Tree	1	#1 pot	See 1" file on spreadsheet. 8" & 8" Native
Ca	<i>Clematis armandi</i>	Evergreen Clematis	2	#1 pot @ 12" oc.	Cont.
CaD	<i>Cornus sericea 'Winter's Dream'</i>	Compact Red-Stem Dogwood	3	#1 pot @ 12" oc.	Cont.
EaP	<i>Eubothria angustifolia 'Purplea'</i>	Purple wood spurge	19	#1 pot @ 12" oc.	Cont. Native
Ga	<i>Geotheca spicata</i>	Lark	47	#1 pot @ 12" oc.	Cont. Native
La	<i>Lavandula angustifolia</i>	English Lavender	3	#1 pot @ 12" oc.	Cont. *Climate Resilient
Lc	<i>Leonora ciliosa</i>	Western Twayblade Homoglyca	2	#1 pot @ 12" oc.	Cont. Native
Pt	<i>Photunandra terminalis</i>	Japanese Spurge	107	#1 pot @ 12" oc.	Cont.
Assembled perennials selected by Landscape Architect					
			15	#1 pot	Cont.

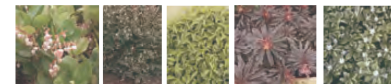

Shrubs & Groundcovers: Geotheca, Vaccinium, Cornus, Euphorbia, Pachysandra




Vines: Clematis armandi, Leonora ciliosa, Agavea galana



Trees: Acer circinnatum

2024-06-17	Re-issue to City
2024-03-21	Re-issue for DP
2024-02-22	Issue to City
2023-06-13	Issue for Rezoning
2023-06-08	Draft Rezoning
Date	Issue Notes
Prospect & Refuge LANDSCAPE ARCHITECTS 602-696-0322 info@prospectandrefuge.ca	
Project Site and Address: Bosa Foods 2331-2335 St. Johns Street, Port Moody, BC	
Project Title: Planting Plan Ground Level	
Project No:	Scale:
2023-10	1:100
Project Manager:	Drawn by:
SHW	L3a
Reviewed by:	
AS	

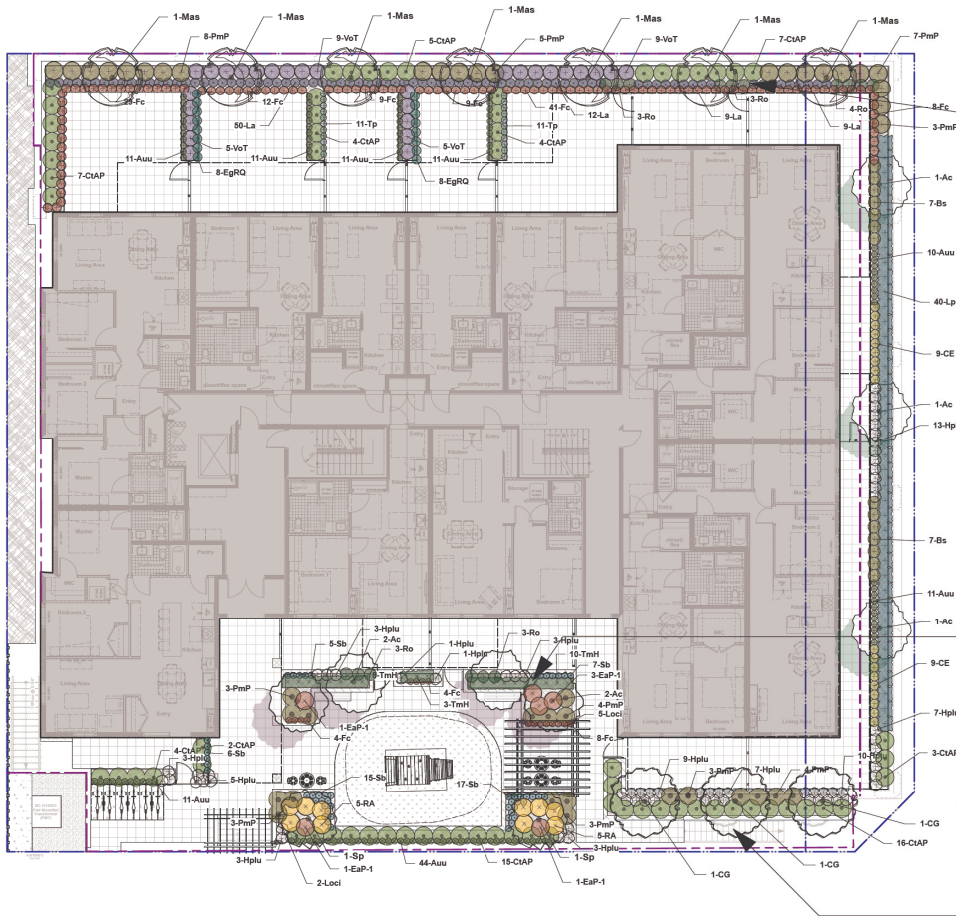

ID	Latin Name	Common Name	Quantity	Scheduled Size	Notes
Mys	Magnolia ovata	Star Magnolia	2	7m cal	REPLACEMENT TREE
St	Stewartia sinensis	Japanese Stewartia	2	7m cal	REPLACEMENT TREE
Ac	Acacia circulata	White myrtle	2	2m ht	REPL. Native
Ara	Arctostaphylos uva-ursi	Kanawasekwa	120	#1 pot @ 1-0" oc	Cont. Native
Bl	Blechnum spicant	Dear Fern	18	#1 pot @ 1-0" oc	Cont. Native
Co	Carex Tunburghii	Coastal Sedge Grass	18	#1 pot @ 1-0" oc	Cont.
ClAP	Choisya tomentosa 'Aster Pear'*	Aster Pear Mexican orange	87	#5 pot @ 3-0" oc	Cont.
Co	Cornus 'Spice'	Spice Spiceberry	3	2.0M ht	Cont.
EgRQ	Eriogonum grandiflorum 'Red Queen'	Red Queen Eriogonum	18	#1 pot @ 1-0" oc	Cont.
EgT	Euphorbia characias 'nana, white'	Sea Purslane Flower	8	#1 pot @ 3-0" oc	Cont.
Fc	Fragaria chilotensis	Beach Strawberry	124	4" pot @ 1-0" oc	Cont. Native
Hou	Hesperis 'Thorn Peppert'	Peppercorn Night-balm	88	#1 pot	Cont.
La	Lavandula angustifolia	English Lavender	80	#1 pot @ 1-0" oc	Cont. Climate Resilient
Lo	Lonicera cilicla	Weymouth Flower	2	#1 pot	Cont. Native
Lo	Lonicera pileata	Hebe	40	#3 pot @ 3-0" oc	Cont. Native
Msp	Pinus mugo 'Pumilio'	Mountain Mugo Pine	48	#3 pot @ 3-0" oc	Cont.
Rb	Rosa 'Assensio'	Hardy Double Rose	10	#5 pot @ 3-0" oc; 50% rose orange shd. tol. if reqd.	Cont.
Ro	Rousselia diffusa	Rousselia	18	#1 pot @ 2-0" oc	Cont. Climate Resilient
Sb	Sideroxylon 'Luna'	Luna's Fern	50	#1 pot @ 1-0" oc	Cont.
Tm	Taxus canadensis 'Tricolor'	Red Tip Taxus	21	4" pot @ 1-0" oc, Fall	Cont.
Th	Thymus praecox	Creeping Thyme	22	4" pot @ 1-0" oc	Cont.
V	Viburnum coccineum 'Redspice'	Redspice Viburnum	28	#3 pot @ 1-0" oc	Cont. Native
Un		Unlabeled specimen ordered by Landscape Architect	20	#1 pot	Cont.



Magnolia, Lavandula, Rousselia, Fragaria



Stewartia, Acacia circulata, Rosa, Choisya, Stachys, Pinus, Heuchera

2024-06-17	Re-issue to City
2024-03-21	Re-issue for DP
2024-02-22	Issue to City
2023-06-13	Issue for Reconciling
2023-06-08	Draft Reconciling



Prospect & Refuge
LANDSCAPE ARCHITECTS
2331-2335 St. Johns Street, Port Moody, BC

Project Name: Bosa Foods
2331-2335 St. Johns Street, Port Moody, BC


Project: Planning Plan Level 3

Project No:	Scale:
2023-10	1:100
Project Manager:	Sheet No.:
SHW	L3b
Reviewed by:	
AS	

Considered at the July 23, 2024, Regular Council meeting

777


Attachment 9

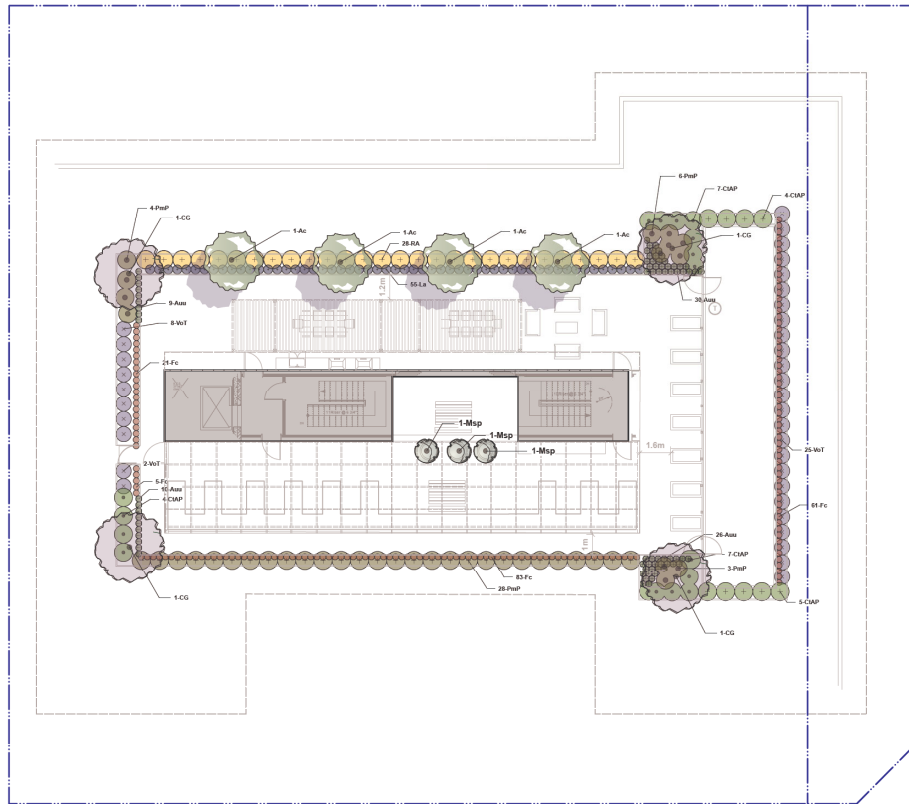



PLANT LIST - ROOF					
ID	Latin Name	Common Name	Quantity	Scheduled Size	Notes
TREES					
Ac	Acer glabrum	Vine maple	4	2M Ht.	8&S "Native"
CC	Cedrus 'Sneez'	Green Senebier	4	2.5M Ht.	8&S, Multistem, 3'x3' N to bottom of secondary branching
Wp	Malva syl	Armed Angel for Cross-Pollination	3	4'1" Cal., 3' standard	8 & S "Award winning, selected by I.A."
SHRUBS					
Aux	Arctostaphylos uva-ursi	Kinnikinnick	75	8" pot # 1'-0" oc	Cont. "Native"
CAFP	Choisya ternata 'Alice Pyle'	Alice Pyle Mexican orange	17	8" pot # 3'-0" oc	Cont.
Fc	Fragaria chionostema	Beach Strawberry	170	4" pot # 1'-0" oc	Cont. "Native"
L-L	Lamium angustifolia	English Lavender	150	8" pot # 1'-0" oc	Cont. "Common herbaceous"
Pmp	Pinus mugo 'Pumilo'	Pumilo Mugo Pine	41	8" pot # 3'-0" oc	Cont.
RA	Rosa 'Ravenshoe'	Royal Dark Rose	18	8" pot # 3'-0" oc, 3/4" rose	Cont.
Wat	Vaccinium ovatum 'Thunderbolt'	Thunderbolt European Huckleberry	35	8" pot # 2'-6" oc	Cont. "Native"
	Round weenah selected by Landscape Architects		15	8" pot	Cont.



Rapanea, Coonra, Malva, Lavandula, Rosmarinus, Rosa, Pinus, Choisyia, Vaccinium, Fragaria, Arctostaphylos

2024-06-17		Re-issue to City
2024-03-21		Re-issue for DP
2024-02-22		Issue to City
2023-06-13		Issue for Rezoning
2023-06-08		Draft Rezoning
Date	Issue Notes	
		
Prospect & Refuge LANDSCAPE ARCHITECTS 1030 201 St. John Street, Port Moody, BC 604-946-1033 info@prospectandrefuge.ca		
Project Site and Address: Bosa Foods 2331-2335 St. John Street, Port Moody, BC		
Issue Title: Planting Plan Roof		
Project No.	Date	Scale
2023-10		1:100
Project Manager	Sheet No.	
SWW		
Reviewed by	L3c	
AS		

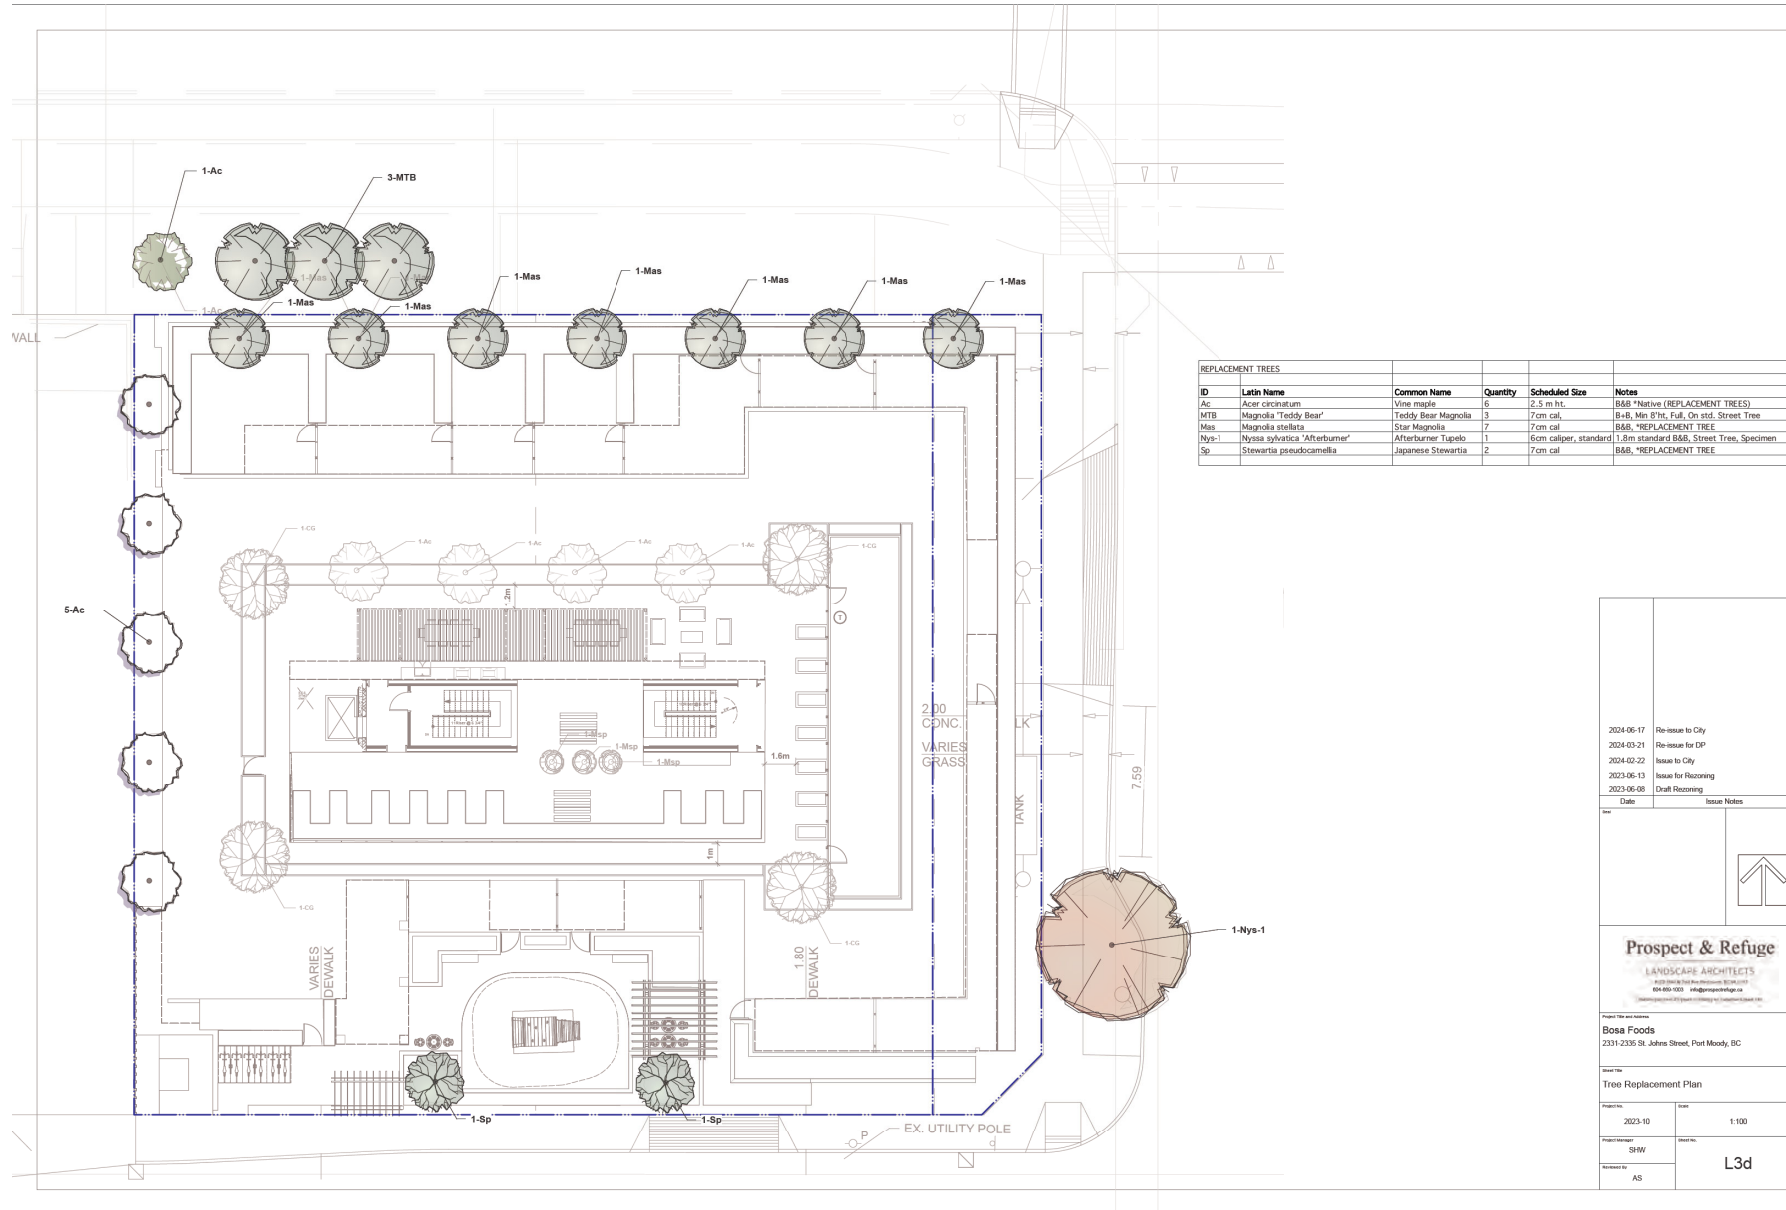

2024-06-17	Re-issue to City
2024-03-21	Re-issue for DP
2024-02-22	Issue to City
2023-06-13	Issue for Rezoning
2023-06-08	Draft Rezoning
Date	Issue Notes
	
Prospect & Refuge LANDSCAPE ARCHITECTS <small>4229 20th St. Port Moody, BC V3H 2L7 604-945-9323 info@prospectandrefuge.ca</small>	
Project Site and Address Bosa Foods 2331-2335 St. Johns Street, Port Moody, BC	
Tree Replacement Plan	
Project No:	Scale: 1:100
Project Manager: SHW	Drawn by: L3d
Reviewed by: AS	

1 Shrub and Perennial Planting
Scale: 1:24

NOTES:
1. Min. container size and root spread to comply with BC Landscape Standard for Nursery Stock - current edition.
2. Drain all damaged, diseased, and dead limbs.
3. Keep roots moist during installation: water container stock well prior to planting and following planting.
4. Soil for all on-slab applications to be a lightweight, free draining granular blend. Fines within soil blend to be less than 10%, combined, 30-50% sand, and 14-20% organic matter as defined in a soil analysis provided to the landscape architect for review and comment prior to delivery on site. Soil report shall be no older than one month.

2 Tree Planting
Scale: 1:25

NOTES:
1. Do not cut tree leader. Any corrective pruning shall be reviewed with landscape architect.
2. Selected trees shall be approved by Landscape Architect at the nursery or via photographs with scale reference. Trees rejected on site will be replaced at the contractor's expense.
3. Keep rootballs well watered on site, before and after planting. Ensure a watering plan is in place to sustain new tree plantings for a minimum of 60 days.
4. Soil for all on-slab applications to be a lightweight, free draining granular blend to meet Canadian Landscape Standard Part 10. Fines within soil blend to be less than 10%, as defined in a soil analysis provided to the landscape architect for review and comment prior to delivery on site. Soil report shall be no older than one month.

3 Top Soil
Scale: 1:25

NOTES:
1. Supply soil report to Landscape Consultant for approval prior to shipment to site. Soil report shall be dated no more than one month prior to delivery to site, and is to be submitted to Landscape Consultant with 1 week before installation.
2. Free draining granular blend with light weight coating.
3. Combined total depth of soil, drain rock and/or aggregate over structural slab never to exceed 150mm. Contact project structural engineer for further instruction, and requirements for light weight coating in any areas where built up over structural slab exceeds 150mm in depth.
4. Sand to be Fines River Pump sand, max 7% fines (400 μ sieve) with 60-70% medium sand and 15-20% coarse sand 15-20% fine sand content, free of suitable salts. Submit analysis to Landscape Consultant for review prior to shipment to site.

4 Lawn installation
Scale: 1:25

NOTES:
1. Supply soil report and analysis to Landscape Consultant for approval prior to shipment to site. Soil report shall be dated no more than one month prior to delivery to site, and is to be submitted to Landscape Consultant with 1 week before installation.
2. Soil depths to meet or exceed Canadian Landscape Standard for growing medium:
On-Slab: 150mm (6") Free Drain Structural Standard for Top Soil
Standard Growing Medium: Level 1 type 1B as per Canadian Landscape Standards unless otherwise noted.
3. Keep roots moist during installation: water container stock well prior to planting and following planting.

5 Shrub and Perennial Planting on Slab
Scale: 1:25

NOTES:
1. Min. container size and root spread to comply with BC Landscape Standard for Nursery Stock - current edition.
2. Drain all damaged, diseased, and dead limbs.
3. Keep roots moist during installation: water container stock well prior to planting and following planting.
4. Soil for all on-slab applications to be a lightweight, free draining granular blend to meet Canadian Landscape Standard Part 10. Fines within soil blend to be less than 10%, as defined in a soil analysis provided to the landscape architect for review and comment prior to delivery on site. Soil report shall be no older than one month.

6 Tree Planting on Slab
Scale: 1:25

NOTES:
1. Do not cut tree leader. Any corrective pruning shall be reviewed with landscape architect.
2. Selected trees shall be approved by Landscape Architect at the nursery or via photographs with scale reference. Trees rejected on site will be replaced at the contractor's expense.
3. Keep rootballs well watered on site, before and after planting. Ensure a watering plan is in place to sustain new tree plantings for a minimum of 60 days.
4. Soil for all on-slab applications to be a lightweight, free draining granular blend to meet Canadian Landscape Standard Part 10. Fines within soil blend to be less than 10%, as defined in a soil analysis provided to the landscape architect for review and comment prior to delivery on site. Soil report shall be no older than one month.

7 Gravel Strip
Scale: 1:25

NOTES:
1. Maximum soil depth 150mm with structural engineer's depth as required to soil depth specified by structural, install polypropylene geogrid to fill additional voids to 150mm. Planting to fill additional voids to 150mm. Verify such as to confirm by Manufacturer. Refer to architectural drawings for structural slab elevation.
2. Refer to plan for gravel wall heights. Refer to architectural drawings for structural slab elevation.
3. 200mm (8") dia. vertical clean-out cap. Slip-fit cap, over plastic drain as per Manufacturer, wrapped in filter cloth. Paint black. Wrap with 150mm non-woven geotextile.
4. 150mm (6") deep composted bark mulch.
5. Growing medium. See planting bed detail for type.
6. 150mm (6") dia. washed round drain rock behind wall.
7. 150mm (6") dia. washed drain rock.
8. 150mm (6") deep (30mm (1 1/4")) dia. washed drain rock.
9. 150mm (6") deep (30mm (1 1/4")) dia. washed drain rock.
10. 150mm (6") deep (30mm (1 1/4")) dia. washed drain rock.
11. 150mm (6") deep (30mm (1 1/4")) dia. washed drain rock.
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17. 150mm (6") deep (30mm (1 1/4")) dia. washed drain rock.
18. 150mm (6") deep (30mm (1 1/4")) dia. washed drain rock.
19. 150mm (6") deep (30mm (1 1/4")) dia. washed drain rock.
20. 150mm (6") deep (30mm (1 1/4")) dia. washed drain rock.

8 Level 3 Allan Block Planter Wall
Scale: 1:25

NOTES:
1. Maximum soil depth 150mm with structural engineer's depth as required to soil depth specified by structural, install polypropylene geogrid to fill additional voids to 150mm. Planting to fill additional voids to 150mm. Verify such as to confirm by Manufacturer. Refer to architectural drawings for structural slab elevation.
2. Refer to plan for gravel wall heights. Refer to architectural drawings for structural slab elevation.
3. 200mm (8") dia. vertical clean-out cap. Slip-fit cap, over plastic drain as per Manufacturer, wrapped in filter cloth. Paint black. Wrap with 150mm non-woven geotextile.
4. 150mm (6") deep composted bark mulch.
5. Growing medium. See planting bed detail for type.
6. 150mm (6") dia. washed round drain rock behind wall.
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20. 150mm (6") deep (30mm (1 1/4")) dia. washed drain rock.

9 Metal Planter on Slab
Scale: 1:25

NOTES:
1. Maximum soil depth 150mm with structural engineer's depth as required to soil depth specified by structural, install polypropylene geogrid to fill additional voids to 150mm. Planting to fill additional voids to 150mm. Verify such as to confirm by Manufacturer. Refer to architectural drawings for structural slab elevation.
2. Refer to plan for gravel wall heights. Refer to architectural drawings for structural slab elevation.
3. 200mm (8") dia. vertical clean-out cap. Slip-fit cap, over plastic drain as per Manufacturer, wrapped in filter cloth. Paint black. Wrap with 150mm non-woven geotextile.
4. 150mm (6") deep composted bark mulch.
5. Growing medium. See planting bed detail for type.
6. 150mm (6") dia. washed round drain rock behind wall.
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Date	Issue Notes
2024-06-17	Re-issue to City
2024-03-21	Re-issue for DP
2024-02-22	Issue to City
2023-06-13	Issue for Rezoning
2023-06-08	Draft Rezoning

Prospect & Refuge
LANDSCAPE ARCHITECTS


1408 10th Ave SW, Suite 1000, Vancouver, BC V6Z 2M1
604-681-0221 | info@prospectandrefuge.ca
Working Hours: 9:00 AM to 5:00 PM Monday to Friday

Project Name and Address:
Bosa Foods
2331-2335 St. Johns Street, Port Moody, BC


Scale: 1:25

Landscape Details


Project No:	2023-10	Date:	as noted
Project Manager:	SHW	Drawn by:	L4a
Reviewed by:	AS		

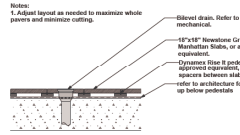


1 Hydrapressed slabs - Level 1 and 3
Scale: 1/25

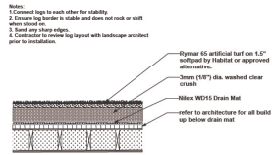

2 Artificial Turf Resilient Surface
Scale: 1/25

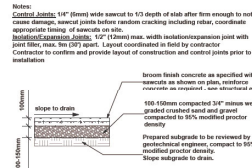

3 PIP concrete walkway on grade
Scale: 1/25

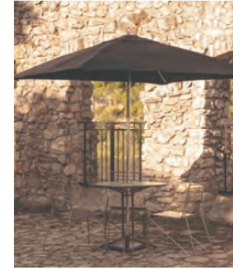

4 Bistro Table and Chairs w/ Umbrella
Scale: NTS

UB 18-2 TECH SHEET
This 18" high x 24" wide barrier is for inner, surround, and root pruning applications. It is suitable for use on sidewalks, paths, and patios, as well as other tree planting situations.

UB 18-2 SPECIFICATIONS + FEATURES

DESIGN: Reduces tree roots down and away from hardscapes.

MATERIALS: High quality 75% recycled recycled injection molded polypropylene. Manufactured in ISO 9001:2015 registered factories.

SIZE & PACKAGING: Each panel is 18" (46 cm) x 24" (61 cm) x 2.0 lbs (0.9 kg) per panel. 25 panels per pallet, approximately 12 lbs (5.4 kg) per carton.

APPLICATIONS:

- LINEAR:** Provide maximum hardscape protection while utilizing all available rooting space for improved tree health by planting guides to arrange tree directly along the hardscape to be protected.
- SCURLED:** Protect hardscapes that surround a planting on all four sides. Plan to line the perimeter of the planting area with the panels which provides the maximum available unobstructed soil volume for immediate root growth.
- ROOT PRUNING:** Root pruning can help save existing trees and prevent future damage to paving. Designers should not disturb or cut and remove lower limbs from trees. There are limitations for root pruning and an ISA Certified Arborist should be consulted.
- HOW TO SPECIFY:**
 1. Determine fence, surround, root pruning or specialty application.
 2. Pick appropriate barrier depth for application and site.
 3. Calculate number of panels required.
 4. For details on these or any other installation instructions, please refer to our Specification and Installation Manual, or visit www.deeproot.com.
- ZIPPER JOINING SYSTEM:** Each panel has built-in zipper panels along the edge, making assembly of the panels in the field quick and easy.
- DOUBLE TOP EDGE:** Reinforced double top edge adds strength, safety and root overgrowth protection.

DeepRoot Green Manufacturing, LLC
10000 Central Expressway, Suite 100, Houston, TX 77040
Tel: 281-462-2222, Fax: 281-462-2222
www.deeproot.com
Printed on 100% FSC Recycled Paper

6 Root Barrier
Scale: NTS

earthscape **JUNIOR CRITTER - SNAIL**
Intended user age: 2-5 **ASTM F1487**

PRODUCT INFORMATION

Children are invited to climb up and over the shell which features gripped cladding. Climbing holds have been designed on the back, shell and side of the structure. Children can crawl through, sit inside the shell or perch up high on its back. While it is designed for younger children, there's little doubt that older children will also be attracted to this familiar critter.

Maximum Height: 6'0"
Fall Height: 6'0"
Area of Safety Surfacing: 380 ft²
User Capacity: 8

THE DISTANT RESPONSIBLE PLAY DESIGNER
The space required to install this play structure is according to ASTM F1487. It is important to include in the fall zone to account for fall distance and potential variations.

REINFORCED SAFETY CANTILEVER IS REQUIRED
Within the fall zone of equipment.


If you have questions about the equipment or facility siting, please contact Earthscape at 1-877-719-2972.

7 Play Structure Concept
Scale: NTS

2024-06-17	Re-issue to City
2024-03-21	Re-issue for DP
2024-02-22	Issue to City
2023-06-13	Issue for Re-zoning
2023-06-08	Draft Re-zoning
Date	Issue/Notes
<p>Prospect & Refuge LANDSCAPE ARCHITECTS 10000 Central Expressway, Suite 100, Houston, TX 77040 Tel: 281-462-2222, Fax: 281-462-2222 www.prospectandrefuge.com</p>	
<p>Project Site and Address: Bosa Foods 2331-2335 St. Johns Street, Port Moody, BC</p>	
<p>Project Title: Landscape Details</p>	
Project No:	2023-10
Date:	as noted
Project Manager:	SHW
Reviewed by:	AS
L4b	

PIAZA STYLE SEATING AREA

Cobblestone paving pattern, bike seating, terracotta planter with Mediterranean style planting and concrete seating benches form a seating area reminiscent of the Italian Plaza.

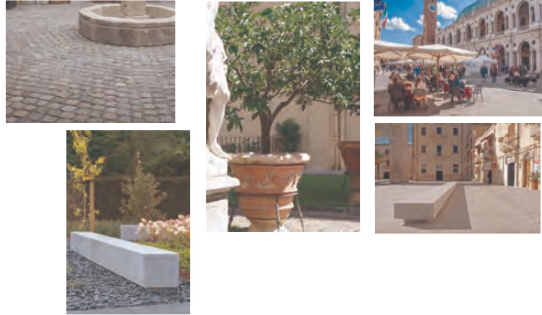


LANDSCAPE NOTES CITY OF PORT MOODY

a. All work and materials shall meet or exceed the requirements outlined in the current Canadian Landscape Standard. If there is a discrepancy between the Canadian Landscape Standard and the City of Port Moody Landscaping on City Landscaping Draft draft specifications or standards, the contractor shall use the more stringent standard.

b. All landscape work and materials shall comply with MLCSS standards and the supplemental City of Port Moody Landscaping on City Landscaping Draft draft specifications or standards. Contractors to be familiar with standards.

c. For questions related to the specifications and standards presented in the City of Port Moody Landscaping on City Landscaping Draft draft specifications or standards, contact the City of Port Moody Planning and Protection 604-469-4074 or urbanform@portmoody.ca. For questions 604-469-4074 or info@portmoody.ca.

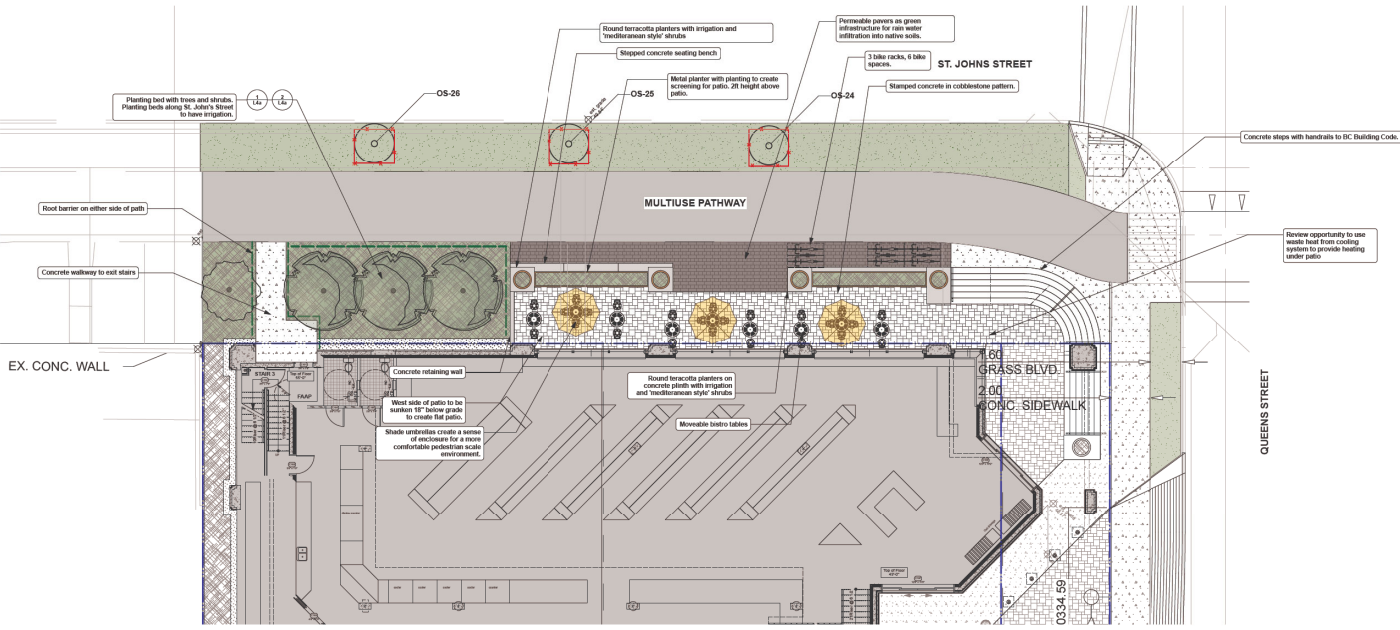

- LEGEND**
- Property Line
 - Tree protection fence

- HARDSCAPE MATERIALS:**
- Stamped CP Concrete in Cobblestone pattern
 - CP Concrete to Public Standards
 - Permeable Concrete Unit Pavers
 - Existing Asphalt Multilane Pathway

- SOFTSCAPE MATERIALS:**
- Planting Bed
 - Sodded Lawn
 - Structural Soil under Concrete Sidewalk

- LINE'S & SYMBOLS**
- Bistro Table
 - Concrete Bench
 - Terracotta Planter
 - Root Barrier

2024-06-17	Re-issue to City
2024-03-21	Re-issue for DP
2024-02-22	Issue to City
2023-06-13	Issue for Rezoning
2023-06-08	Draft Rezoning

Date	Issue/Notes



Project Site and Address:
Bosa Foods
 2331-2335 St. Johns Street, Port Moody, BC

Off-Site Patio Plan	
Project No:	2023-10
Scale:	1:125
Project Manager:	SHW
Author:	AS
L5a	

DETAIL



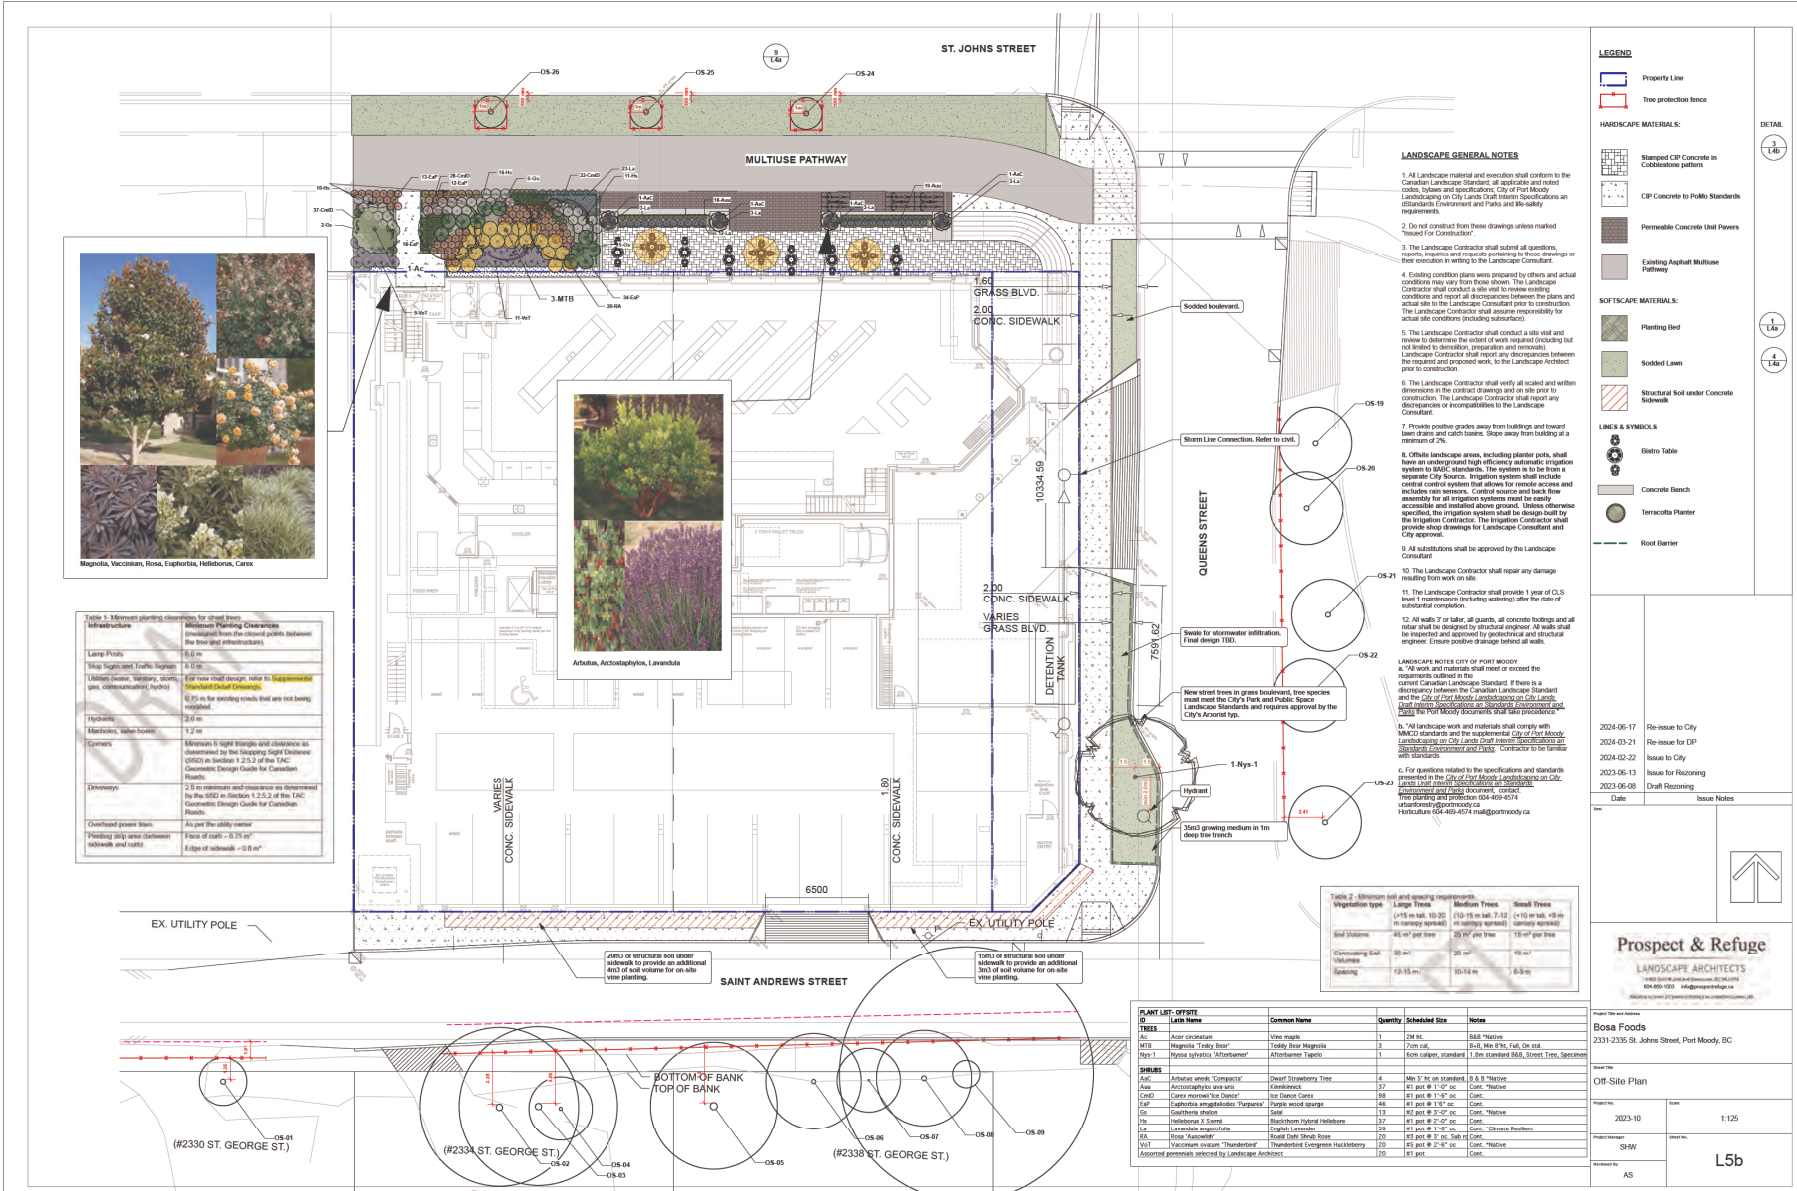


Table 1 - Minimum planting clearances for street trees

Infrastructure	Minimum Planting Clearances provided from the ground points between the tree and infrastructure
Lamp Posts	0.5 m
Sign Support, Traffic Signal	1.0 m
Utility Support, Sign, Street Light, Gas, Communication, Any other	For new road design, refer to Supplemental Standard Detail C-0202 0.75 m for existing roads that are not being replaced
Hydrants	2.0 m
Manholes, Valve Boxes	1.0 m
Corners	Minimum 1.0 m triangles and clearance as determined by the Slipping Right Clearance (SRC) as defined in 2.3.2 of the TAC. Consult the Design Guide for Canadian Roads.
Overhangs	2.0 m minimum and clearance as determined by the SRC as defined in 2.3.2 of the TAC. Consult the Design Guide for Canadian Roads.
Overhead power lines	As per the utility owner
Planting strip area (between sidewalk and road)	Face of curb - 0.75 m ² Edge of sidewalk - 0.9 m ²



Table 2 - Minimum bed and spacing requirements

Vegetation type	Large Trees	Medium Trees	Small Trees
Bed Width	>1.5 m bed, 1.5-2.0 m (in canopy spread)	1.0-1.5 m bed, 1.2-1.5 m (in canopy spread)	<1.0 m bed, <0.8 m (in canopy spread)
Bed Volume	45 m ³ per tree	25 m ³ per tree	15 m ³ per tree
Planting Spacing	3.0 m	2.0 m	1.5 m

PLANT LIST: OFFSITE

Plant	Common Name	Quantity	Scheduled Size	Note
TRBS	Tree	1	2.0 m	8.8" Height
AC	Acorn catkin	1	2.0 m caliper	8.8" Height
MTB	Magnolia 'Teddy Bear'	3	2.0 m cal.	B-B, Min 6.1m, Fall, On site
Myc-1	Mycobolus 'Atromentus'	1	6.0 m caliper, standard	1.8 m standard B&B, Street Tree, Specimen
SHB	Shrub	4	Min 5.0 m on specimen	B & B Height
AW	Arbutus unedo 'Compacta'	37	41 pot @ 11-12" cal.	Cont. 'Native'
CRD	Cornus erecta 'Ice Dance'	18	41 pot @ 11-12" cal.	Cont. 'Native'
LF	Lonicera fragrantissima 'Purple Heart'	45	41 pot @ 11-12" cal.	Cont. 'Native'
GR	Gardenia jasminoides	13	41 pot @ 11-12" cal.	Cont. 'Native'
HS	Hebe x exoniensis 'Surrey'	37	41 pot @ 11-12" cal.	Cont. 'Native'
LA	Lonicera arvensis	12	41 pot @ 11-12" cal.	Cont. 'Native'
SA	Shrub 'Aurea'	20	41 pot @ 11-12" cal.	Cont. 'Native'
TRB	Trifolium repens 'Trifolium'	10	41 pot @ 11-12" cal.	Cont. 'Native'
TRB	Trifolium repens 'Trifolium'	10	41 pot @ 11-12" cal.	Cont. 'Native'
Associated perennials selected by Landscape Architect		20	41 pot	Cont.

LEGEND

- Property Line
- Tree protection fence

HARDSCAPE MATERIALS:

- Stamped CP Concrete in Cobblestone pattern
- CP Concrete to Public Standards
- Permeable Concrete Unit Pavers
- Existing Asphalt Multi-lane Pathway

SOFTSCAPE MATERIALS:

- Planting Bed
- Sodded Lawn
- Structural Soil under Concrete Sidewalk

LINE & SYMBOLS

- Electro Table
- Concrete Beach
- Terracotta Planter
- Root Barrier

DETAIL

1. All Landscape material and execution shall conform to the Canadian Landscape Standards, all applicable and related codes, bylaws and specifications. City of Port Moody Landscaping on City Lands Draft Terms Specifications and Standards for Environment and Parks and Recreability requirements.

2. Do not construct from these drawings unless marked "As Noted" for Contractor.

3. The Landscape Contractor shall submit all questions, requests, inquiries and requests for clarification, change or their execution in writing to the Landscape Consultant.

4. Existing condition plans were prepared by others and actual conditions may vary from those shown. The Landscape Contractor shall conduct a site visit to review existing conditions and report all discrepancies between the plans and actual site to the Landscape Consultant prior to construction. The Landscape Contractor shall assume responsibility for actual site conditions (including infrastructure).

5. The Landscape Contractor shall conduct a site visit and review to determine the extent of work required (including but not limited to demolition, preparation and removal). Landscape Contractor shall report any discrepancies between the required and proposed work, to the Landscape Consultant prior to construction.

6. The Landscape Contractor shall verify all scaled and written dimensions in the contract drawings and site prior to construction. The Landscape Contractor shall report any discrepancies or incompatibilities to the Landscape Consultant.

7. Provide positive grades away from buildings and toward lawn drains and catch basins. Slope away from building at a minimum of 0.5%.

8. Off-site landscape areas, including plantings, shall have an integrated high efficiency irrigation system to BACI standards. The system is to be from a reputable City Supplier. Irrigation system shall include central control system that allows for remote access and accessible rain sensors. Control access and back flow assembly for all irrigation systems must be easily accessible and installed above ground, unless otherwise specified. The irrigation system shall be designed by the Irrigation Contractor. The Irrigation Contractor shall provide shop drawings for Landscape Consultant and City approval.

9. All substitutions shall be approved by the Landscape Consultant.

10. The Landscape Contractor shall repair any damage resulting from work on site.

11. The Landscape Contractor shall provide 1 year of CUS based maintenance (unless otherwise noted) after the date of final completion.

12. All water or other fluids, all concrete hotting and all other shall be designed by structural engineer. All walls shall be inspected and approved by professional and structural engineer. Ensure positive drainage behind all walls.

LANDSCAPE NOTES CITY OF PORT MOODY

a. "All work and materials shall meet or exceed the requirements outlined in the current Canadian Landscape Standards. If there is a discrepancy between the Canadian Landscape Standard and the City of Port Moody Landscaping on City Lands Draft Terms Specifications and Standards for Environment and Parks and Recreability, the City of Port Moody Standards shall prevail.

b. "All landscape work and materials shall comply with the Canadian Landscape Standards and the City of Port Moody Landscaping on City Lands Draft Terms Specifications and Standards for Environment and Parks and Recreability. Contractor to be familiar with standards.

c. For questions related to the specifications and standards presented in the City of Port Moody Landscaping on City Lands Draft Terms Specifications and Standards for Environment and Parks and Recreability, contact the City of Port Moody at 469-4004 or utra@portmoody.ca or utra@portmoody.ca

469-4004

2024-06-17 Re-issue to City

2024-03-21 Re-issue for DP

2024-02-22 Issue to City

2023-06-13 Issue for Receiving

2023-06-08 Draft Review

Date Issue Notes

Prospect & Refuge
LANDSCAPE ARCHITECTS
1000 10th Ave. Suite 1000, Port Moody, BC V3H 2G4
604-469-4004 | info@prospectandrefuge.ca

Project No: 2331-2335 St. Johns Street, Port Moody, BC


Off-Site Plan

2023-10-10 Date: 1:125


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Scale: AS


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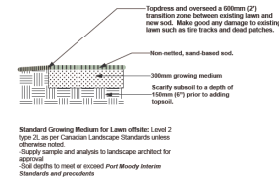
1 Tree Planting Scale: 1:25

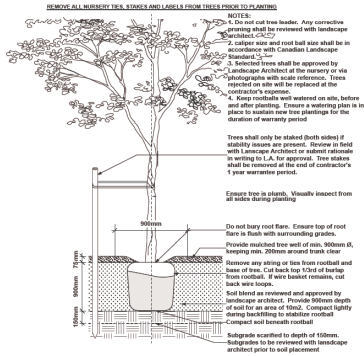

2 Shrub and Perennial Planting Scale: 1:25

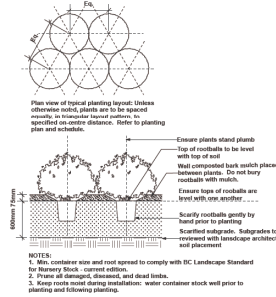

3 Growing Medium - Offsite Scale: 1:25

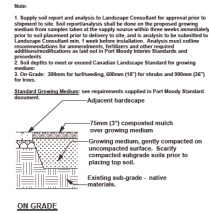

4 Sod - Offsite Scale: 1:25



Circular Terracotta Planter Pot - 0.9m dia. x min. 0.6m ht. Planters to be irrigated. Refer to general notes on sheet 15b.

5 Round Pot Concept Scale: Actual Size

UB 18-2 TECH SHEET

This 18" high by 24" wide barrier is for linear, surround, and root grating applications. It is suitable for use on sidewalks, patios, and patios, as well as other tree planting situations.

UB 18-2	SPECIFICATIONS - FEATURES
<p>USES:</p> <ul style="list-style-type: none"> Prevent tree roots from growing down and away from hardscapes. <p>CONSTRUCTION:</p> <ul style="list-style-type: none"> High-quality 70% recycled recycled injection-molded polypropylene. Manufactured in ISO 9001:2008 registered factories. <p>USES & PACKAGING:</p> <ul style="list-style-type: none"> Each panel is 18" (457 mm) x 24" (610 mm) 25 Panels (52 linear feet) / 1.5 cu per carton / 20 cartons per pallet, approximately 43 lbs. (19.5 kg) per carton 	<p>FEATURES:</p> <ul style="list-style-type: none"> UV-stabilized to resist root growth down and away from hardscapes. Classed assembly panels slide together with a zipper joint system. Patented double top edge for strength, safety, appearance and root overgrowth protection. Added UV inhibitors prevent breakdown from sun exposure. Rounded edges for safety in handling. Made in the USA.
<p>APPLICATIONS:</p> <p>LINEAR:</p> <p>Provide maximum hardscape protection while utilizing all available rooting space for improved tree health by placing panels in a straight line directly along the hardscape to be protected.</p> <p>SURROUND:</p> <p>Protect hardscapes that surround a planting on all four sides. Plan to line the perimeter of the planting area with the panels—the perimeter provides the maximum available unobstructed soil volume for transpiring root growth.</p> <p>ROOT GRATING:</p> <p>Root grating can help ease existing trees and prevent future damage to paving. Disruptive forces are clearly cut and removed. Linear Root Barrier is then installed. There are limitations to root grating and an ISA Certified Arborist should be consulted.</p> <p>HOW TO SPECIFY:</p> <ol style="list-style-type: none"> 1. Determine linear, surround, root grating or specialty application. 2. List appropriate barrier depth for application and site. 3. Specify number of panels required. 4. For details on these or any other installation instructions, please refer to our specifications and installation manual, or visit www.ubproducts.com. 	<p>UPPER JOINTING SYSTEM:</p> <p>Install upper jointing system along the edge, making sure the panels fit together tightly.</p> <p>DOUBLE TOP EDGE:</p> <p>Patented double top edge adds strength, safety and root overgrowth protection.</p>

6 Root Barrier Scale: Actual Size

2024-06-17	Re-issue to City
2024-03-21	Re-issue for DP
2024-02-22	Issue to City
2023-06-13	Issue for Re-zoning
2023-06-08	Draft Re-zoning
Date	Issue Notes
<p>PROSPECT & REFUGE LANDSCAPE ARCHITECTS 1038 201 St. John St. Suite 200, Port Moody, BC V3H 2L9 604-490-1022 info@prospectandrefuge.ca</p>	
<p>Project Name and Address</p> <p>Bosa Foods 2331-2335 St. Johns Street, Port Moody, BC</p>	
<p>Scale: 1:25</p> <p>Off-Site Details</p>	
Project No.	125
Project Name	SHW
Revision No.	AS
<p>L5c</p>	

Considered at the July 23, 2024, Regular Council meeting

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Attachment 10

Project Fact Sheet

Applicant: Cornerstone Architecture

Application Type: OCP Amendment, Rezoning and Development Permits

Project Description: A seven-storey mixed use commercial/residential building and a rooftop garden with enclosed and open spaces, with o 885 m² (9,525 ft²) of commercial space over first two floors and 3,472 m² (37,379 ft²) of residential space over four upper floors with 48 market rental apartments, and FSR of 2.63

Development Permit Area: Development Permit Area 2 (DPA2) – Moody Centre Heritage Conservation Area (HCA)
Development Permit Area 5: Hazardous Conditions

Application Number: ORD00006

Address: 2331- 2335 St. Johns Street

Existing Zoning: General Commercial (C3)- Eastern lot (lot 2335)
Medium Density Townhouse Residential (RM4)- Western lot (lot 2331)

Proposed Zoning: Comprehensive Development (CD) zone (CD97)

Existing OCP Designation: Mixed Use – Moody Centre (4 storeys) – Eastern lot
Multi-Family Residential (3 storeys) – Western lot

Surrounding Development:

	Zoning Designation	OCP Designation
North	- General Commercial (C3) - Comprehensive Development Zone 14 (CD14)	- Mixed Use – Moody Centre - Multi-Family Residential
East	- Service Station Commercial (C4) - Currently Shell Gas Station	- Mixed Use – Moody Centre
South	- Single-Detached Residential (RS1)	- Single-Family Low Density
West	- Medium Density Townhouse Residential (RM4)- (Currently a protected heritage property)	- Multi-Family Residential

Considered at the July 23, 2024, Regular Council meeting

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Attachment 10

Development Statistics:

Proposed Development

Number of Residential Units:	48 market rental apartments with 8 studios, 21 one-bedroom units- 12 two- bedroom and 7 three-bedroom units
Density:	FSR 2.63
Height:	Seven-storeys and a rooftop garden that has enclosed and open spaces- Considered 8-storeys based on BCBD- 27.7 m (90'-11")
Parking	(Total 81)
Resident:	53
Visitor:	5
Commercial Loading:	23
Bicycle Parking:	73 long term and 6 short term stalls for residential 1 long term and 6 short term for commercial portion

Sustainability Report Card

Mixed Use Projects

Purpose

The Sustainability Report Card recognizes that developers, builders, designers, and others proposing changes to the built environment have an important role in creating a sustainable community. Buildings are a vital part of our community, providing shelter, employment, recreation opportunities, services, shopping and more. With the amount of time we spend in our buildings they play an essential role in how prepared we are for our changing climate, influence the vitality of our community, and shape our everyday lives.

The buildings we build today will be around for the next 60–80 years on average and it is crucial for the evolution of our community that these structures are built to the highest sustainability standards. In 2020 Council adopted the City’s Climate Action Plan, a comprehensive strategy laying out a pathway to become a carbon neutral, resilient community by 2050. This Plan includes various building-related actions that project proposals should incorporate to work towards the vision that:

“Port Moody is a resilient community that honours climate justice, leading the urgent response to climate change through collective action.”

– Climate Action Committee, 2019

Port Moody encourages innovative thinking in community design to achieve sustainable communities. To this end, the Report Card is a requirement for rezoning, development permit, heritage revitalization agreement, and heritage alteration permit applications. The Report Card identifies performance measures based on community sustainability values, and these measures are used to evaluate development proposals. The Report Card is a tool that summarizes overall project sustainability and is integrated with all other development approval requirements.

The Report Card focuses on performance criteria within four pillars of sustainability defined by the City as:

1. Cultural Sustainability

Cultural sustainability recognizes the need to honour and transmit cultural beliefs, practices, heritage conservation, and culture for future generations. Cultural sustainability is about fostering cultural rights, local culture and cultural identity in a community. Cultural sustainability can be achieved through innovation and preservation of identity through different forms of creative expressions (e.g., art, events), celebrating cultural customs, and preserving and transmitting cultural heritage and customs through design of culturally inclusive landscapes, architecture, programs, and amenities.

2. Economic Sustainability

Economic sustainability in the Port Moody context means offering a broad range of local employment opportunities that will reduce commute distances and times, encouraging creative and clean industry and jobs, and building a more sustainable financial future for the City. The impacts of this approach will reduce GHG emissions, enable active transportation as a more viable means of getting around, build more resilient local business communities, and strengthen the social fabric of the city.

3. Environmental Sustainability

Environmental sustainability refers to the protection, management, and monitoring of ecosystems and natural assets to ensure the long-term productivity and health of resources to meet future economic and social needs. Environmental sustainability involves protecting, restoring, and connecting environmental systems to maintain function and ecological integrity. It also acknowledges that human civilisation takes resources to sustain our modern way of life, recognizes the elements that place stress on the environment and incorporates how technology will drive our greener future.

4. Social Sustainability

Social sustainability is about inclusive and resilient societies that understand what citizens need from the places where they live, work and play and where citizens feel supported in their well-being and are encouraged to evolve. Social sustainability combines physical design with support mechanisms to enhance social liveability, amenities, and systems that actively support the capacity of current and future generations to create healthy and livable communities. Socially sustainable communities promote diversity, equity and inclusion, foster connectivity and provide a high quality of life.

Process

The Sustainability Report Card forms part of the application materials for rezoning, development permit, heritage revitalization agreement, and heritage alteration permit proposals. There are five steps to follow in completing the Sustainability Report Card process:

1. Consult with City planning staff to discuss your proposal and determine if a Sustainability Report Card must be submitted with your development application.
2. Following the initial conversation with staff, and while preparing your application, complete the Sustainability Report Card by filling in the appropriate information that applies to your application and submit a completed copy to your file manager.
3. The Sustainability Report Card will be marked three times:
 - a. Prior to first reading;
 - b. Prior to Advisory Design Panel and Land Use Committee; and
 - c. Final scoring prior to Development Permit issuance.

At each of these marking intervals Planning staff will review the Report Card for completeness and accuracy and forward to staff in various departments for marking. Staff will make comments, determine a score, and provide the applicant an opportunity to revise the Report Card. The score and comments will be included in the land use reports that are distributed to the Advisory Design Panel, Land Use Committee, and City Council.

4. Commitments indicated in the Report Card will be secured through various means including, but not limited to, Development Permit conditions, securities, and various agreements (e.g., Servicing Agreement) or covenants. The method of securing the commitment is noted for each criteria.
5. If your application is approved by Council, your final Sustainability Report Card is maintained in the development file and a copy is provided to the City's Building Division.

Considered at the July 23, 2024, Regular Council meeting

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Attachment 11

Instructions

- Your Report Card must contain sufficient detail to ensure each measure can be evaluated. Make reference to the appropriate plans, drawings, and reports that demonstrate how the performance measure is met where appropriate.
- The relevance of the questions will depend on the nature and scope of your project, so not all questions will be applicable to all projects. In this case, select N/A and the points will be subtracted from the overall points available to increase fairness. Some criteria do not include N/A as an option as this is expected/possible on each project.
- Key terms are defined in the [Glossary](#) at the end of the Report Card document.
- Refer to the Resources section in each criteria for links to web-based resources relevant to measures in the Sustainability Report Card.

Scoring

- Scoring of the Report Card reflects a project's overall ability to be a sustainable development. Criteria are assigned points to indicate their significance based on:
 1. the level of difficulty to integrate criteria into project design;
 2. the order-of-magnitude cost added to the project;
 3. alignment with identified City and community priorities;
 4. the level of urgency for Port Moody in terms of achieving community sustainability goals; and
 5. the degree of effectiveness for increasing overall project sustainability.
- Performance measures are ordered based on priority. The first performance measure under each topic area in each pillar is the highest priority. The highest priority performance measures typically offer the highest possible points.
- City staff score the completed Report Card based on the principle of best achievable on each site for each performance measure. Points for achieving various means are indicated. Where open ended responses are permitted, staff will make a fair assessment of the project's performance for the measure with respect to site conditions.
- Where criteria may not be applicable to your project due to constraints, select the N/A option and the points will be subtracted from the overall points available to increase fairness. Some criteria do not include N/A as an option as this is expected/possible on each project.
- The Report Card is an iterative process with the applicant. The applicant has an opportunity to comment and make changes to their proposal before the scores are considered final and shared with public advisory bodies and City Council.
- Additional space is provided for the applicant to address innovations and constraints not captured elsewhere in the Report Card. Innovation items have a maximum score of 3 points. Constraints are not scored but given specific mention in Council Reports. Applicants are required to provide a narrative of how the project is contributing to each pillar of sustainability.
- Staff will review your completed Report Card and provide feedback to give you the opportunity to achieve the highest score possible by the time the project is considered for adoption or permit approval.

Monitoring

In general, the information required from the applicant for the Sustainability Report Card is similar to the information required for a typical development application. However, to ensure accountability, the City may request additional information, such as: photos of installed systems or products, design drawings, professional reports, copies of receipts, or other records that can be used to verify the implementation of the selected sustainability criteria. We encourage you to provide as much information as possible to assist City staff in their review of your development proposal.

Public Information

Copies of the Report Card are maintained by the Development Planning Division and are included as an attachment to Council reports related to the application. Therefore, Report Cards are part of the public record.

Property and Applicant Information

Applicant: Scott Kennedy
Telephone: 604-253-8800 **Email:** skennedy@cornerarch.com
Registered owner: Benedet Properties (St Johns) LTS. [Inc#: BC1355917]
Project address: 2331, 2335 St. Johns Street
Proposed use: Mixed-Use Moody Centre **Total floor space (m²):** 4789.17
Building type: Wood frame and Concrete **Number of storeys:** 6
Number of units: 48

Final Score (staff to complete)

Pillar	Total possible points	Sum of N/A points	Sum of missed points	Applicant total points	Pillar % score
Cultural Sustainability	56	9	18	19	40
Economic Sustainability	93	15	40	38	48
Environmental Sustainability	172	20	77	75	49
Social Sustainability	165	3	98	64	39

1. Cultural Sustainability

Arts	
<p>C1a (applicants can choose between C1a or C1b) (12 points possible)</p> <p>Does the project designate space for artists or creative enterprises to be retained for the lifetime of the project?</p> <p><input type="checkbox"/> Yes</p> <p><input checked="" type="checkbox"/> No</p> <p><input type="checkbox"/> N/A (applicants can choose between C1a or C1b)</p> <p>If yes:</p> <p>Check all that apply: (up to 12 points)</p> <p><input type="checkbox"/> artist studios (2 points for first studio + 1 point for each additional studio, max 8 points)</p> <p><input type="checkbox"/> family-size live-work units – sold below market value (3 points per unit, max 8 points)</p> <p><input type="checkbox"/> family-size live-work units – sold at market value (2 points per unit, max 6 points)</p> <p><input type="checkbox"/> plaza, creative placemaking space, available for public use (e.g., outdoor stage) (4 points)</p> <p><input type="checkbox"/> temporary artist spaces on or off the site (2 points)</p> <p><input type="checkbox"/> publicly viewable exhibition space (2 points)</p> <p><input type="checkbox"/> developer identified need/opportunity (up to 4 points)</p> <p>Please specify: _____</p> <p>Provide the size and details of the proposed space(s):</p> <div style="border: 1px solid black; height: 100px; width: 100%;"></div> <p>For the spaces being provided in this project, how will operation be managed? (e.g., who is responsible for managing tenants, maintenance, etc)?</p> <div style="border: 1px solid black; height: 100px; width: 100%;"></div>	<p>Resources</p> <p>Developer Public Art Guidelines</p> <p>Art in Public Spaces Master Plan</p> <p>Arts and Culture Master Plan</p> <hr/> <p>Enforcement</p> <ul style="list-style-type: none"> - Units (market and below market) will be secured through a Housing Agreement. - Plaza/creative/exhibition space & temporary artist space will be confirmed through the Development Permit. - Elements on Landscape Plans will be subject to securities. - Formal written confirmation of arrangements for managing spaces will be required. <hr/> <p>Staff comments</p> <div style="border: 1px solid black; height: 200px; width: 100%;"></div> <p style="text-align: right;">Score <input type="text" value="0"/> /12</p>

<p>C1b <i>(applicants can choose between C1a or C1b)</i> (6 points possible)</p> <p>Does the project include artwork which is aligned with the Art in Public Spaces Master Plan and located in a publicly accessible or publicly owned space? <i>(Note: Public Art Policy encourages at least 0.5% of construction costs)</i> (4 points)</p> <p><input checked="" type="checkbox"/> Yes</p> <p><input type="checkbox"/> No</p> <p><input type="checkbox"/> <i>N/A (applicants can choose between C1a or C1b)</i></p> <p>Applicants are encouraged to work with artists and/or art consultants early so that artworks can be incorporated in meaningful and creative ways. Has an artist or art consultant been engaged for this project? (2 points)</p> <p><input checked="" type="checkbox"/> Yes</p> <p><input type="checkbox"/> No</p>	<p>Resources</p> <p>Developer Public Art Guidelines</p> <p>Art in Public Spaces Master Plan</p> <p>Arts and Culture Master Plan</p>
<p>OR</p>	<p>Enforcement</p> <ul style="list-style-type: none"> - Formal written commitment to engage in a process to include public art will be required. Confirmation of the value of this commitment and securing this commitment through a letter of credit submitted prior to issuance of Development Permit will be required. - Collection of public art funds prior to issuance of development permit will be required.
<p>Does the project provide an in lieu financial contribution to the City's Artwork Reserve Fund in accordance with the City's Public Art Policy? (4 points)</p> <p><input type="checkbox"/> Yes</p> <p><input checked="" type="checkbox"/> No</p> <p><input type="checkbox"/> <i>N/A (applicants can choose between C1a or C1b)</i></p> <p>What is the proposed contribution to the City's Artwork Reserve Fund? (2 points) <i>(Note: Public Art Policy encourages at least 0.5% of construction costs)</i> <i>(2 points if contribution is at least 10% greater than recommendation)</i></p> <p>\$ amount: _____ % of construction budget: _____</p>	<p>Staff comments</p> <p>applicant states in following question that Doug Taylor (an artist) is working with them, but applicant has selected "No"</p> <p>Applicant changed answer to "yes" earning additional 2 score.</p> <p style="text-align: right;">Score <input type="text" value="6"/> /6</p>

<p>C2 (2 points possible)</p> <p>Does the project include artistically designed (professionally designed) architectural elements that enhance the overall visual appeal of the development (e.g., water feature)?</p> <p><input checked="" type="checkbox"/> Yes</p> <p><input type="checkbox"/> No</p> <p>If yes, describe how:</p> <div style="border: 1px solid black; padding: 5px; min-height: 100px;"> <p>We are working with an artist (Doug Taylor) to develop a concept design for the project. www.dougtaylor.co</p> </div>	<p>Enforcement</p> <ul style="list-style-type: none"> - Architectural elements will be secured through the Development Permit. - Elements on Landscape Plans will be subject to securities. <p>Staff comments</p> <div style="border: 1px solid black; height: 100px; width: 100%;"></div> <p style="text-align: right;">Score <input type="text" value="2"/> /2</p>
<p>C3 (2 points possible)</p> <p>Does the project include artistically designed (professionally designed) street furniture and/or streetscape enhancements (e.g., artistically designed benches, streetlights, tree grates)? <i>(Note: consider maintenance and replacement of furniture/enhancements)</i></p> <p><input checked="" type="checkbox"/> Yes</p> <p><input type="checkbox"/> No</p> <p><input type="checkbox"/> N/A</p> <p>If yes, describe the furniture/enhancements and how they will be maintained:</p> <div style="border: 1px solid black; padding: 5px; min-height: 100px;"> <p>Planters are designed to complement the architectural style of the surrounding buildings. The benches are incorporated into the planters to create a cohesive and visually interesting design. We are working with an artist to develop a concept design for the project.</p> </div>	<p>Enforcement</p> <ul style="list-style-type: none"> - Elements on Landscape Plans will be subject to securities. - Elements included in Civil Plans will be secured through the Servicing Agreement. <p>Staff comments</p> <div style="border: 1px solid black; height: 100px; width: 100%;"></div> <p style="text-align: right;">Score <input type="text" value="2"/> /2</p>

<p>C4 (2 points possible)</p> <p>Describe how your project aligns with the Art in Public Spaces and/or Arts and Culture Master Plans, or otherwise contributes to the overall cultural and artistic vitality of Port Moody:</p> <div style="border: 1px solid black; padding: 5px; margin-top: 10px;"> <p>The Bosa Foods project aligns with this program by providing a space for cultural activities that will be open to the public. The project's focus on Italian culture and cuisine will add to the city's cultural diversity and provide an opportunity for residents to learn about and experience different cultures. The demo kitchen will allow residents to learn new culinary skills and explore the flavours of Italy. By doing so, the project will be contributing to the overall cultural and culinary landscape of Port Moody. Bosa Foods will also work with an artist to provide a kinetic sculpture.</p> </div>	<div style="background-color: #cccccc; padding: 2px;">Resources</div> <p>Art in Public Spaces Master Plan Arts and Culture Master Plan</p> <div style="background-color: #cccccc; padding: 2px;">Enforcement</div> <p>- N/A</p> <div style="background-color: #cccccc; padding: 2px;">Staff comments</div> <div style="border: 1px solid #ccc; padding: 5px; margin-top: 5px;"> <p>previous report card included "The perforated panels on site can allow for artistic inputs and designs. " are these being removed?</p> </div> <p style="text-align: right;">Score <input type="text" value="2"/> /2</p>
<p>C5 (1 point possible)</p> <p>Does the project include artistic elements for the benefit of the residents/ occupants (e.g., artistic features in a private courtyard or main entryway)?</p> <p><input type="checkbox"/> Yes <input checked="" type="checkbox"/> No</p> <p>If yes, please describe:</p> <div style="border: 1px solid #ccc; height: 100px; margin-top: 10px;"></div>	<div style="background-color: #cccccc; padding: 2px;">Enforcement</div> <ul style="list-style-type: none"> - Architectural elements will be secured through the Development Permit. - Elements on Landscape Plans will be subject to securities. <div style="background-color: #cccccc; padding: 2px;">Staff comments</div> <div style="border: 1px solid #ccc; height: 100px; margin-top: 5px;"></div> <p style="text-align: right;">Score <input type="text" value="0"/> /1</p>

Heritage	
<p>C6 (3 points possible)</p> <p>Have you consulted with City staff to determine if any of the structures on the subject property may have heritage value?</p> <p> <input type="checkbox"/> Yes <input type="checkbox"/> No <input checked="" type="checkbox"/> N/A </p> <p>If yes, does the project include a statement of significance for heritage structures not listed on Heritage Register, prepared by a heritage conservation specialist where potential heritage value is observed?</p> <p> <input type="checkbox"/> Yes <input type="checkbox"/> No <input checked="" type="checkbox"/> N/A </p>	<p>Resources</p> <p>Heritage Register</p> <p>Enforcement</p> <p>- Submission of Statement of Significance with application will be required.</p> <p>Staff comments</p> <div style="border: 1px solid #ccc; padding: 5px; min-height: 100px;"> Applicant has selected N/A </div> <p style="text-align: right;">Score <input type="text" value="0"/> /3</p>
<p>C7 (3 points possible)</p> <p>Does the project include a heritage conservation plan prepared by a heritage conservation professional for a structure on the property of the application or on another property in the City?</p> <p> <input type="checkbox"/> Yes <input type="checkbox"/> No <input checked="" type="checkbox"/> N/A </p> <p>If yes, provide the address of the structure included in the heritage conservation plan:</p> <p>Address: _____</p>	<p>Enforcement</p> <p>- Submission of a conservation plan will be required with application.</p> <p>Staff comments</p> <div style="border: 1px solid #ccc; padding: 5px; min-height: 100px;"> Applicant has selected N/A </div> <p style="text-align: right;">Score <input type="text" value="0"/> /3</p>

<p>C8 (3 points possible)</p> <p>Does the project include reusing an existing heritage structure with heritage value through heritage restoration or heritage rehabilitation? <i>(3 points)</i></p> <p><input type="checkbox"/> Yes</p> <p><input checked="" type="checkbox"/> No</p> <p><input type="checkbox"/> N/A</p>	<p>Enforcement</p> <p>– Details will be included in Heritage Conservation Plan and formalized in a Heritage Revitalization Agreement or Development Permit. Formal protection typically involves heritage designation following completion of conservation work.</p> <p>Staff comments</p> <div style="border: 1px solid gray; height: 100px; width: 100%;"></div> <p style="text-align: right;">Score <input type="text" value="0"/> /3</p>
<p>C9 (2 points possible)</p> <p>Where the preservation of a heritage structure in its original location cannot be accommodated, relocation may be considered.</p> <p>Does this project include heritage relocation within Port Moody? <i>(2 points)</i></p> <p><input type="checkbox"/> Yes</p> <p><input checked="" type="checkbox"/> No</p> <p><input type="checkbox"/> N/A</p>	<p>Resources</p> <p><i>Conservation of Historic Places in Canada:</i> historicplaces.ca</p> <p>Enforcement</p> <p>– Written confirmation of commitment to relocate structure and details of plans for the building in its new location will be required.</p> <p>Staff comments</p> <div style="border: 1px solid gray; height: 100px; width: 100%;"></div> <p style="text-align: right;">Score <input type="text" value="0"/> /2</p>

<p>C10 (2 points possible)</p> <p>Does the project salvage materials or artefacts from a historic place in Port Moody, or reuse materials or artifacts from architectural/landscape salvage in a manner which supports the authenticity of the site's character-defining elements?</p> <p><input type="checkbox"/> Yes</p> <p><input checked="" type="checkbox"/> No</p> <p><input type="checkbox"/> N/A</p> <p>If yes, please explain: (up to 2 points)</p> <div style="border: 1px solid black; height: 150px; width: 100%;"></div>	<p>Enforcement</p> <ul style="list-style-type: none"> - Depending on what is proposed, incorporating these elements could be shown on landscape and/or architectural plans included in the Development Permit. - Landscaped elements will be subject to securities. If the artifacts are used in public art then they will be secured through Public Art Securities. <p>Staff comments</p> <div style="border: 1px solid black; height: 80px; width: 100%;"></div> <p style="text-align: right;">Score <input type="text" value="0"/> /2</p>
<p>C11 (2 points possible)</p> <p>Does the project involve the addition of a heritage structure to the City's Heritage Register? This only applies to a structure with heritage value that is NOT already on the City's Heritage Register.</p> <p><input type="checkbox"/> Yes</p> <p><input checked="" type="checkbox"/> No</p> <p><input type="checkbox"/> N/A</p>	<p>Resources</p> <p>Heritage Register</p> <p>Enforcement</p> <ul style="list-style-type: none"> - Confirmation of intention to add the heritage structure to the Heritage Register will be required. <p>Staff comments</p> <div style="border: 1px solid black; height: 80px; width: 100%;"></div> <p style="text-align: right;">Score <input type="text" value="0"/> /2</p>

<p>C12 (2 points possible)</p> <p>Does the project incorporate acknowledgement of historical or cultural connections to the site (e.g., historical naming of the site, people, events, structures, architectural inspiration etc.)?</p> <p><input type="checkbox"/> Yes</p> <p><input checked="" type="checkbox"/> No</p> <p>If yes, please explain: (up to 2 points)</p> <div style="border: 1px solid black; height: 80px; width: 100%;"></div>	<p>Enforcement</p> <ul style="list-style-type: none"> - Follow up will depend on the method used to acknowledge cultural connections to the site. Determined by staff. <p>Staff comments</p> <div style="border: 1px solid black; height: 100px; width: 100%;"></div> <p style="text-align: right;">Score <input type="text" value="0"/> /2</p>
Public Realm	
<p>C13 (8 points possible)</p> <p>Does the project improve the streetscape beyond minimum City requirements by integrating lasting creative elements and demonstrating effort to optimize the project’s beautification impact?</p> <p><input checked="" type="checkbox"/> Yes</p> <p><input type="checkbox"/> No</p> <p>If yes, check all that apply: (up to 4 points)</p> <ul style="list-style-type: none"> <input type="checkbox"/> Artistic stormwater management features (1 point) <input type="checkbox"/> Restores the frontage of an existing building in Historic Moody Centre (2 points) <input checked="" type="checkbox"/> Proposed artistic paving treatments (1 point) <input checked="" type="checkbox"/> Adds aesthetics to functional elements of the streetscape (1 point) <input checked="" type="checkbox"/> Aesthetically pleasing and functional benches, bike rack, planter, lighting etc. upgrades (1 point) <input checked="" type="checkbox"/> Interaction of the project with the public e.g., edible landscape/foilage (1 point) <input checked="" type="checkbox"/> Artistic panels in entry foyer (1 point) <input checked="" type="checkbox"/> Other (up to 1 point) <p>Are the streetscape elements designed by a local artist? (4 points)</p> <p><input type="checkbox"/> Yes</p> <p><input checked="" type="checkbox"/> No</p>	<p>Enforcement</p> <ul style="list-style-type: none"> - Architectural elements will be secured through the Development Permit. - Elements on Landscape Plans will be subject to securities. - Elements included in Civil Plans will be secured through the Servicing Agreement. - Artistic elements will be secured through Public Art securities. <p>Staff comments</p> <div style="border: 1px solid black; padding: 5px;"> <p>artistic side panels are not included compared to last time. Is applicant walking back on this?</p> </div> <p style="text-align: right;">Score <input type="text" value="5"/> /8</p>

<p>C14 (3 points possible)</p> <p>Does your project include any innovative cultural sustainability aspects not captured in the Report Card?</p> <p><input type="checkbox"/> Yes</p> <p><input checked="" type="checkbox"/> N/A</p> <p>If yes, please explain: (up to 3 points)</p> <div style="border: 1px solid gray; height: 100px; width: 100%;"></div>	<p>Enforcement</p> <p>- Will depend on the type of innovation, determined by staff.</p> <hr/> <p>Staff comments</p> <div style="border: 1px solid gray; padding: 5px;">Applicant has selected N/A</div> <p style="text-align: right;">Score <input type="text" value="0"/> /3</p>
<p>C15</p> <p>Does your project face any unique site constraints that limit cultural sustainability achievement?</p> <p><input type="checkbox"/> Yes</p> <p><input checked="" type="checkbox"/> No</p> <p>If yes, please explain:</p> <div style="border: 1px solid gray; height: 100px; width: 100%;"></div>	<p>Enforcement</p> <p>- N/A</p> <hr/> <p>Staff comments</p> <div style="border: 1px solid gray; height: 100px; width: 100%;"></div>

Considered at the July 23, 2024, Regular Council meeting

800

Attachment 11

C16

(3 points possible)

Summarize the project's cultural sustainability contributions, including the performance criteria in this Report Card and additional elements not previously captured here.

The Bosa Foods project contributes to the cultural sustainability of Port Moody by providing a space for Italian cultural activities that will promote cultural diversity and add to the city's cultural and culinary landscape. The project's demo kitchen will allow residents to learn new culinary skills and explore the flavours of Italy, while the artistic elements in the children's play area and streetscape enhancements will create a visually interesting and dynamic environment. Additionally, the planters, screens, and benches are designed to complement the architectural style and define different spaces within the streetscape while providing privacy and adding a decorative element. We are currently working with an artist to develop a concept art piece design for the project. Overall, the project aligns with the city's Arts and Culture Master Plan and contributes to the overall cultural and artistic vitality of Port Moody.

Enforcement

- Highlighted in Council reports

Staff comments

Score /3

Total Cultural Sustainability Pillar Points = /56

2. Economic Sustainability

Complete Community	
<p>EC1 (13 points possible)</p> <p>Does the project support active transportation to access shops and services by improving the circulation and connectivity of the site to retail shops, services, and employment near the project site?</p> <p><input checked="" type="checkbox"/> Yes</p> <p><input type="checkbox"/> No</p> <p>If yes, check all that apply for how this is achieved: (up to 13 points)</p> <ul style="list-style-type: none"> <input checked="" type="checkbox"/> Creates connectivity to existing active transportation network <i>(up to 3 points)</i> <input checked="" type="checkbox"/> Eliminates barriers to access for active transportation (e.g., improving let-downs, accessibility) <i>(up to 3 points)</i> <input checked="" type="checkbox"/> Enhances trails and bike paths <i>(1 point)</i> <input checked="" type="checkbox"/> Creates public amenity space <i>(1 point)</i> <input checked="" type="checkbox"/> Use of greenery and landscaping to serve pedestrians and to direct patrons to storefront entrances and transit <i>(1 point)</i> <input checked="" type="checkbox"/> Wide sidewalks and separation from the road to encourage and promote pedestrian movement <i>(1 point)</i> <input type="checkbox"/> Blade or tab signs are incorporated as appropriate <i>(up to 2 points)</i> <input checked="" type="checkbox"/> Seating, public art, and other amenities are incorporated into design of retail storefront area <i>(up to 3 points)</i> <input checked="" type="checkbox"/> Receiving/shipping areas are located off pedestrian routes <i>(1 point)</i> <input type="checkbox"/> Other – please explain: <i>(up to 3 points)</i> <div style="border: 1px solid black; height: 40px; width: 100%; margin-top: 5px;"></div>	<p>Resources</p> <p>Master Transportation Plan Examples</p> <p>Enforcement</p> <ul style="list-style-type: none"> - Architectural elements are secured through the Development Permit. - Elements on Landscape Plans will be subject to securities. - Elements included in Civil Plans will be secured through the Servicing Agreement. - Signage will be confirmed through the Signage Plan. <p>Staff comments</p> <div style="border: 1px solid black; padding: 5px; margin-top: 5px;"> <p>Applicant should clarify how development "Enhances trails and bike paths" scoring conditional</p> <p>The patio and seating along the multi-use path allows for public use and creates a safe rest area</p> </div>
Score 11 /13	

Considered at the July 23, 2024, Regular Council meeting

802

Attachment 11

EC2

(12 points possible)

Does the project increase access to daily services or supplement the existing business composition?

Yes

No

If yes:

Check all that apply:

(up to 12 points)

Contiguous retail frontage to maintain continuity of retail storefronts *(2 points)*

Enhances existing businesses through agglomeration as appropriate *(2 points)*

Provides a variety of store widths or opportunity for a variety of storefront widths through combining individual units *(2 points)*

Provides daily goods and services that are missing or underserved in the current local area business composition *(2 points)*

Please explain missing/underserved goods and services identified:

[Empty text box for explaining missing/underserved goods and services identified]

Supports expansion of and/or leverages the existing business community in the area *(2 points)*

Please explain how:

[Empty text box for explaining how expansion/leverage is achieved]

Other – please explain: *(up to 2 points)*

[Empty text box for other explanation]

What is the Walk Score of the proposed project?

[Empty text box for Walk Score]

Resources

[WalkScore](#)

Enforcement

– Architectural elements will be secured through the Development Permit.

– Specific uses will be incorporated into the project zoning.

Staff comments

4 of 6 due to applicant selection.

Applicant removed "Provides a variety of store widths or opportunity for a variety of storefront widths through combining individual units" applicant is proposing grocery store but nothing more. Please clarify

Score **4** /12

EC3

(5 points possible)

What is the estimated increase to the current and proposed property assessed value, as would be determined by BC Assessment (market value) for each property classification?

(Note that only estimates are required for proposed assessed value as actual assessed values would not be available at this point in the project)

Current (Land & Improvement)

Class 1 – residential assessed value: \$2,440,000 + \$2,225,000

Class 2 – utilities assessed value: _____

Class 3 – supportive housing assessed value: _____

Class 4 – major industry assessed value: _____

Class 5 – light industry assessed value: _____

Class 6 – business other assessed value: \$750,000

Estimated Proposed (Land & Improvement)

Class 1 – residential assessed value: \$5,000,000

Class 2 – utilities assessed value: _____

Class 3 – supportive housing assessed value: _____

Class 4 – major industry assessed value: _____

Class 5 – light industry assessed value: _____

Class 6 – business other assessed value: \$1,500,000

Project provides more assessed value in a non-residential class (2,4,5,6) = 3 points

Proposed assessed value is higher than current assessed value = 2 points

Proposed assessed value is the same as current assessed value = 1 point

Proposed assessed value is lower than current assessed value = 0 points

Resources

[Official Community Plan land use plan map](#)

[BC Assessment Property Classification](#)

Enforcement

- N/A

Staff comments

Score /5

Local Economy

EC4

(20 points possible)

Does the project increase the number of and variety of skilled employment on land designated as Industrial, Mixed Employment, or Mixed Use in the City's Official Community Plan?

Yes

No

If yes:

List the estimated number of jobs: (up to 5 points)

of existing jobs on site: 2

of proposed jobs on site: 16

% of jobs retained: 100

If # of existing jobs is not retained = 0 points
If # of existing jobs is retained = 3 points
If # of jobs is increased beyond existing = 5 points

Using the North American Industry Classification System (NAICS), list the type of jobs created. Classification to the Sector (first) level is sufficient.

445298

List the jobs to population ratio on site: (up to 15 points)

Up to 0.5, each 0.1 = 1 point; Above 0.5, each 0.1 = 2 points

16/48 = 0.33

Are the Industrial, Mixed Employment, or Mixed Use areas leased or owned?

Leased

Owned

Other – please describe:

Have you identified potential occupants for each land use?

Yes

No

If yes, list all potential occupants identified and their intended use:

Bosa Foods Store

Resources

Official community Plan Overall Land Use Plan Map

NAICS

Metro Vancouver Industrial Lands Strategy

Enforcement

- Commitment confirmed through Building Permit Plans re: space/occupant designation

- For owner spaces, proof of registration of the Strata Plan at Land Title & Survey Authority submitted.

Staff comments

Score 6 /20

<p>EC5 (12 points possible)</p> <p>Does the project retain industrial uses on site?</p> <p><input type="checkbox"/> Yes</p> <p><input type="checkbox"/> No</p> <p><input checked="" type="checkbox"/> N/A</p> <p>If yes:</p> <p>Will the zoning restrict a portion of the project to light industrial uses? (5 points)</p> <p><input type="checkbox"/> Yes</p> <p><input type="checkbox"/> No</p> <p>Will the industrial use(s) be multi-level (E.g., mezzanine)? (up to 5 points)</p> <p><input type="checkbox"/> Yes</p> <p><input type="checkbox"/> No</p> <p>Will the proposed tenants intensify the use of industrial space? (2 points)</p> <p><input type="checkbox"/> Yes</p> <p><input type="checkbox"/> No</p> <p>What is the industrial floor space ratio (FSR)? _____</p>	<p>Enforcement</p> <ul style="list-style-type: none"> - Architectural elements will be secured through the Development Permit. - Occupancy will be confirmed as a part of the Building Permit. <p>Staff comments</p> <div style="border: 1px solid gray; padding: 5px;"> <p>Applicant has marked N/A</p> </div> <p style="text-align: right;">Score <input type="text" value="0"/> /12</p>
<p>EC6 (7 points possible)</p> <p>Do the sizes and configuration of retail units in the project support a variety of occupants, employment, and uses for those units?</p> <p><input checked="" type="checkbox"/> Yes</p> <p><input type="checkbox"/> No</p> <p><input type="checkbox"/> N/A</p> <p>If yes, check all that will be incorporated: (up to 7 points)</p> <p><input checked="" type="checkbox"/> Ceiling heights of at least 12' (floor to ceiling, not floor to slab) (1 point)</p> <p><input type="checkbox"/> Appropriate setbacks to allow for seating, patios, public art, and other streetscape features and amenities (1 point)</p> <p><input checked="" type="checkbox"/> For corner developments, a corner retail storefront with wraparound glazing (1 point)</p> <p><input type="checkbox"/> Variety of storefront widths, depths, ventilation, and glazing treatments etc. to meet the needs of different tenants (1 point)</p> <p><input checked="" type="checkbox"/> Exterior lighting is positioned and integrated to enhance architecture and storefront design (1 point)</p> <p><input checked="" type="checkbox"/> Storefronts are adaptable to accommodate different signage types to support tenant's branding while maintaining neighbourhood character (1 point)</p> <p><input checked="" type="checkbox"/> Adaptable to emerging retail trends e.g., online orders (1 point)</p>	<p>Enforcement</p> <ul style="list-style-type: none"> - Architectural elements will be secured through the Development Permit. <p>Staff comments</p> <div style="border: 1px solid gray; padding: 5px;"> <p>applicant has removed some choices that did not make sense for this application.</p> <p>this was removed "Variety of storefront widths, depths, ventilation, and glazing treatments etc. to meet the needs of different tenants"</p> <p>this is questionable: Storefronts are adaptable to accommodate different signage types to support tenant's branding while maintaining neighbourhood character.</p> </div> <p style="text-align: right;">Score <input type="text" value="6"/> /7</p>

<p>EC7 (6 points possible)</p> <p>Does the project contribute to a circular economy?</p> <p><input type="checkbox"/> Yes</p> <p><input checked="" type="checkbox"/> No</p> <p>If yes, check all the circular economy initiatives: (up to 6 points)</p> <ul style="list-style-type: none"> <input type="checkbox"/> re-use of resources (deconstruction for re-use, materials made from recycled/reclaimed materials, materials made from natural inputs) <i>(2 points)</i> <input type="checkbox"/> local repair café <i>(2 points)</i> <input type="checkbox"/> collaboration between local enterprises/industry <i>(2 points)</i> <input type="checkbox"/> design for the future/design for deconstruction <i>(2 points)</i> <input type="checkbox"/> maker-space/tool library <i>(2 points)</i> <input type="checkbox"/> foster a sharing initiative (e.g., car share, bike share etc.) <i>(2 points)</i> <input type="checkbox"/> Other – please describe: <i>(up to 2 points)</i> <div style="border: 1px solid black; height: 40px; width: 100%; margin-top: 5px;"></div>	<p>Resources</p> <p>Canadian Circular Economy</p> <hr/> <p>Enforcement</p> <ul style="list-style-type: none"> - Architectural elements will be secured through the Development Permit. - Waste related initiatives may be subject to securities. - Other elements may be secured with a Section 219 Covenant. <hr/> <p>Staff comments</p> <div style="border: 1px solid black; height: 80px; width: 100%;"></div> <p style="text-align: right;">Score <input type="text" value="0"/> /6</p>
<p>EC8 (5 points possible)</p> <p>Is the project expected to contribute to the daytime economy (i.e. daytime population comprised of workers and students) and/or the nighttime economy of Port Moody (i.e. commercial activities in the evening e.g., restaurant, entertainment, sports, culture, shops, etc.)?</p> <p><input checked="" type="checkbox"/> Yes</p> <p><input type="checkbox"/> No</p> <p>If yes, check any of the following sectors that you may be targeting: (up to 5 points)</p> <ul style="list-style-type: none"> <input type="checkbox"/> Incorporate office, institutional or light industrial space <i>(5 points)</i> <input checked="" type="checkbox"/> Food and beverage establishment (e.g., restaurant, coffee shop, etc.) <i>(3 points)</i> <input type="checkbox"/> Tourism business <i>(1 point)</i> 	<p>Enforcement</p> <ul style="list-style-type: none"> - Architectural elements will be secured through the Development Permit. - Elements related to occupancies will be confirmed through the Building Permit. <hr/> <p>Staff comments</p> <div style="border: 1px solid black; height: 80px; width: 100%;"></div> <p style="text-align: right;">Score <input type="text" value="3"/> /5</p>

<p>EC9 (4 points possible)</p> <p>Does the project provide a regional destination for commercial or institutional land uses?</p> <p><input checked="" type="checkbox"/> Yes</p> <p><input type="checkbox"/> No</p> <p>If yes, please check all that apply: (up to 4 points)</p> <ul style="list-style-type: none"> <input checked="" type="checkbox"/> specialized training/education (2 points) <input type="checkbox"/> specialized art (2 points) <input checked="" type="checkbox"/> culture/heritage (2 points) <input type="checkbox"/> recreational opportunities (e.g., high performance training centre) (2 points) <input checked="" type="checkbox"/> Other – please describe: (up to 2 points) <div style="border: 1px solid black; padding: 5px; margin-top: 10px;"> <p>-Bosa Foods may host events and cooking classes -The Food store provide specialty Italian products</p> </div>	<p style="background-color: #cccccc; padding: 2px;">Enforcement</p> <ul style="list-style-type: none"> - Architectural elements will be secured through the Development Permit. - Elements related to occupancies will be confirmed through the Building Permit. <p style="background-color: #cccccc; padding: 2px;">Staff comments</p> <div style="border: 1px solid #ccc; padding: 5px; margin-top: 5px;"> <p>Applicant needs to address the selected choices. How does the development provide from your selection?</p> <p>Applicant has selected "Perhaps in the "other" category" (satisfactory)</p> </div> <p style="text-align: right;">Score <input type="text" value="2"/> /4</p>
<p>EC10 (3 points possible)</p> <p>Will the project attempt to source local (Port Moody) labour, supply and materials?</p> <p><input type="checkbox"/> Yes</p> <p><input checked="" type="checkbox"/> No</p> <p>If yes, check all that apply: (up to 3 points)</p> <ul style="list-style-type: none"> <input type="checkbox"/> Local supply of materials (1 point) <input type="checkbox"/> Local labour (1 point) <input type="checkbox"/> Local contractors (1 point) <input type="checkbox"/> Local professional services (1 point) <input type="checkbox"/> Other – please describe: (1 point) <div style="border: 1px solid black; height: 50px; margin-top: 10px;"></div>	<p style="background-color: #cccccc; padding: 2px;">Enforcement</p> <ul style="list-style-type: none"> - Architectural elements will be secured through the Development Permit. - Contractors will be confirmed through the Building Permit. <p style="background-color: #cccccc; padding: 2px;">Staff comments</p> <div style="border: 1px solid #ccc; height: 100px; margin-top: 5px;"></div> <p style="text-align: right;">Score <input type="text" value="0"/> /3</p>

<p>EC11 (3 points possible)</p> <p>Does your project include any innovative economic sustainability aspects not captured?</p> <p><input type="checkbox"/> Yes</p> <p><input checked="" type="checkbox"/> N/A</p> <p>If yes, please describe: <i>(up to 3 points)</i></p> <div style="border: 1px solid black; height: 80px; width: 100%;"></div>	<p>Enforcement</p> <p>- Will depend on the type of innovation, determined by staff.</p> <p>Staff comments</p> <div style="border: 1px solid black; padding: 5px;">Applicant has marked N/A</div> <p style="text-align: right;">Score <input type="text" value="0"/> /3</p>
<p>EC12</p> <p>Does your project face any unique site constraints unique that limit economic sustainability achievement?</p> <p><input type="checkbox"/> Yes</p> <p><input checked="" type="checkbox"/> No</p> <p>If yes, please describe:</p> <div style="border: 1px solid black; height: 80px; width: 100%;"></div>	<p>Enforcement</p> <p>- N/A</p> <p>Staff comments</p> <div style="border: 1px solid black; height: 150px; width: 100%;"></div>

EC13

(3 points possible)

Summarize the project’s economic sustainability contributions including the performance criteria in this Report Card and additional elements not previously captured here:

The Bosa Foods project contributes to the economic sustainability of Port Moody in several ways. It creates connectivity to the existing active transportation network and eliminates barriers to access for active transportation, improving let-downs and accessibility. Additionally, it enhances trails and bike paths with the installation of the St. Johns Street multi-use path. The project also creates public amenity spaces, such as the rooftop garden and children’s play area, and incorporates greenery and landscaping to serve pedestrians and direct patrons to commercial areas and transit. Wide sidewalks and separation from the road encourage and promote pedestrian movement, while seating, public art, and other amenities are incorporated into the design of the retail storefront area. Finally, the receiving and shipping areas are located off pedestrian routes from Queen Street. Overall, these contributions promote economic sustainability by creating a vibrant and accessible commercial and public space that benefits residents and visitors alike.

Enforcement

- Highlighted in Council report

Staff comments

Score /3

Total Economic Sustainability Pillar Points = /93

3. Environmental Sustainability

Natural Environment	
<p>EN1 (20 points possible)</p> <p>Does the project protect and enhance the urban forest, prioritizing tree retention and planting of native or adaptive tree species which provide multi-storey habitat (groundcover, shrubs and trees) to increase ecological value, biodiversity, and resilience to climate change impacts?</p> <p><input checked="" type="checkbox"/> Yes</p> <p><input type="checkbox"/> No</p> <p><input type="checkbox"/> N/A</p> <p>If yes:</p> <p>Outline the following:</p> <p>Number of existing significant mature trees protected on site (i.e., mature trees over 40 cm DBH): <u>0</u> (up to 5 points)</p> <p>Number of existing trees over 10 cm protected on site: <u>0</u> (up to 5 points)</p> <p>Replacement tree ratio: <u>1.57:1 (total), 1.65:1 (onsite)</u> (up to 5 points) <i>(Note: Native tree species are preferred for areas immediately adjacent to Environmentally Sensitive Areas)</i></p> <ul style="list-style-type: none"> • Trees planted on-site: <u>13</u> • Trees planted off-site: <u>9</u> • Cash-in-lieu: _____ <p>Existing canopy cover (%): <u>43%</u></p> <p>Proposed canopy cover at 20 years post development (%): <u>40% (*)</u> <i>If canopy cover is the same = 3 points</i> <i>If proposed canopy cover exceeds existing = up to 5 points</i></p> <p>Demonstrate ability of trees to reach full maturity. Check all that apply: (up to 5 points)</p> <p><input checked="" type="checkbox"/> Adequate soil volume as determined by the Canadian Landscape Standard (2 points)</p> <p><input type="checkbox"/> Designated space for significant trees/stand of trees to reach full maturity (2 points)</p> <p><input checked="" type="checkbox"/> Proximity to infrastructure (e.g., Building(s), power lines) (1 point)</p>	<p>Resources</p> <p>Tree Protection Bylaw</p> <p>I-tree Canopy</p> <p>Canadian Landscape Standard</p> <p>New canopy cover is calculated based on the type of trees that are being planted, at 20 year maturity.</p> <p>Large Canopy Trees provide 125 m² per tree (e.g., Douglas Fir, Deodor Cedar, Red Oak)</p> <p>Medium Canopy Trees provide 50 m² per tree (e.g., Evergreen magnolia, Honey locust)</p> <p>Small Canopy Trees provide 25 m² per tree (e.g., Japanese maple, Giant Dogwood)</p> <p>Sum Total Species Canopy Area for all proposed species and divide by gross site area to obtain mature canopy coverage percentage</p> <hr/> <p>Enforcement</p> <ul style="list-style-type: none"> - Elements on Landscape Plans will be subject to securities. - Tree Protection Covenants may be applied. <hr/> <p>Staff comments</p> <div style="border: 1px solid #ccc; padding: 5px;"> <p>Applicant Changed to "Yes (*) 40% (Does not include offsite replanting)"</p> <p>Scoring for replacement trees and selected choices. Staff are providing contingent scoring on applicants ability to follow through with bottom selection</p> </div>
<p>Score 8 /20</p>	

EN2

(15 points possible)

Does the site stormwater management plan provide adequate stormwater quality, volume and groundwater protection to address the relevant senior and municipal government requirements for future rainfall expected with climate change?

Yes

No

If yes:

Do the site conditions work to restore stormwater flows to be closer to pre-development historical conditions? **(2 points)**

Yes

No

Indicate which of these approaches the project will use:

A. Nature-based Green Infrastructure solutions

Check all that apply: (up to 9 points)

- Watercourse daylighting *(3 points)*
- Constructed wetlands *(3 points)*
- Rain gardens *(up to 3 points)*
- Bioswales *(up to 3 points)*
- Green roof/wall *(up to 3 points)*
- Other – please describe: *(up to 2 points)*

B. Engineered Green Infrastructure solutions

Check all that apply: (up to 4 points)

- Rainwater harvesting *(2 points)*
- Systems that support street trees (e.g., trenches, soil cells, structural soils, etc.) *(1 point)*
- Roof downspout disconnection to Green Infrastructure *(1 point)*
- Water quality structures *(1 point)*
- Absorbent landscaping *(1 point)*
- Other – please describe: *(up to 2 points)*

Resources

[Metro Vancouver's Stormwater Source Control Guidelines](#)

[Climate Action Plan](#)

[The Chines Integrated Stormwater Management Report \(metrovancover.org\)](#)

[DFO Land Development Guidelines](#)

[2018 KWL IDF Curves for Climate Change](#)

Enforcement

- Submission of stormwater management plan that addresses the goals indicated will be required.
- Elements on Landscape Plans will be subject to securities.
- Elements included on Civil Plans will be secured through the Servicing Agreement.

Staff comments

Score /15

EN3 (applicants choose A or B) (15 or 6 points possible)

A. Does the project protect, restore and/or compensate for site ecology on-site?

- Yes
- No
- N/A (applicants choose A or B)

If yes, check all that apply: (up to 15 points)

- Watercourse daylighting (5 points)
- Constructed wetlands (3 points)
- No increase in existing impervious area (4 points)
Area (m²): _____
- Riparian Area Restoration (up to 3 points)
- Aquatic restoration (2 points)
- Non-riparian forest restoration (2 points)
- Native/"naturescape" landscaping (2 points)
- Removal of invasive plant species from natural areas (2 points)
- Other biodiversity and habitat enhancement (1 point)
- Salvage replanting (1 point)
- Other – please describe: (up to 3 points)

OR

B. Does the project provide other biodiversity enhancement in an urban setting?

- Yes
- No
- N/A (applicants choose A or B)

If yes, check all that apply: (up to 6 points)

- Other biodiversity and habitat enhancement (1 point)
- Native/"naturescape" landscaping (2 points)
- Other – please describe: (up to 3 points)

Resources

[Naturescape Policy 13-6410-03](#)

Enforcement

– Elements on Landscape Plans will be subject to securities.

Staff comments (A)

Staff comments (B)

Applicant is encouraged to review selection and naturescape policy in combination with their application.

Score /15 or 6

EN4

(10 points possible)

Is the proposed property located in an Environmentally Sensitive Area (ESA)?

Yes

N/A

If yes:

i. What is the designation of the ESA?

ii. What are the means of ESA protection? (up to 8 points)

- Dedication (3 points)
- Covenant (1 point)
- Monitoring (up to 2 points)
- Other – please explain: (up to 2 points)

iii. How is the ESA being improved? (up to 2 points)

Resources

[Official Community Plan Map 13: Environmentally Sensitive Areas and Appendix 2: Development Permit Area Guidelines](#)

Enforcement

– Environmentally Sensitive Area DP, other means of protection are required as established in criteria ii.

Staff comments

Applicant has selected N/A

Score /10

<p>EN5 (5 points possible)</p> <p>Does the project reduce potable water use from existing site conditions and/or per capita?</p> <p><input checked="" type="checkbox"/> Yes</p> <p><input type="checkbox"/> No</p> <p>If yes, check all that apply: (up to 5 points)</p> <ul style="list-style-type: none"> <input checked="" type="checkbox"/> Drought tolerant landscaping (xeriscaping) with native species (0.5 points) <input type="checkbox"/> Installation of a water meter display to show consumption for occupants more frequently than billing (0.5 points) <input type="checkbox"/> Non-water dependent materials/features for ground cover treatment (0.5 points) <input checked="" type="checkbox"/> Irrigation system with central control, rain sensors, and drip irrigation on and off-site (0.5 points) <input type="checkbox"/> Captured rainwater irrigation or greywater system (0.5 points) <input type="checkbox"/> Other – please explain: (up to 2 points) <div style="border: 1px solid black; height: 60px; width: 100%; margin-top: 10px;"></div>	<p>Resources</p> <p>Water meter Specifications</p> <p>Enforcement</p> <ul style="list-style-type: none"> - Elements included on Civil Plans will be secured through the Servicing Agreement. - Elements on Landscape Plans will be subject to securities. - Low flow/flush and greywater systems will be confirmed through the Building Permit. - Elements noted on Mechanical Drawings will be confirmed through the Building Permit. <p>Staff comments</p> <div style="border: 1px solid black; padding: 5px; min-height: 100px;"> <p>Applicant will be expected to adhere to proposed selections. Scoring is conditional</p> </div> <p style="text-align: right;">Score <input type="text" value="1"/> /5</p>
<p>EN6 (5 points possible)</p> <p>Is the project located along the Burrard Inlet foreshore or otherwise impacted by coastal flooding (e.g., sea level rise, coastal squeeze, etc.)?</p> <p><input type="checkbox"/> Yes</p> <p><input checked="" type="checkbox"/> N/A</p> <p>If yes, describe how the project will mitigate risks and impacts of coastal flooding events in current and future climate scenarios: (up to 5 points)</p> <div style="border: 1px solid black; height: 100px; width: 100%; margin-top: 10px;"></div>	<p>Resources</p> <p>Green Shores</p> <p>Port Moody Zoning Bylaw Section 5.3.5</p> <p>Enforcement</p> <ul style="list-style-type: none"> - Setbacks and minimum building elevation are confirmed through the Development Permit and Building Permit. <p>Staff comments</p> <div style="border: 1px solid black; padding: 5px; min-height: 100px;"> <p>Applicant has selected N/A</p> </div> <p style="text-align: right;">Score <input type="text" value="0"/> /5</p>

<p>EN7 (5 points possible)</p> <p>Does the project redevelop and rehabilitate a brownfield site? <i>(5 points)</i></p> <p><input type="checkbox"/> Yes</p> <p><input checked="" type="checkbox"/> N/A</p>	<p>Resources</p> <p>Brownfields</p> <p>Contaminated Sites Regulations</p> <p>Enforcement</p> <p>- Proof of compliance with provincial contaminated sites regulations will be required.</p> <p>Staff comments</p> <div style="border: 1px solid gray; padding: 5px; min-height: 50px;"> <p>Applicant has selected N/A</p> </div> <p style="text-align: right;">Score <input type="text" value="0"/> /5</p>
<p>EN8 (4 points possible)</p> <p>Does the design of outdoor lighting incorporate technology to minimize the harmful effects of light pollution?</p> <p><input checked="" type="checkbox"/> Yes</p> <p><input type="checkbox"/> No</p> <p>Check all that apply to ensure that lights are: <i>(up to 4 points)</i></p> <ul style="list-style-type: none"> <input checked="" type="checkbox"/> Only on when needed <i>(0.5 points)</i> <input checked="" type="checkbox"/> Only light the area that needs it <i>(0.5 points)</i> <input checked="" type="checkbox"/> No brighter than necessary <i>(0.5 points)</i> <input checked="" type="checkbox"/> Minimizes blue light emissions <i>(0.5 points)</i> <input checked="" type="checkbox"/> Fully shielded (pointing downward) <i>(0.5 points)</i> <input checked="" type="checkbox"/> LED lights <i>(0.5 points)</i> <input checked="" type="checkbox"/> Non-reflective pavement surface <i>(0.5 points)</i> <input type="checkbox"/> Other – describe the lighting plan for the site and its dark sky friendly features: <i>(up to 0.5 points)</i> <div style="border: 1px solid gray; height: 100px; width: 100%; margin-top: 10px;"></div>	<p>Resources</p> <p>International Dark Sky Association for Dark Sky Friendly Lighting</p> <p>Enforcement</p> <p>- Lighting details will be confirmed through the Building Permit and will be subject to securities through Landscape Plans.</p> <p>Staff comments</p> <div style="border: 1px solid gray; padding: 5px; min-height: 150px;"> <p>elements will need to be addressed at later stages.</p> </div> <p style="text-align: right;">Score <input type="text" value="4"/> /4</p>

<p>EN9 (3 points possible)</p> <p>Does the project provide bird-friendly development through landscaping features that provide habitat to native species and building design that reduces bird collisions?</p> <p><input checked="" type="checkbox"/> Yes</p> <p><input type="checkbox"/> No</p> <p>If yes, check all that apply: (up to 3 points)</p> <ul style="list-style-type: none"> <input checked="" type="checkbox"/> Building design minimizes the quantity of glass <i>(0.5 points)</i> <input type="checkbox"/> Incorporation of visual markers <i>(0.5 points)</i> <input checked="" type="checkbox"/> Incorporation of features to block reflections <i>(0.5 points)</i> <input checked="" type="checkbox"/> Landscaping is appropriate distance from glass features <i>(0.5 points)</i> <input checked="" type="checkbox"/> Reduces light pollution <i>(0.5 points)</i> <input checked="" type="checkbox"/> Building design reduces trapping potential by ensuring open pipes, ventilation grates and drains are inaccessible to birds <i>(0.5 points)</i> <input checked="" type="checkbox"/> Landscaping plan incorporates a diversity of native plants that provide food options for birds throughout the year <i>(0.5 points)</i> <input checked="" type="checkbox"/> Landscaping plan creates habitat complexity by including ground cover, shrubs, understory, and canopy layers in a stepped pattern <i>(0.5 points)</i> <input type="checkbox"/> Other – please explain: <i>(0.5 points)</i> <div style="border: 1px solid black; height: 30px; width: 100%; margin-top: 5px;"></div>	<p>Resources</p> <p>Vancouver Bird Strategy</p> <p>Enforcement</p> <ul style="list-style-type: none"> - Elements included on Landscape Plans will be subject to securities. - Architectural elements will be secured through the Development Permit. <p>Staff comments</p> <div style="border: 1px solid black; height: 150px; width: 100%;"></div> <p style="text-align: right;">Score <input type="text" value="3"/> /3</p>
<p>EN10 (2 points possible)</p> <p>Does the project include forest fire prevention measures or fire smart building features?</p> <p><input type="checkbox"/> Yes</p> <p><input checked="" type="checkbox"/> No</p> <p>If yes, list all features: (up to 2 points)</p> <div style="border: 1px solid black; height: 100px; width: 100%; margin-top: 5px;"></div>	<p>Resources</p> <p>Fire Smart Canada</p> <p>Enforcement</p> <ul style="list-style-type: none"> - Materials will be confirmed through the Building Permit. <p>Staff comments</p> <div style="border: 1px solid black; height: 100px; width: 100%;"></div> <p style="text-align: right;">Score <input type="text" value="0"/> /2</p>

<p>EN11 (2 points possible)</p> <p>Is the project seeking third party environmental certifications (e.g., Salmon Safe BC certification)?</p> <p><input type="checkbox"/> Yes</p> <p><input checked="" type="checkbox"/> No</p> <p><input type="checkbox"/> N/A</p>	<p>Resources</p> <p>Salmon Safe BC Certification</p> <p>Enforcement</p> <p>- Certification will be confirmed through Section 219 Covenant.</p> <p>Staff comments</p> <div style="border: 1px solid gray; height: 80px; width: 100%;"></div> <p style="text-align: right;">Score <input type="text" value="0"/> /2</p>
<p>Air Quality – Low Carbon Mobility</p>	
<p>EN12 (12 points possible)</p> <p>Does the project provide sustainable transportation infrastructure for user groups of each land use type, which contributes to reducing greenhouse gas emissions from this development beyond requirements in the Zoning Bylaw?</p> <p><input checked="" type="checkbox"/> Yes</p> <p><input type="checkbox"/> No</p> <p>If yes, check all that apply: (up to 12 points)</p> <ul style="list-style-type: none"> <input type="checkbox"/> Unbundled and/or district parking (2 points) <input checked="" type="checkbox"/> Level 2 EVSE installed (as defined in technical bulletin) (2 points) <input type="checkbox"/> Public EV DC Fast Charging EVSE installed (2 points) <input type="checkbox"/> More than 20% of commercial EV charging infrastructure provided (1 point) <input type="checkbox"/> Subsidized transit pass and transit information package (1 point) <input checked="" type="checkbox"/> Micro e-charging is provided for a minimum of 10% of storage/parking spaces (e.g., e-bicycle, e-scooter) (1 point) <input checked="" type="checkbox"/> Energized EV Charging for visitor parking (1 point) <input type="checkbox"/> End of trip bicycle facilities (1 point) <input type="checkbox"/> Bike share and assigned parking (1 point) <input type="checkbox"/> Car share and assigned parking space provision in nearby on-street/public parking (1 point) <input type="checkbox"/> Other – please describe: (up to 2 points) <div style="border: 1px solid gray; height: 50px; width: 100%; margin-top: 10px;"></div>	<p>Resources</p> <p>Port Moody Zoning Bylaw</p> <p>Port Moody Electric Vehicle charging Infrastructure Bulletin</p> <p>Enforcement</p> <p>- Elements noted on Architectural Plans will be confirmed through the Development Permit and Building Permit Plans.</p> <p>- Transit passes/unbundled & district parking will be secured through a Section 219 Covenant.</p> <p>- End of trip facilities/parking uses included on Architectural Plans will be confirmed through the Development Permit.</p> <p>Staff comments</p> <div style="border: 1px solid gray; height: 100px; width: 100%;"></div> <p style="text-align: right;">Score <input type="text" value="4"/> /12</p>

Considered at the July 23, 2024, Regular Council meeting

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Attachment 11

<p>EN13 (11 points possible)</p> <p>Does the project incorporate measures to support and increase active transportation?</p> <p><input checked="" type="checkbox"/> Yes</p> <p><input type="checkbox"/> No</p> <p>If yes, check all that apply: <i>(up to 11 points):</i></p> <ul style="list-style-type: none"> <input checked="" type="checkbox"/> Connects to existing pedestrian/cycling routes and priority destinations <i>(1 point)</i> <input checked="" type="checkbox"/> Improved crossings of busy streets <i>(1 point)</i> <input checked="" type="checkbox"/> Improved local pedestrian routes, local bike networks/trails <i>(1 point)</i> <input checked="" type="checkbox"/> Safe, secure, accessible, and sustainable footpaths <i>(1 point)</i> <input checked="" type="checkbox"/> Pedestrian clearway sufficient to accommodate pedestrian flow <i>(1 point)</i> <input checked="" type="checkbox"/> Covered outdoor waiting areas, overhangs, or awnings <i>(1 point)</i> <input checked="" type="checkbox"/> Pedestrian scale lighting <i>(1 point)</i> <input checked="" type="checkbox"/> Pedestrian/bike only zones <i>(1 point)</i> <input checked="" type="checkbox"/> Improves connections to transit (bus/SkyTrain/West Coast Express) <i>(1 point)</i> <input type="checkbox"/> Other – please describe: <i>(up to 2 points)</i> <div style="border: 1px solid black; height: 40px; width: 100%; margin-top: 5px;"></div>	<p>Resources</p> <p>Port Moody Master Transportation Plan</p> <p>Enforcement</p> <ul style="list-style-type: none"> - Elements included in Civil Plans will be included in Servicing Agreement. - Elements included in Architectural Plans will be secured through Development Permit. <p>Staff comments</p> <div style="border: 1px solid black; padding: 5px; margin-top: 5px;"> <p>Scoring is conditional. Applicant needs to address staff comments concerning the civil drawings and traffic study. Once File manager is satisfied points will not be conditional</p> <p>Provided by traffic study and civil</p> </div> <p style="text-align: right;">Score <input type="text" value="9"/> /11</p>
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Greenhouse Gas Emissions and Energy Reductions	
<p>EN14 (12 points possible)</p> <p>Does the project provide a low carbon energy system (LCES), which prioritizes on-site local energy systems that provide heating, cooling and hot water heating? (Note: systems should meet a Coefficient of Performance of 2 or greater) Examples include: solar; district energy; heat pump; or geo exchange.</p> <p><input checked="" type="checkbox"/> Yes</p> <p><input type="checkbox"/> No</p> <p>If yes:</p> <p>Describe the system type: (up to 10 points)</p> <ul style="list-style-type: none"> • Heating mechanical system (up to 5 points) <ul style="list-style-type: none"> - Description: <u>In-suite heat pump and HRV combo unit</u> - Fuel source (e.g., electricity, renewable etc.): <u>electricity</u> • Hot water mechanical system (up to 3 points) <ul style="list-style-type: none"> - Description: <u>Centralized CO2 heat pump with electric back-up</u> - Fuel source (e.g., electricity, renewable etc.): <u>electricity</u> • Cooling mechanical system (up to 2 points) <ul style="list-style-type: none"> - Description: <u>In-suite heat pump and HRV combo unit</u> - Fuel source (e.g., electricity, renewable etc.): <u>electricity</u> <p>Does the system use refrigerants with low global warming potential (GWP)?</p> <p><input checked="" type="checkbox"/> Yes</p> <p><input type="checkbox"/> No</p> <p><input type="checkbox"/> N/A</p> <p>If yes, check the low GWP system being installed: (up to 2 points)</p> <ul style="list-style-type: none"> <input checked="" type="checkbox"/> Centralized system (e.g., communal heat pump) using ammonia, R744, water, CO2, R1234ze, or R1234yf, R454b, R513a, R32, R410a, R407c, R134a (2 points) <input type="checkbox"/> Distributed system (e.g., VRF) using R32 or equivalent (2 points) <input checked="" type="checkbox"/> Individual system (e.g., split or individual heat pump) using R290 propane, R744, or R134a (2 points) <input type="checkbox"/> Other (up to 2 points) <div style="border: 1px solid black; height: 20px; width: 100%; margin-top: 5px;"></div> <p>How will the project mitigate refrigerant leakage?</p> <div style="border: 1px solid black; padding: 5px; margin-top: 5px;"> <p>Compact all in one in-suite heat pump with factory installed refrigerant charge, will reduce the refrigerant pipe length installation. Units will be installed by a registered installer with the manufacturer of the system.</p> </div>	<p>Resources</p> <p>Energy Step Code Corporate Policy</p> <p>Vancouver low carbon energy system policy</p> <p>Refrigerants & Environmental Impacts: A Best Practice Guide - Integral Group</p> <p>Enforcement</p> <ul style="list-style-type: none"> - LCES confirmed through the Energy Step Code Corporate Policy commitment and Building Permit. - Mechanical systems confirmed through Building Permit Plans. <p>Staff comments</p> <div style="border: 1px solid #ccc; padding: 5px; margin-top: 5px;"> <p>previous report card submission had "How will the project mitigate refrigerant leakage?" answered. Applicant should include previous detailed explanation</p> <p>Applicant has "Added the previous response back concerning leakage"</p> </div>
Score 12 /12	

EN15

(11 points possible)

Will the project include strategies to reduce lifecycle (embodied) greenhouse gas emissions from the project and increase carbon sequestration?

(Note that projects should aim to have total embodied carbon emissions below 500 kgCO₂e/m²)

- Yes**
- No**

If yes:

Check all that apply: **(up to 10 points)**

- Tracking and reporting project embodied emissions *(1 point)*
- Embodied emissions third-party certification: *(1 point)*
 List the certification: _____
- Wood frame construction *(2 points)*
- Low carbon concrete construction *(1 point)*
- materials sourced locally to reduce transportation emissions *(1 point)*
- labour sourced locally to reduce transportation emissions *(1 point)*
- Selecting materials with environmental product declarations *(1 point)*
- Low embodied emissions disposal of materials *(1 point)*
- Utilization of natural insulation products *(1 point)*
- Targeting third party certification under ISO 14040, ISO 14044, and/or EN15978 *(2 points)*
- Commitment to reduce at least 40% of embodied emissions compared to project embodied emissions baseline: *(2 points)*
 % reduction committed to: _____
- Submission of pre- and post-construction lifecycle assessment *(1 point)*
- Low embodied emissions material selection policy *(1 point)*
- Benchmarking embodied emissions performance *(1 point)*
- Other – please describe: *(1 point)*

Please state the estimated embodied emissions of the project: (1 point)

- over the building's estimated lifespan: _____
- in kgCO₂e/m²: _____

Provide the name of the calculator used to provide an estimate and/or the name of the organization who provided the embodied emissions analysis:

Resources

- [Life Cycle Assessment \(LCA\) Practice Guide \[Carbon Leadership Forum\]](#)
- [CLF Embodied Carbon Policy Toolkit - Carbon Leadership Forum](#)
- [lcm-public-sector-guide.pdf \(gov.bc.ca\)](#)
- [Methodology to Calculate Embodied Carbon of Materials \[RICS\] \(PDF\)](#)
- [Whole Building Life Cycle Assessment: Reference Building Structure and Strategies \[ASCE\]](#)
- [Zero Code – Off-Site Procurement of Renewable Energy \[Architecture 2030\] \(PDF\)](#)
- [Carbon Smart Materials Palette \[Architecture 2030\]](#)
- [Athena Impact Estimator](#)
- [Environment Agency's Carbon Calculator for Construction Activities](#)
- [eTool](#)
- [One Click LCA](#)
- [Tally](#)

Project teams may use a carbon calculator that is not listed above but must include the name of tool/organization completing the assessment

Enforcement

- Commitment will be secured through Section 219 Covenant.

Staff comments

Score 5 /11

<p>EN16 (10 points possible)</p> <p>Will the project achieve a recognized industry standard for sustainable design? (Note that the City does not accept equivalencies and applicants must complete full certification)</p> <p><input type="checkbox"/> Yes</p> <p><input checked="" type="checkbox"/> No</p> <p><input type="checkbox"/> N/A</p> <p>If yes, check all that apply:</p> <p><input type="checkbox"/> Built Green Canada – certification level: (10 points)</p> <p>_____</p> <p><input type="checkbox"/> LEED – certification level: (10 points)</p> <p>_____</p> <p><input type="checkbox"/> Zero Carbon Building Standard (10 points)</p> <p><input type="checkbox"/> Energy Star (10 points)</p> <p><input type="checkbox"/> BOMA BEST (10 points)</p> <p><input type="checkbox"/> Canadian Passive House Institute (10 points)</p> <p><input type="checkbox"/> International Living Future Institute – Zero Carbon Certification (10 points)</p> <p><input type="checkbox"/> Other – please describe: (up to 10 points)</p> <p>_____</p>	<p>Resources</p> <p>Built Green Canada</p> <p>LEED Canada</p> <p>Zero Carbon Building Standard</p> <p>Energy Star</p> <p>BOMA BEST</p> <p>Canadian Passive House Institute</p> <p>ILFI – Zero Carbon Certification</p> <p>Enforcement</p> <p>– Commitment will be secured through Section 219 Covenant.</p> <p>Staff comments</p> <div style="border: 1px solid black; height: 80px; width: 100%;"></div> <p style="text-align: right;">Score <input type="text" value="0"/> /10</p>
<p>EN17 (8 points possible)</p> <p>Does the project include strategies to ensure buildings do not overheat in future climate change scenarios?</p> <p><input checked="" type="checkbox"/> Yes</p> <p><input type="checkbox"/> No</p> <p>If yes, check all that apply: (up to 8 points)</p> <p><input checked="" type="checkbox"/> Natural/passive ventilation (1 point)</p> <p><input type="checkbox"/> Stacked windows (1 point)</p> <p><input type="checkbox"/> Earth tempering ducting (1 point)</p> <p><input type="checkbox"/> Passive evaporative cooling (1 point)</p> <p><input checked="" type="checkbox"/> Fixed/operable external shading (1 point)</p> <p><input checked="" type="checkbox"/> Natural shading (1 point)</p> <p><input checked="" type="checkbox"/> Low window to wall area ratio (1 point)</p> <p><input type="checkbox"/> Thermal massing (1 point)</p> <p><input checked="" type="checkbox"/> Building Energy Model using future climate weather files (1 point)</p> <p><input checked="" type="checkbox"/> High-efficiency low carbon mechanical cooling (1 point)</p> <p><input checked="" type="checkbox"/> Other – please describe: (up to 2 points)</p> <div style="border: 1px solid black; padding: 5px; margin-top: 5px;"> <p>Low-E coating triple glazed windows</p> </div>	<p>Resources</p> <p>Pacific Climate Impacts Consortium future weather files</p> <p>City of Vancouver Passive Design Toolkit</p> <p>Enforcement</p> <p>– Elements included in Architectural Plans will be secured through the Development Permit and confirmed through the Building Permit.</p> <p>Staff comments</p> <div style="border: 1px solid black; height: 120px; width: 100%;"></div> <p style="text-align: right;">Score <input type="text" value="8"/> /8</p>

<p>EN18 (8 points possible)</p> <p>Does the project reduce the heat island effect on the site?</p> <p><input checked="" type="checkbox"/> Yes</p> <p><input type="checkbox"/> No</p> <p>If yes, check all that apply: (up to 8 points)</p> <p><input type="checkbox"/> Water features on site <i>(1 point)</i></p> <p><input checked="" type="checkbox"/> Natural shade around the structures (trees, climbing plants) <i>(1 point)</i></p> <p><input checked="" type="checkbox"/> Increase canopy cover compared to existing canopy cover <i>(1 point)</i></p> <p><input type="checkbox"/> Green infrastructure such as green roofs, rain gardens, absorbent landscaping etc. <i>(1 point)</i></p> <p><input type="checkbox"/> Use of low-albedo materials <i>(1 point)</i></p> <p><input type="checkbox"/> Reducing waste heat production through energy efficiency and active transportation <i>(1 point)</i></p> <p><input type="checkbox"/> Other – please describe: <i>(up to 2 points)</i></p> <div style="border: 1px solid black; height: 40px; width: 100%;"></div>	<p>Resources</p> <p>Reducing Urban Heat Islands to Protect Health in Canada</p> <p>Enforcement</p> <ul style="list-style-type: none"> - Landscaped elements will be subject to securities. - Elements included in Architectural Plans will be secured through the Development Permit. - Active transportation commitments will be confirmed through the Servicing Agreement and Development Permit as noted on Civil Plans and other plans noted above. <p>Staff comments</p> <div style="border: 1px solid black; height: 60px; width: 100%;"></div> <p style="text-align: right;">Score <input type="text" value="2"/> /8</p>
<p>EN19 (6 points possible)</p> <p>Which Step of the Energy Step Code will the project be designed to comply with?</p> <p>Part 9</p> <p><input type="checkbox"/> Step 3 <i>(0 points)</i></p> <p><input type="checkbox"/> Step 4 <i>(2 points)</i></p> <p><input type="checkbox"/> Step 5 <i>(3 points)</i></p> <p>Part 3</p> <p><input type="checkbox"/> Step 2 <i>(0 points)</i></p> <p><input checked="" type="checkbox"/> Step 3 <i>(2 points for large residential, 3 points for commercial)</i></p> <p><input type="checkbox"/> Step 4 <i>(3 points)</i></p>	<p>Resources</p> <p>Building Bylaw</p> <p>BC Energy Step Code</p> <p>Energy Step Code Corporate Policy</p> <p>Enforcement</p> <ul style="list-style-type: none"> - Step Code commitment will be confirmed through the Building Permit and a Section 219 Covenant. <p>Staff comments</p> <div style="border: 1px solid black; height: 60px; width: 100%;"></div> <p style="text-align: right;">Score <input type="text" value="2"/> /6</p>

EN20

(2 points possible)

Does the project allocate sufficient and accessible recycling and garbage storage space in multi-residential and commercial buildings and complexes compatible with Metro Vancouver’s Technical Specifications for Recycling and Garbage Amenities in Multi Family and Commercial Developments? (1 point)

Yes

No

If yes, outline the space provided for each (m²):

Residential recycling: 12.68

Residential garbage: (22.88-12.68)/2 = 5.1

Residential green waste: (22.88-12.68)/2 = 5.1

Commercial recycling: 10

Commercial garbage: 5

Commercial green waste: 5

Does the design of the waste area provide safe and universally accessible access in a secure common area? (1 point)

Yes

No

If yes – please explain:

Elevator and leveled access

Does the design of the waste area align with the Bear Resistant Guidelines for Solid Waste, Organics, and Recycling Enclosures & Containers?

Yes

No

Resources

[Zoning Bylaw](#)

[Metro Vancouver’s Technical Specifications for Recycling and Garbage Amenities in Multi-family and Commercial Developments](#)

[Bear Resistant Guidelines for Solid Waste, Organics, and Recycling Enclosures & Containers](#)

Enforcement

– Elements included on the Architectural Plans will be secured through the Development Permit.

Staff comments

Score /2

<p>EN21 (3 points possible)</p> <p>Does your project include any innovative environmental sustainability aspects not captured?</p> <p><input checked="" type="checkbox"/> Yes <input type="checkbox"/> N/A</p> <p>If yes, please describe:</p> <div style="border: 1px solid black; padding: 5px; min-height: 60px;"> Waste heat reuse (from freezers), Heat recovery ventilators </div>	<p>Enforcement</p> <p>- Will depend on the type of innovation, determined by staff.</p> <hr/> <p>Staff comments</p> <div style="border: 1px solid black; height: 100px; width: 100%;"></div> <p style="text-align: right;">Score <input type="text" value="3"/> /3</p>
<p>EN22</p> <p>Does your project face any unique site constraints unique that limit environmental sustainability achievement?</p> <p><input type="checkbox"/> Yes <input checked="" type="checkbox"/> No</p> <p>If yes, please describe:</p> <div style="border: 1px solid black; height: 60px; width: 100%;"></div>	<p>Enforcement</p> <p>- Highlighted in Council reports.</p> <hr/> <p>Staff comments</p> <div style="border: 1px solid black; height: 100px; width: 100%;"></div>

EN23

(3 points possible)

Summarize the project’s environmental sustainability contributions including the performance criteria in this Report Card and additional elements not previously captured here:

The project incorporates several environmental sustainability measures, including a site stormwater management plan, biodiversity enhancements with native landscaping, and bird-friendly development through landscaping and building design. The outdoor lighting is designed to minimize light pollution and reduce bird collisions. The project also provides sustainable transportation infrastructure, including EV charging stations and facilities for active transportation. The low carbon energy system prioritizes on-site local energy systems for heating, cooling, and hot water heating. The project also includes strategies to reduce lifecycle greenhouse gas emissions, ensure buildings do not overheat in future climate change scenarios, and reduce the heat island effect. Finally, the project will be designed to step 3 of the energy step code and utilize waste heat from the commercial retail unit's freezers.

Enforcement

- Highlighted in Council reports.

Staff comments

Score /3

Total Environmental Sustainability Pillar Points = /172

4. Social Sustainability

<p>S1 (30 points possible)</p> <p>Does the project provide voluntary amenities?</p> <p><input checked="" type="checkbox"/> Yes</p> <p><input type="checkbox"/> No</p> <p><input type="checkbox"/> N/A <i>(select if making contribution to the City's amenity reserve)</i></p> <p>If yes:</p> <p>Check all that apply: (up to 15 points)</p> <ul style="list-style-type: none"> <input type="checkbox"/> Community centre/facility <i>(15 points)</i> <input checked="" type="checkbox"/> Space for growing food <i>(3 points)</i> <input checked="" type="checkbox"/> Child play areas <i>(1 point)</i> <input checked="" type="checkbox"/> Gathering place/space <i>(1 point)</i> <input type="checkbox"/> Usable public park/greenspace <i>(10 points)</i> <input checked="" type="checkbox"/> Community facilities <i>(3 points)</i> <input checked="" type="checkbox"/> Arts and cultural facilities <i>(3 points)</i> <input checked="" type="checkbox"/> Streetscape and pedestrian improvements <i>(2 points)</i> <input checked="" type="checkbox"/> Accessible landscaped roof deck <i>(3 points)</i> <input checked="" type="checkbox"/> Dog runs/ dog wash station <i>(2 points)</i> <input type="checkbox"/> Work space <i>(2 points)</i> <input checked="" type="checkbox"/> Other – please describe: <i>(up to 3 points)</i> <div style="border: 1px solid black; padding: 5px; margin-top: 5px;"> Bike wash station </div> <p>Does the project provide dedicated space for childcare? (10 points)</p> <p><input type="checkbox"/> Yes</p> <p><input type="checkbox"/> No</p> <p>If yes, is the dedicated space for childcare being operated by a non-profit? (5 points)</p> <p><input type="checkbox"/> Yes</p> <p><input type="checkbox"/> No</p> <p style="text-align: center; background-color: #e0e0e0; padding: 5px;">OR</p> <p>Does the project contribute to the General Community Amenity Contribution Reserve as per the Community Amenity Contribution Policy? (2 points)</p> <p><input type="checkbox"/> Yes</p> <p><input type="checkbox"/> No</p> <p><input type="checkbox"/> N/A <i>(select if amenities are provided on site)</i></p> <p>If yes, what is the \$ amount contributed: _____</p>	<p>Resources</p> <p>Community Amenity Contribution Policy</p> <p>Enforcement</p> <ul style="list-style-type: none"> - Elements on Architectural Plans will be secured through Development Permit. - Elements on Landscape Plans will be subject to securities. - Section 219 Covenant relating to childcare spaces and community + arts and cultural facilities will be required. - Housing related amenities will be included in the Housing Agreement. - Public Art Securities will be applied to any public art amenities. - Parkland contributions to the City will be formalized through the subdivision and parkland dedication process. <p>Staff comments</p> <div style="border: 1px solid black; padding: 5px; margin-top: 5px;"> Applicant is encouraged to review City bylaws and definitions of selected choices here. Some are questionable </div> <p style="text-align: right;">Score 18 /30</p>
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<p>S2 (25 points possible)</p> <p>Does the project provide new purpose-built market rental housing or affordable rental housing or contributes to the city's affordable housing reserve fund in lieu of provision of affordable housing?</p> <p>Check all that apply:</p> <p><input type="checkbox"/> 5% shelter rate housing (up to 25 points)</p> <p><input type="checkbox"/> 15% Affordable rental housing (up to 15 points)</p> <p><input checked="" type="checkbox"/> 20% Purpose-built market rental housing (up to 5 points)</p> <p><input type="checkbox"/> 15% Rent to own (up to 2 points)</p> <p><input type="checkbox"/> Affordable housing fund contribution (1 point)</p> <p><input type="checkbox"/> None (0 points)</p> <p>If none, describe other measures or amenities provided in lieu of provision of affordable housing:</p> <div style="border: 1px solid black; height: 30px; width: 100%;"></div> <p>If purpose-built/affordable rental, provide the following information:</p> <p>Types (e.g., purpose-built or affordable): <u>Purpose-built</u></p> <p>Description (bedroom number breakdown): <u>8-Studio; 21-1B; 12-2B; 7-3B</u></p> <p>% of total housing units: <u>100</u></p> <p>If financial contribution, what is the total amount of dollars dedicated to the City's Affordable Housing Reserve Fund? _____</p> <p>Does this amount exceed the \$2/sqft requirement? (1 point)</p> <p><input type="checkbox"/> Yes</p> <p><input type="checkbox"/> No</p>	<p>Resources</p> <p>Port Moody Affordable Housing Reserve Fund Policy</p> <p>Interim Affordable Housing Guidelines</p> <p>Community Amenity Contribution Policy</p> <p>Enforcement</p> <p>- Commitments will be secured through Housing Agreement and Community Amenity Contribution collection process.</p> <p>Staff comments</p> <div style="border: 1px solid black; height: 150px; width: 100%;"></div> <p style="text-align: right;">Score 5 /25</p>
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S3

(23 points possible)

Does the project provide accessible residential unit(s) and accessible project design features for multi-residential developments beyond City requirements?

Yes

No

If yes, check all the residential unit feature options: (up to 21 points)

(Note: adaptable and accessible units are as defined in the BC Building Code)

- 60% of single storey residential units are adaptable units (1 point)
- 70% of single storey residential units are adaptable units (1 point)
- 80% of single storey residential units are adaptable units (1 point)
- 90% of single storey residential units are adaptable units (1 point)
- 100% of single storey residential units are adaptable units (1 point)
- 10% of single storey residential units are accessible units (2 points)
- 20% of single storey residential units are accessible units (2 points)
- 30% of single storey residential units are accessible units (2 points)
- 40% of single storey residential units are accessible units (2 points)
- 50% of single storey residential units are accessible units (2 points)
- 60% of single storey residential units are accessible units (2 points)
- 70% of single storey residential units are accessible units (2 points)
- 80% of single storey residential units are accessible units (2 points)
- 90% of single storey residential units are accessible units (2 points)
- 100% of single storey residential units are accessible units (2 points)
- Project incorporates adaptable and accessible design features in the site/building circulation and bathrooms in all other uses (1 point)

If no, list any additional accessible features provided that are not already required by the BC Building Code: (up to 2 points)

Examples include:

- Accessible amenity features
- Number of elevators exceeds Building Code requirement
- Automated door opening

Resources

[BC Building Code Accessibility Handbook](#)

Enforcement

- Architectural elements will be secured through the Development Permit and Building Permit.

Staff comments

Score /23

<p>S4 (10 points possible)</p> <p>Does the project include a range of unit sizes for a variety of household types?</p> <p><input checked="" type="checkbox"/> Yes</p> <p><input type="checkbox"/> No</p> <p>If yes: (maximum of 10 points for mixed tenure)</p> <p>For Market Strata projects, does the project meet or exceed the following proportion of bedroom types:</p> <p><input type="checkbox"/> At least 30% of the total project units be 2 and 3-bedroom units (up to 5 points)</p> <p><input type="checkbox"/> At least 10% of the total project units be 3-bedrooms or more (up to 5 Points)</p> <p style="text-align: center;">OR</p> <p>For Market Rental projects, does the project meet or exceed the following proportion of bedroom types:</p> <p><input checked="" type="checkbox"/> At least 25% of the total project units be 2 and 3-bedroom units (up to 5 points)</p> <p><input checked="" type="checkbox"/> At least 5% of the total project units be 3-bedrooms or more (up to 5 Points)</p>	<p>Enforcement</p> <p>- Unit types will be secured through the Housing Agreement.</p> <p>Staff comments</p> <div style="border: 1px solid gray; height: 200px; width: 100%;"></div> <p style="text-align: right;">Score <input type="text" value="10"/> /10</p>
<p>S5 (10 points possible)</p> <p>Does the project contain a rental housing component where the rental units are secured for at least 60 years or the lifespan of the building?</p> <p><input checked="" type="checkbox"/> Yes</p> <p><input type="checkbox"/> No</p> <p>If yes, list the % of units secured for 60 years or the lifespan of the building:</p> <p><u>100</u> (up to 10 points)</p>	<p>Resources</p> <p>Interim affordable housing Policy</p> <p>Enforcement</p> <p>- Commitment will be secured through the Housing Agreement.</p> <p>Staff comments</p> <div style="border: 1px solid gray; height: 200px; width: 100%;"></div> <p style="text-align: right;">Score <input type="text" value="10"/> /10</p>

<p>S6 (10 points possible)</p> <p>Does the project support aging in place? (Refer to Age Friendly Plan recommendations) (i.e., adult care, assisted living space, independent senior living space)</p> <p><input type="checkbox"/> Yes</p> <p><input checked="" type="checkbox"/> No</p> <p><input type="checkbox"/> N/A</p> <p>If yes, list all the supports for aging in place: (up to 10 points) <i>Note: this criterion does not include adaptable and/or accessible units.</i></p> <div style="border: 1px solid black; height: 150px; width: 100%;"></div>	<p>Resources</p> <p>Age Friendly Plan</p> <p>Fraser Health Family Guide to Services for Seniors</p> <p>Enforcement</p> <ul style="list-style-type: none"> - Elements on Architectural Plans will be secured through the Development Permit. - Elements on Landscape Plans will be subject to securities. <p>Staff comments</p> <div style="border: 1px solid black; height: 150px; width: 100%;"></div> <p style="text-align: right;">Score <input type="text" value="0"/> /10</p>
<p>S7 (9 points possible)</p> <p>Does the development include a mix of housing types?</p> <p><input type="checkbox"/> Yes</p> <p><input checked="" type="checkbox"/> No</p> <p>If yes, list the number of units per housing type: (up to 9 points)</p> <ul style="list-style-type: none"> • Live-work units: _____ (3 points) • Ground-oriented units: _____ (3 points) • Lock-off units _____ (3 points) 	<p>Enforcement</p> <ul style="list-style-type: none"> - Elements on Architectural Plans will be secured through Development Permit and Building Permit. - Rental units will be secured through the Housing Agreement. <p>Staff comments</p> <div style="border: 1px solid black; height: 150px; width: 100%;"></div> <p style="text-align: right;">Score <input type="text" value="0"/> /9</p>

<p>S8 (7 points possible)</p>	<p>Resources</p>
<p>Will the project ensure occupants have clean, cool air during times of poor air quality and/or wildfire events beyond Building Code requirements?</p>	<p>Guidance for Cleaner Air Spaces During Wildfire Smoke Events</p>
<p><input checked="" type="checkbox"/> Yes <input type="checkbox"/> No</p>	<p>Guide to Air Cleaners in the Home</p>
<p>If yes, check all that apply: (up to 7 points)</p>	<p>Enforcement</p>
<p><input checked="" type="checkbox"/> Improved mechanical ventilation (e.g., proper commissioning, increase outdoor air intake) <i>(1 point)</i></p>	<p>– Commitment will be secured through Building Permit.</p>
<p><input checked="" type="checkbox"/> Improved air filtration (e.g., HEPA particulate air filtration) <i>(1 point)</i></p>	<p>Staff comments</p>
<p><input checked="" type="checkbox"/> Airtightness better than ACH of 2 <i>(1 point)</i></p>	<p>Applicant was provided scoring earlier for provided selection. However, staff cannot find supporting documentation that supports choices here. this scoring is/ was contingent on ability to provide elements. Scoring will be lost moving forward if nothing is available</p>
<p><input checked="" type="checkbox"/> No indoor combustion appliances (e.g., gas stove or fireplace) <i>(1 point)</i></p>	
<p><input checked="" type="checkbox"/> Homeowner/occupant health and safety information <i>(1 point)</i></p>	
<p><input type="checkbox"/> Other – please describe: <i>(up to 2 points)</i></p>	
<div style="border: 1px solid black; height: 55px; width: 100%;"></div>	<p style="text-align: right;">Score <input type="text" value="5"/> /7</p>

<p>S9 (7 points possible)</p> <p>Does the design of the project help to facilitate mental health, wellness and social connectedness?</p> <p><input checked="" type="checkbox"/> Yes</p> <p><input type="checkbox"/> No</p> <p>If yes:</p> <p>Check all that apply: (up to 7 points)</p> <ul style="list-style-type: none"> <input checked="" type="checkbox"/> Semi-public gathering space with comfortable seating <i>(1 point)</i> <input checked="" type="checkbox"/> All weather recreation areas/wellness space <i>(1 point)</i> <input type="checkbox"/> Pet friendly units / amenities (e.g., dog run) <i>(1 point)</i> <input checked="" type="checkbox"/> Greenspace that facilitates socialization <i>(1 point)</i> <input checked="" type="checkbox"/> Prioritizing pedestrians <i>(1 point)</i> <input checked="" type="checkbox"/> Creative design to promote social interaction <i>(1 point)</i> <input type="checkbox"/> Other – please describe: <i>(up to 2 points)</i> <div style="border: 1px solid black; height: 40px; width: 100%; margin-top: 5px;"></div> <p>Reference to plans (e.g., landscape plans/architectural plans, etc.)</p> <div style="border: 1px solid black; height: 40px; width: 100%; margin-top: 5px;"></div>	<p>Resources</p> <p>Strengthening Neighbourhood Resilience</p> <hr/> <p>Enforcement</p> <ul style="list-style-type: none"> - Elements on Architectural Plans will be secured through the Development Permit. - Elements on Landscape Plans will be subject to securities. - Pet friendly units will be secured through a Section 219 Covenant. <hr/> <p>Staff comments</p> <div style="border: 1px solid black; padding: 5px; margin-top: 5px;"> <p>"All weather recreation areas/wellness space" is questionable.</p> <p>Applicant states "Rooftop amenity and greenhouse provides indoor and outdoor sheltered area." as all weather. Staff disagree</p> </div> <p style="text-align: right;">Score 4 /7</p>
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S10

(6 points possible)

Does the project provide urban vitalization by involving land owner and occupants, community groups, and end user groups who may be affected by the proposal in the planning process to identify and showcase Port Moody's unique assets (i.e. goes above and beyond standard notification and consultation)?

Example: Host a community-building workshop with the neighbourhood at the time of a project's inception to determine values and identify unique assets to leverage through design

Yes

No

If yes:

List all the stakeholders and their involvement: (1 point)

Identify actions taken in response to stakeholder input (up to 5 points)

Resources

[A Guide to Community Revitalization](#)

Enforcement

- Summary of community engagement will be required.

Staff comments

Score /6

<p>S11 (5 points possible)</p> <p>Does the project provide or designate spaces for growing food in private or common areas including on-site secure composting to support gardening activities?</p> <p><input checked="" type="checkbox"/> Yes</p> <p><input type="checkbox"/> No</p> <p><input type="checkbox"/> N/A</p> <p>If yes:</p> <p>Check all that apply: (up to 5 points)</p> <p><input checked="" type="checkbox"/> Community garden (2 points)</p> <p><input type="checkbox"/> Secure on-site community compost (2 point)</p> <p><input checked="" type="checkbox"/> Secure features (e.g., fencing to prevent wildlife access, tool storage etc.) (1 point)</p> <p><input checked="" type="checkbox"/> Other – please describe: (up to 2 points)</p> <div style="border: 1px solid black; padding: 5px; margin-top: 10px;"> <p>- Indoor rooftop greenhouse - Tool storage and access is secured on the rooftop - Every unit also have private balconies for growing food/gardening</p> </div>	<p>Resources</p> <p>City of Vancouver Bulletin: Sustainable Large Development (PDF) <i>Applies to large developments (2+ Acres).</i></p> <p>Enforcement</p> <ul style="list-style-type: none"> - Elements on Architectural Plans will be secured through Development Permit. - Elements on Landscape Plans will be subject to securities. <p>Staff comments</p> <div style="border: 1px solid black; padding: 5px; margin-top: 10px;"> <p>Applicant needs to clarify selected elements. Scoring is conditional</p> </div> <p style="text-align: right;">Score <input type="text" value="5"/> /5</p>
<p>S12 (3 points possible)</p> <p>Will the project undertake any of the following analysis?</p> <p><input checked="" type="checkbox"/> Acoustic analysis (1 point)</p> <p><input type="checkbox"/> Thermal comfort analysis (1 point)</p> <p><input type="checkbox"/> CPTED analysis (1 point)</p>	<p>Enforcement</p> <ul style="list-style-type: none"> - Acoustic analysis identified as a Development Permit application requirement, as appropriate to the project location. - Requirement for Thermal Comfort Analysis would be identified through the rezoning process. <p>Staff comments</p> <div style="border: 1px solid black; padding: 5px; margin-top: 10px;"> <p>Applicant needs to address this. Where is the documentation to support this choice Applicant has stated "To be provided". 0 until done.</p> </div> <p style="text-align: right;">Score <input type="text" value="0"/> /3</p>

<p>S13 (3 points possible)</p> <p>Does the design of the site prevent crime through crime prevention through environmental design principles (CPTED)?</p> <p><input type="checkbox"/> Yes</p> <p><input checked="" type="checkbox"/> No</p> <p>If yes, describe the crime prevention design measures: (up to 3 points)</p> <div style="border: 1px solid black; height: 150px; width: 100%;"></div>	<p>Resources</p> <p>CPTED</p> <p>Enforcement</p> <ul style="list-style-type: none"> - A CPTED analysis is required for submission. - Elements on Architectural Plans will be secured through the Development Permit. - Elements on Landscape Plans will be subject to securities. <p>Staff comments</p> <div style="border: 1px solid black; height: 50px; width: 100%;"></div> <p style="text-align: right;">Score <input type="text" value="0"/> /3</p>
<p>S14 (3 points possible)</p> <p>Will the project allow for pet friendly rental units?</p> <p><input checked="" type="checkbox"/> Yes</p> <p><input type="checkbox"/> No</p> <p>If yes, describe how the project will allow for pet friendly rental units and any other pet friendly details of the project (e.g., dog run, pet wash station etc.): (3 points)</p> <div style="border: 1px solid black; padding: 5px;"> <p>Dog wash station</p> </div>	<p>Resources</p> <p>Pets OK BC</p> <p>Enforcement</p> <ul style="list-style-type: none"> - A Section 219 Covenant related to no prohibition on pet rental for strata developments will be required. <p>Staff comments</p> <div style="border: 1px solid black; padding: 5px;"> <p>Should be 0 based on what question is asking. Dog washing station is only reason for scoring</p> </div> <p style="text-align: right;">Score <input type="text" value="1"/> /3</p>

<p>S15 (2 points possible)</p> <p>Does the development provide diversification by increasing the mix of uses for the particular site and its neighbourhood?</p> <p><input checked="" type="checkbox"/> Yes</p> <p><input type="checkbox"/> No</p> <p>If yes, describe the proposed uses: (up to 2 points for 3 uses)</p> <ul style="list-style-type: none"> • Residential % total floorspace/site area: <u>189%</u> • Commercial % total floorspace/site area: <u>49%</u> • Industrial % total floorspace/site area: <u>0</u> • Institutional % total floorspace/site area: <u>0</u> • Park (note type) % total floorspace/site area: <u>0</u> • Gathering space % total floorspace/site area: <u>44%</u> 	<p>Enforcement</p> <p>- Elements on Architectural Plans will be secured through Development Permit.</p> <p>Staff comments</p> <div style="border: 1px solid gray; height: 100px; width: 100%;"></div> <p style="text-align: right;">Score <input type="text" value="1"/> /2</p>
<p>S16 (2 points possible)</p> <p>Climate change is expected to bring more frequent and intense weather that may result in increased and prolonged power outages. Will this project be designed to provide occupants basic needs amid prolonged power outage and extreme weather? (e.g., back-up power supply, energy independent features)</p> <p><input type="checkbox"/> Yes</p> <p><input checked="" type="checkbox"/> No</p> <p>If yes, list all measures: (up to 2 points)</p> <div style="border: 1px solid gray; height: 200px; width: 100%;"></div>	<p>Enforcement</p> <p>- Elements included in Civil Plans will be secured through the Servicing Agreement.</p> <p>- Energy and mechanical systems will be confirmed through the Building Permit.</p> <p>Staff comments</p> <div style="border: 1px solid gray; height: 200px; width: 100%;"></div> <p style="text-align: right;">Score <input type="text" value="0"/> /2</p>

<p>S17 (2 points possible)</p> <p>Does the project provide education and awareness of the sustainable features of the project for owners/occupants?</p> <p>Examples include:</p> <ul style="list-style-type: none"> • Document is given to new owners at time of sale, covenant on title, inclusion/protection of features in strata bylaws • Signage/display/art recognizing design, etc. <p><input checked="" type="checkbox"/> Yes <input type="checkbox"/> No</p> <p>If yes, list all the education and awareness initiatives: (up to 2 points)</p> <div style="border: 1px solid black; padding: 5px; min-height: 150px;"> <p>- All documents will be given to new owners which shows the sustainable systems been used on this project</p> </div>	<p>Enforcement</p> <ul style="list-style-type: none"> - Written commitment from applicant detailing education and awareness. - Common property features are required to be included in Strata Bylaws. <p>Staff comments</p> <div style="border: 1px solid black; padding: 5px; min-height: 150px;"> <p>Applicant needs to explain how in the text form field to earn scoring</p> </div> <p style="text-align: right;">Score <input type="text" value="0"/> /2</p>
<p>S18 (2 points possible)</p> <p>Is the project design adapted to minimize shadow or privacy impacts to and from adjacent buildings? (1 point)</p> <p><input checked="" type="checkbox"/> Yes <input type="checkbox"/> No <input type="checkbox"/> N/A</p> <p style="text-align: center; background-color: #f0f0f0; padding: 5px;">AND / OR</p> <p>Does the project design integrate the results of a viewscape study with respect to water and mountain views? (1 point)</p> <p><input checked="" type="checkbox"/> Yes <input type="checkbox"/> No <input type="checkbox"/> N/A</p>	<p>Enforcement</p> <ul style="list-style-type: none"> - A shadow/viewscape study is required through the Development Permit. <p>Staff comments</p> <div style="border: 1px solid black; padding: 5px; min-height: 150px;"> <p>Shadow study is available in architectural drawings</p> </div> <p style="text-align: right;">Score <input type="text" value="2"/> /2</p>

<p>S19 (3 points possible)</p> <p>Does your project include any innovative social sustainability aspects not captured?</p> <p><input type="checkbox"/> Yes <input checked="" type="checkbox"/> N/A</p> <p>If yes, please describe: (up to 3 points)</p> <div style="border: 1px solid gray; height: 80px; width: 100%;"></div>	<p>Enforcement</p> <p>- Will depend on the type of innovation, determined by staff.</p> <p>Staff comments</p> <div style="border: 1px solid gray; padding: 5px;">Applicant has selected N/A</div> <p style="text-align: right;">Score <input type="text" value="0"/> /3</p>
<p>S20</p> <p>Does your project face any unique site constraints that limit social sustainability achievement?</p> <p><input type="checkbox"/> Yes <input checked="" type="checkbox"/> No</p> <p>If yes, please explain:</p> <div style="border: 1px solid gray; height: 80px; width: 100%;"></div>	<p>Enforcement</p> <p>- N/A</p> <p>Staff comments</p> <div style="border: 1px solid gray; height: 80px; width: 100%;"></div>

S21

(3 points possible)

Summarize the project’s social sustainability contributions including the performance criteria in this Report Card and additional elements not previously captured here:

This project contributes to social sustainability in multiple ways. It offers voluntary amenities such as space for growing food, child play areas, gathering space, streetscape and pedestrian improvements, and an accessible landscaped roof deck. Additionally, it provides 100% new purpose-built market rental housing, including adaptable and accessible design features in the site/building circulation and bathrooms in all other uses. The project offers a range of unit sizes for various household types, with at least 25% of the total project units being 2 and 3-bedroom units, and at least 5% of the total project units being 3-bedrooms or more. The project also goes beyond the Building Code requirements to ensure that occupants have clean, cool air during times of poor air quality and/or wildfire events. The design of the project aims to facilitate mental health, wellness, and social connectedness, with semi-public gathering spaces, all-weather recreation areas/wellness space, green spaces that facilitate socialization, prioritization of pedestrians, and creative design to promote social interaction. Lastly, the project provides or designates spaces for growing food in common areas, such as a community garden with secure features like fencing and tool storage, to support gardening activities.

Enforcement

- Highlighted in Council reports.

Staff comments

Score /3

Total Social Sustainability Pillar Points = /165

Glossary of Terms

Accessible housing: Housing designed and constructed to be universally accessible to people of diverse ages and abilities.

Adaptable unit: A dwelling unit that provides flexible design features that meet BC Building Code minimum requirements; it can be adapted to meet the changing needs of any occupant for reasons of disability, lack of stamina, and progressing through different life stages to support independent living.

Accessible housing/unit: Housing with fixed design features to enable independent living for persons with disabilities, such as those in wheelchairs.

ACH: Air changes per hour.

Affordable market housing: Housing that is affordable to moderate income households achieved through tenure, location, reduced parking, modesty in unit size, level of finishing, and design and durability over time as the buildings age.

Beautification: The process of making visual improvements appropriate to a specific place, including but not limited to building facades, landscaping, decorative or historic-style street elements, selection of paving/fencing materials and their treatment, etc. Improvements contribute to Port Moody's reputation as City of the Arts in a sustainable manner.

BC Energy Step Code: BC Energy Step Code is a voluntary provincial roadmap that establishes progressive performance targets (i.e., steps) that support market transformation from the current energy-efficiency requirements in the BC Building Code to net zero energy ready buildings.

Brownfield: A term used in urban planning to describe land previously used for industrial purposes or some commercial uses where the expansion, redevelopment, or reuse of the property may be complicated by the potential presence of a hazardous substance, pollutant, or contaminant.

Car/Bike share network: Arrangements between two or more persons to share the use of a vehicle or bicycle for a specified cost and period of time.

Character-defining elements: The materials, forms, location, spatial configurations, uses, and cultural associations or meanings that contribute to the heritage value of a historic place, which must be retained to preserve its heritage value.

Crime Prevention Through Environmental Design (CPTED): The design and effective use of the built environment to reduce the incidence of crime and improve the quality of life.

Coastal Flooding: A flood is a general and temporary inundation of normally dry land areas. When a coastal process—such as waves, tides, storm surge, or heavy rainfall from coastal storms—produces that flood, it is called a coastal flood. Coastal areas, like all areas, can also flood from high rainfall or overflowing streams.

Coefficient of Performance (COP): Is a ratio of useful heating or cooling provided to work (energy) required. Higher COPs equate to higher efficiency, lower energy (power) consumption and thus lower operating costs.

District energy systems: A system that uses renewable energy to pipe energy to buildings within a specified area for space heating, hot water, and air conditioning.

Ecological inventory: An inventory that identifies the ecological values in a natural habitat and is usually the first step in an environmental impact assessment.

Electric vehicle (EV): An automobile that uses one or more electric motors or traction motors for propulsion. An electric vehicle may be powered through a collector system by electricity from off-vehicle sources or may be self-contained with a battery or generator to convert fuel to electricity.

Considered at the July 23, 2024, Regular Council meeting

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Attachment 11

Embodied greenhouse gas emissions: Embodied emissions refers to the greenhouse gas emissions created in various phases of a building or piece of infrastructure's full life cycle (e.g., material extraction, manufacturing, construction, maintenance, and end of life/disposal).

Environmentally Sensitive Areas: Land designated as areas that need special protection because of its environmental attributes, such as rare ecosystems, habitats for species at risk and areas that are easily disturbed by human activities. Refer to Map 13 of OCP.

Greenfield: Undeveloped land in a city or rural area either used for agriculture or landscape design or left to evolve naturally. These areas of land are usually agricultural, or amenity properties being considered for urban development.

Greyfield: Economically obsolescent, out-dated, declining, and/or underutilized land, often with the presence of abundant surface parking.

Greywater: Wastewater from lavatories, showers, sinks, and washing machines that do not contain food wastes and that can be reused for purposes such as irrigation or flushing toilets.

Habitat corridor: Habitat areas, generally consisting of native vegetation, linking with larger areas of similar wildlife habitat. Corridors are critical for the maintenance of ecological processes, providing food, and allowing for the movement of animals and the continuation of viable populations.

Heat island effect: Heat islands form as vegetation is replaced by hard surfaces to accommodate growing populations. These surfaces absorb, rather than reflect, the sun's heat, causing surface temperatures and overall ambient temperatures to rise.

Heritage rehabilitation: The action or process of making possible a continuing or compatible contemporary use of a historic place through repair, alterations, and/or additions while protecting its heritage value.

Heritage restoration: Returning a historic place back to how it looked at any time in its past.

Invasive plant species: An invasive plant is a non-native species whose interaction causes economic harm, harm to human health, and/or environmental harm.

Light pollution: Brightening of the night sky caused by streetlights and other man-made sources, which has a disruptive effect on natural cycles and inhibits the observation of stars and planets.

Market rental housing: market rent is the rent that an apartment, without rent or income restrictions or rent subsidies, would command in the open market considering its location, features, and amenities.

Naturescape planting: Landscaping with species that are naturally adapted to local climate, soils, predators, pollinators, and disease and, once established, require minimal maintenance.

Non-human companion: Means any domestic or feral pet under the care, custody, or ownership of a person.

Non-market rental housing: Subsidized rental housing for those unable to pay market-level rents including, but not limited to, public housing owned and operated by government agencies, non-profit housing owned and operated by public and private non-profit groups, and co-operative housing owned and managed by co-operative associations of the residents.

On-site power generation: The ability to generate power without transporting it from its source to where it can be utilized.

On-site renewable energy generation: The generation of naturally replenished sources of energy, such as solar, wind power, falling water, and geothermal energy.

Considered at the July 23, 2024, Regular Council meeting

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Lock-off suites: Lock-off units are self-contained units which are smaller than the principal dwelling unit. Each unit must have direct access to a hallway, corridor or the outside, and a shared internal door which can be locked enabling both units to be independent.

Low albedo: Albedo is the measure of the reflectivity of a material. A high albedo means it reflects a lot of light and a low albedo means it absorbs a lot of light.

Low Carbon Energy System: Low carbon energy systems (“LCES”) supply heat energy primarily derived from highly efficient and renewable sources in order to provide space heating and conditioned ventilation air for buildings seeking to achieve low greenhouse gas emissions. These systems may also provide domestic hot water and cooling service.

Passive design: An approach to building design that uses the building architecture to minimize energy consumption and improve thermal comfort.

Public space: A social space that is generally open and accessible to people.

R-2000-Certified New Home: Best-in-class, energy-efficient homes with even higher levels of energy efficiency than ENERGY STAR-qualified new homes, as well as clean air and environmental features.

Sea Level Rise: Sea level rise is an increase in the level of the world’s oceans due to the effects of global warming.

Sequestered carbon: a natural or artificial process by which carbon dioxide is removed from the atmosphere and stored.

Smart technology: Technologies that allow sensors, databases, and/or wireless access to collaboratively sense, adapt to, and provide for users within the environment.

Statement of significance: The first essential step in any conservation project, which involves identifying and describing the character-defining elements; it is important in defining the overall heritage value of the historic place. Refer to the Standards and Guidelines for the Conservation of Historic Places in Canada (see Resources glossary).

Streetscape: The visual elements of a street, including the road, adjoining buildings, sidewalks, street furniture, trees, and open spaces that combine to form the street’s character.

Storm water management plan: The management of water occurring as a result of development or precipitation that flows over the surface into a sewer system.

Transit oriented development (TOD): A mixed-use residential and commercial area designed to maximize access to public transportation; it often incorporates features to encourage transit ridership. A TOD neighbourhood typically has a centre with a transit station or stop (train station, metro station, tram stop, or bus stop), surrounded by relatively high-density development with progressively lower-density development spreading outward from the centre. TODs generally are located within a radius of 400 to 800 metres from a transit stop, as this is considered to be an appropriate distance for walkability.

Triangulation: Triangulation is spatial design that gives people a reason to be in the space. In order to promote public interaction, common areas should contain amenities people don’t have in their private residences such as a splash pad or play structure with triangular configuration in mind.

Universal access: This term refers to broad-spectrum ideas meant to produce buildings, products, and environments that are inherently accessible to both people without disabilities and people with disabilities.

Urban infill: An urban planning term that refers to new development that is sited on vacant or undeveloped land within an existing community, and that is enclosed by other types of development.

Urban forest: The total collection of trees and associated plants growing in a city or town. It includes trees in parks and yards, along roadways and paths, and in other areas, both on public and private lands.

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Attachment 11

Urban vitalization: The urban planning process of rehabilitating a place or “taking a place to a higher level” using a community-building process (early stage community involvement) to define the key characteristics that make a place unique or special; and applying the concepts of urban conservation to leverage a community’s assets, most often in accordance with approved City plans.

Viewscape: The natural and built environment that is visible from a viewing point.

Walkability: The extent to which the built environment is friendly to the presence of people living, shopping, visiting, enjoying, or spending time in an area; improvements in walkability lead to health, economic, and environmental benefits.

Xeriscaping: Refers to landscaping and gardening in ways that reduce or eliminate the need for supplemental water from irrigation. Xeriscaping refers to a method of landscape design that minimizes water use.

Considered at the July 23, 2024, Regular Council meeting

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Attachment 12



Considered at the July 23, 2024, Regular Council meeting

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Attachment 12



Considered at the July 23, 2024, Regular Council meeting

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Attachment 12



As metaphor, I chose to represent the vascular anatomy of the leaf for its potency as a renewable energy system of incredible efficiency. Clearly the ability to photosynthesize water, sunlight and CO₂ into stored carbon energy while expiring oxygen to balance the biosphere is a process that enables our survival. The leaf is a biological converter of immense capacity. It feeds us, it keeps us warm and puts gas in our tank!

<https://vimeo.com/417304009>

Considered at the July 23, 2024, Regular Council meeting


847

Attachment 12



These sails catch the breeze and rotate the turbine. I have been testing a model of *Air Leaf Mobile* for the past 4 years. In strong winds the sails self govern by rotating 360 degrees...they perform a delightful dance in the breeze.

<https://vimeo.com/245775671>

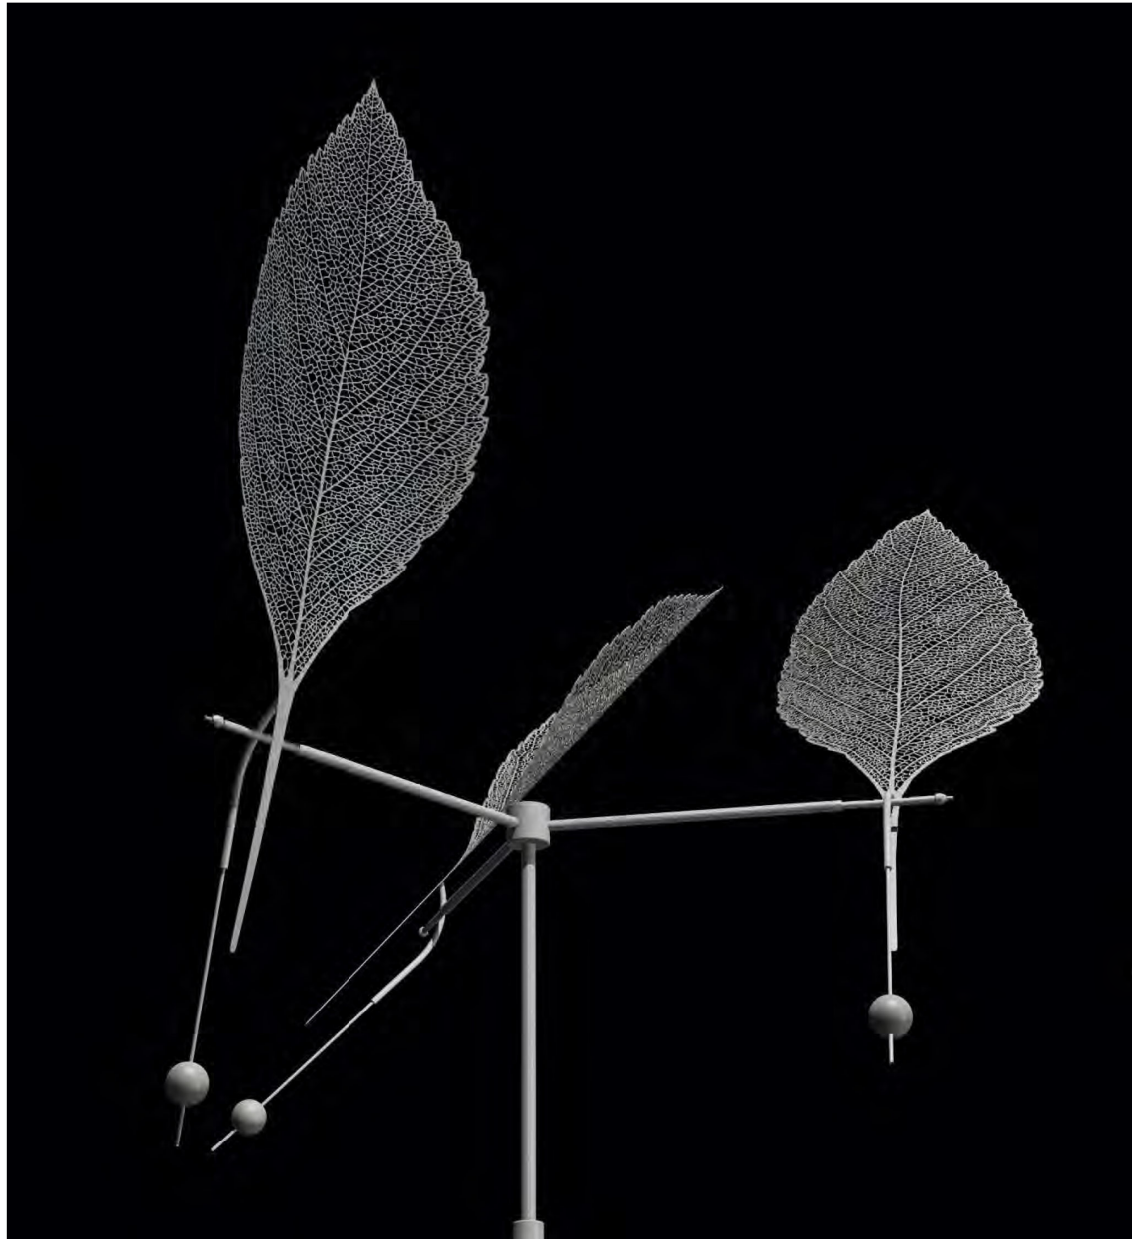

Considered at the July 23, 2024, Regular Council meeting

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Attachment 12





City of Port Moody

Bylaw No. 3472

A Bylaw to close a portion of Queens Street.

WHEREAS pursuant to s. 40 of the *Community Charter*, Council may adopt a bylaw to close a portion of a highway to traffic and remove its dedication as highway;

AND WHEREAS notice of adoption of this Bylaw has been published in accordance with City of Port Moody Public Notice Bylaw, 2023, No. 3430 prior to adoption and Council has provided an opportunity for persons who consider they are affected to make presentations to Council;

NOW THEREFORE, the Council of the City of Port Moody enacts as follows:

1. Citation

- 1.1 This Bylaw may be cited as “City of Port Moody Road Closure Bylaw – Portion of Queens Street, 2024, No. 3472”.

2. Legal Description

- 2.1 That the 216.9m² area shown in heavy black outline and identified as Parcel A on Reference Plan EPP139218, a copy of which is attached hereto as Schedule “A” and forms a part of this Bylaw, is hereby stopped up and closed to traffic of all kinds and the dedication as highway is removed.

3. Authorization

- 3.1 The Mayor and Corporate Officer are hereby authorized to execute all documentation necessary to give effect to the provisions of this Bylaw, including the plan attached hereto.

4. Attachments and Schedules

- 4.1 The following schedules are attached to and form part of this Bylaw:
 - Schedule A – Reference Plan EPP139218.

5. Severability

- 5.1 If a portion of this Bylaw is found invalid by a court, it will be severed, and the remainder of the Bylaw will remain in effect.

Considered at the July 23, 2024, Regular Council meeting

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Attachment 13

Read a first time this ___ day of _____, 2024.

Read a second time this ___ day of _____, 2024.

Read a third time this ___ day of _____, 2024.


Adopted this ___ day of _____, 2024.

M. Lahti
Mayor

S. Lam
City Clerk

I hereby certify that the above is a true copy of Bylaw No. 3472 of the City of Port Moody.

S. Lam
City Clerk

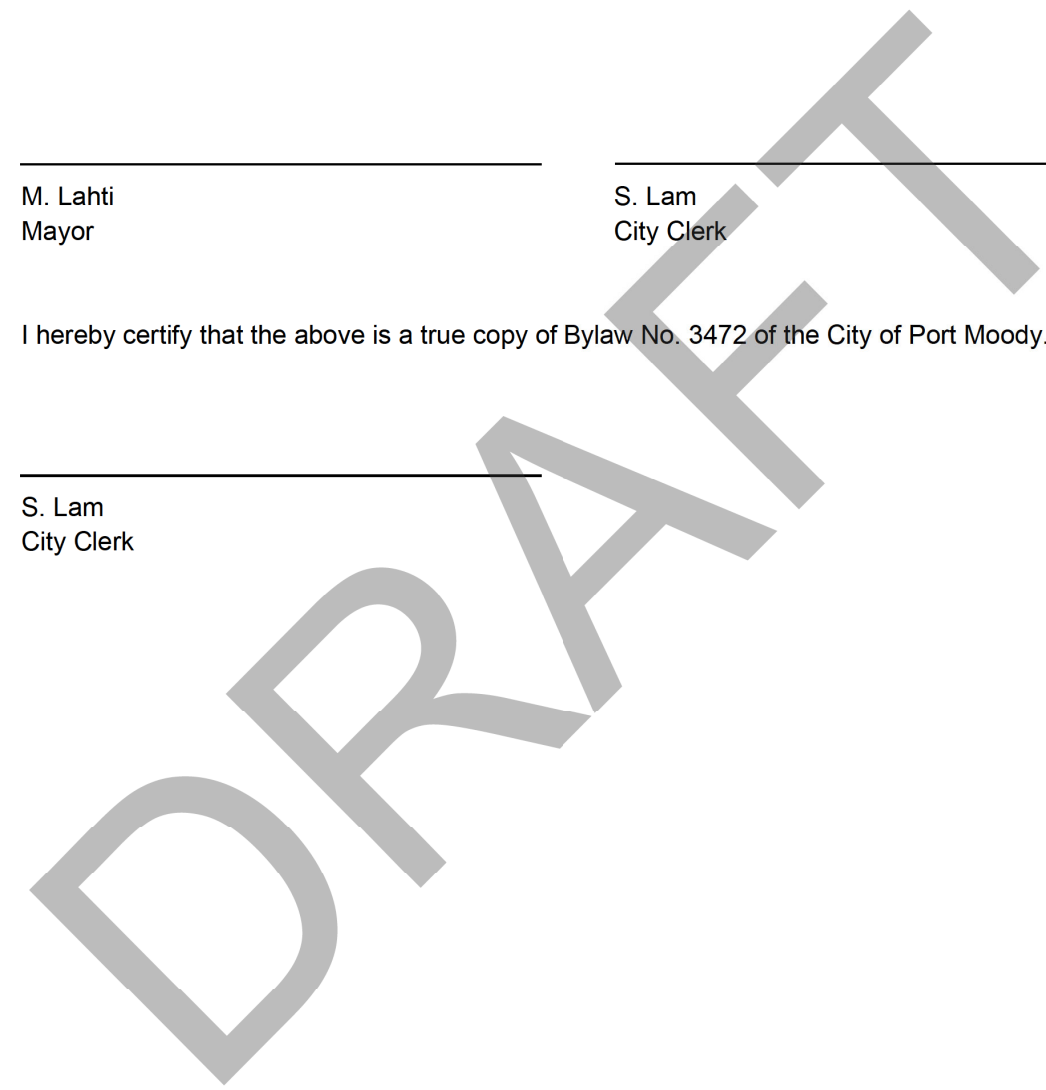


Considered at the July 23, 2024, Regular Council meeting

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Attachment 13

Schedule A to Bylaw No. 3472
Reference Plan EPP139218

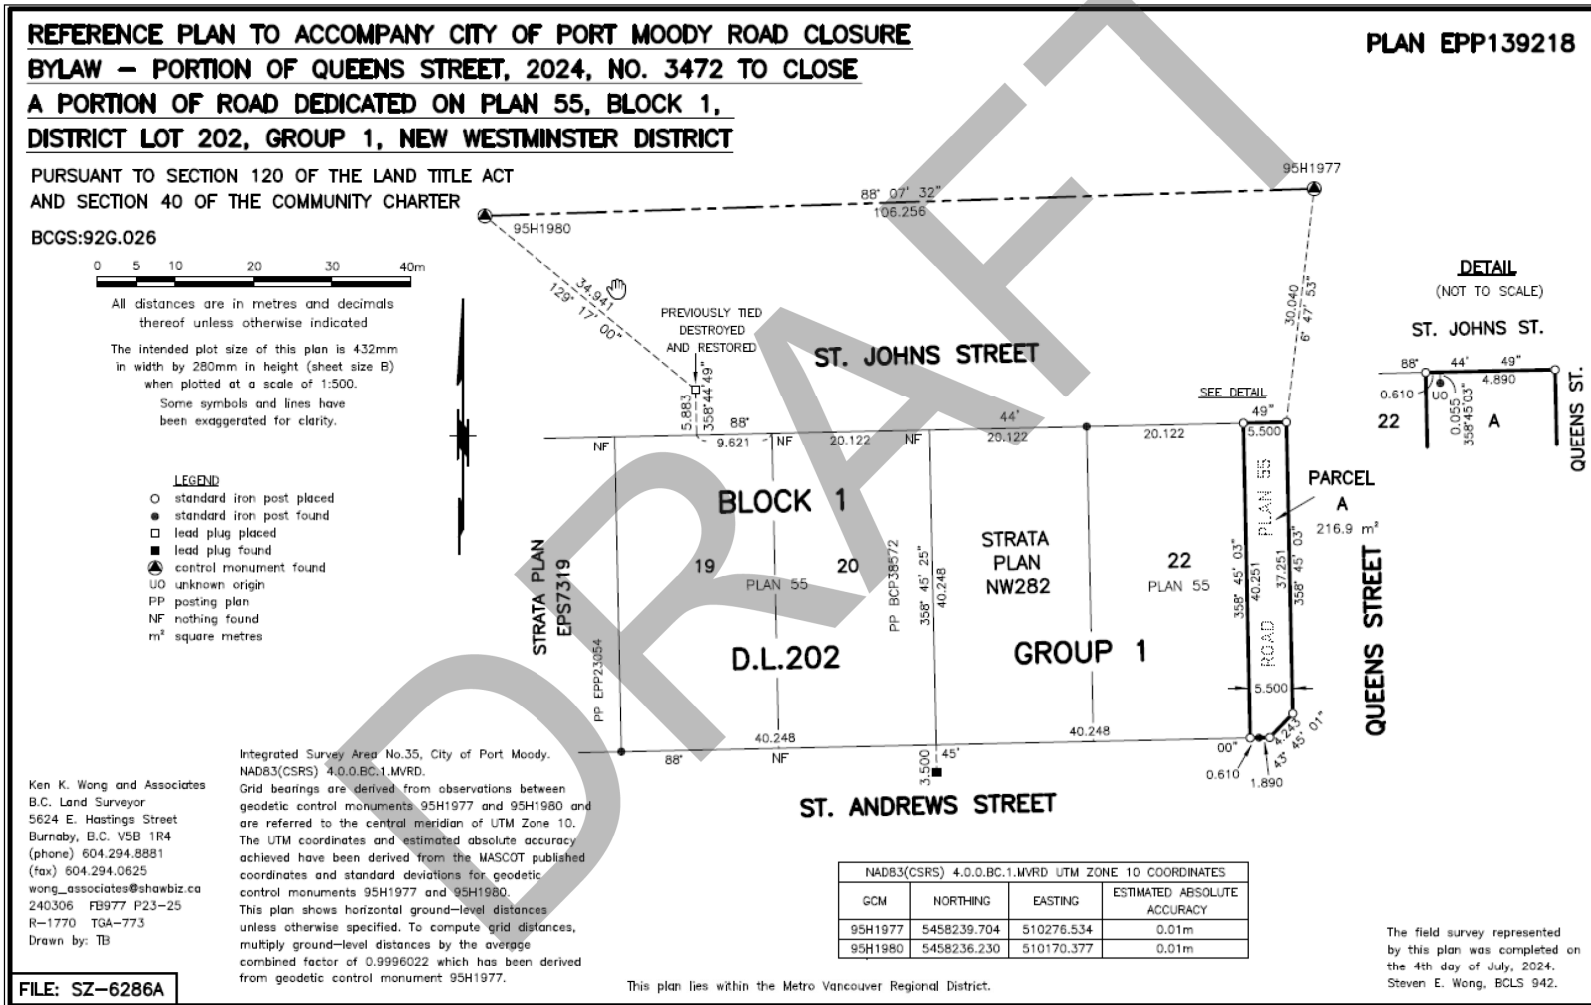

2331–2335 St. Johns St. Development Application

UPDATE 1: Public input received on Engage Port Moody from August 8, 2023 to June 26, 2024

This encompasses the period from the day the project launched on engage.portmoody.ca to the day the report was pulled for Council input. Comments are presented verbatim, including typos and grammatical errors. Profane or abusive language, or personally identifying information has been removed where indicated by “[omitted]”.


Engagement highlights

Highlights of project engagement to date:

- **21 engaged participants** contributed to one or more feedback tools
- **134 informed participants** visited multiple project pages, contributed to a tool, or downloaded documents
- **341 aware visitors** viewed this project page

What is your overall feedback on this development application?

	Support	Oppose	Mixed
From launch until second reading: Aug 8, 2023 to June 26, 2024	14	2	5

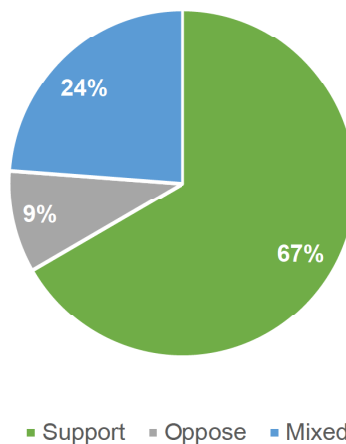

Considered at the July 23, 2024, Regular Council meeting

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Attachment 14

Comments 1 through 13 were included in the first public engagement summary shared with Council at early input

Comments

1. Fully support this development
2. Looks Great and a retail food store is needed for this area.
3. This proposal should be approved as is. It meets the long term vision of OCP and suspect the new OCP will have higher density/stores on St. John's street. The City should consider changing St. Andrews street to one way westbound direction. This would discourage the rat runners that use it when traffic is backed up on St. John's and encourage residents of this development to use future light at elgin. This section of St. Andrew is currently very dangerous for two way traffic due to blind hill and parked cars.
4. Overall I am in favour of this development application. There are a few things I would like to point out:

1) How has the developer and/or the city evaluated how this may impact the traffic flow along St. Andrews Street, in particular from Kyle Street? The street goes through a parking lot for the PoMo Arts Center/Kyle Center and increased traffic will make this area unsafe. Even with the current traffic volume, it can be a bit sketchy walking from the parking lot to the Arts Center. Albeit, this is only during certain times of the day (such as when a class or camp is about to begin or end) it increases the risk for patrons.

2) Accessibility concerns

a) The report shows that there will be 2 disability stalls for the residential building and 1 disability stall for the retail space. Is this enough? With an aging community, there will be more individuals with the needs for disability stalls. Will you be able to add more after the fact? How will this be addressed?

b) The concept drawings of the building from St. Johns' street looks amazing. I understand that there will be stairs so that people can access the store from the street level. Will there be a slope for those with mobility issues or with strollers? Or are these individuals expected to get into the store from the parking lot from which there is direct store access (I understand that it is easy to access the parking lot from the store with a shopping buggy so I am assuming it is accessible). If there is no slope, and individuals with mobility scooters/wheelchairs/strollers are supposed to use the parking lot entrance, is this area going to get busy or congested with shoppers and cars? Will it be safe for them? It just doesn't seem as convenient for them and thus seems like they are an after thought rather being completely inclusive and barrier free for them.

Thank you for taking the time to read this.

5. Love the idea of Bosa moving in and a few cafes what I don't want to see are Canibus stores nor SRO housing I am ok with this provided the structures are not higher than six stories i worry with all this development mountain views will be gone

To add has anyone considered things like an already too busy hospital? With all this development happening with this new council have you considered the fact we already have hospital doctor shortages ?

Considered at the July 23, 2024, Regular Council meeting

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Attachment 14

6. ABSOLUTELY NO WAY SHOULD THIS GO FORWARD, WE ARE EXPLODING AT THE SEAMS AS IT IS. FIX THE INFRASTRUCTURE FIRST!
7. This proposal is exactly the kind of development needed in downtown Port Moody. It addresses the housing shortage in the region by building homes. Moreover, it is walking distance from Moody Centre Station, and adds more retail to the area, allowing people to live car-free or car-light, which is an essential response to the current climate emergency. Including bicycle parking in the proposal is a nice feature.
8. Good addition to this neighbourhood as it needs a grocery store in vicinity. Also like the rental apartments aspect of this development.
9. This area desperately needs a greengrocer, not another boutique drygoods shop that will compete with local european and latin markets. There are many people in this area who need to drive to buy fresh fruit and vegetables, and the inclusion of a greengrocer would make a big positive impact on the area's status as a "fresh food desert".
10. Have you done the math? It already takes 45 minutes to get across from the barnet to the fire station in traffic jams every single day.

Most people drive to work, and hoping people might one day take the train is ridiculous. They all drive to get groceries and other activities. The traffic is already insane.

Please don't make us have to move out of Port Moody because the traffic is worse here than in Toronto.
11. I love the plan and I think it will make Port Moody more lively and attractive.
12. This area is on a busy road near the Skytrain and higher density makes sense here. I would rather higher density here than on the shireline
13. Very much need the grocery store - dislike the cinder block style - slender towers better

Comments 14 through 21 have been received since the first public engagement summary was shared with Council at early input

14. I think this is a great idea commercial space for example grocery / food store etc in this building. Port Moody is down to one real grocery store Thrifty's Very disappointed IGA has moved out
15. This looks great. Appropriately sized in the neighbourhood with a much needed amenity.
16. I think it is an excellent application.

The use is perfect - retail on ground floor and apartments above.

Architecture is nice. Symmetry and balance is appreciated, will improve the streetscape a lot.

Well done!

Considered at the July 23, 2024, Regular Council meeting

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Attachment 14

17. Great to have a grocery store in an area where there has not been previously and greatly needs...however...we do NOT need a specialty shop....We need a proper grocery store where people can WALK to for all grocery needs.
18. I do not think this proposal meets the goals for affordable housing. I like the building design and the mixed-use with commercial on the bottom. However, there are no below-market units included in this building. That is not appropriate and does not fit with what the community needs. Also, the proposed 400 sq ft studios are inappropriately small, that is not a real living space. They have tried to cram too many units into the building.
19. Looks good! Big fan of mixed use development. We need more affordable / non-market housing, though. Also the parking space is excessive.
20. I think that this proposal adds value to the community because it provides access to groceries for people in this area of St. Johns. I also think that it enriches the cultural community by having an ethnic grocery store that focuses on real, fresh foods and not junk food. I like the look of the building. More parking would be my only tweak to this proposal.
21. The area/community desperately needs a grocery store.