LEGAL: PLAN OF SURVEY OF PROPOSED LOT A, FORMERLY STRATAPLAN NW282 AND LOT 22, BLOCK 1, PLAN 55, BOTH OF DISTRICT LOT 202, GROUP 1, NEW WESTMINISTER DISTRICT



MIXED-USE RESIDENTIAL DEVELOPMENT

2331, 2335 ST. JOHNS STREET PID(s): 001-257-706



Name: Benedet Properties (3.55).
Address: 1465 Kootenay Street
Vancouver, BC V5K4Y3
Phone: 604.253.5578 Benedet Properties (St Johns) Ltd

Architectural
Name: Cornerstone Architecture
Address: #307 - 611 Alexander Street
Vancouver, BC V6A1E1
Phone: 604.253.8800
Contact Simon Richards (Architect)
Scott Kennedy (CRP)

Contractor

Contractor
Name: Noble Construction
Address: #200 - 4308 Dawson Street
Burnaby, BC V5C4B6
Phone: 604.294.1012
Contact: Christian Perizzolo

Building Envelope
Name: BC Building Science Ltd.
Address: 61 Bent Court
Naw Westminster, BC V3M0J8
Phone: 604 520,6456
Contact: Farshid Bagheri

Surveyor
Name: Ken K. Wong & Associates
Address: 5824 E. Hastlings Street
Burnaby BC V58 TR4
Phone: 604.294.8881
Project#: T6A-773
Contact: Sieve Wong

Civil
Name: MPT Engineering Co. Ltd.
Address: #320 - 11120 Horseshoe Way
Rchmond, BC V7A5H7
Phone: 604.270.9331
Contact: Al Gerrebos

Geotechnical
Name: Geopacific Consultants Ltd
Address: 1779 W. 75th Ave
Vancouver, BC V6P6P2
Contact: Wyatt Johnson

Landscape
Name: Prospect & Refuge
Address: 102-1661 W 2nd Ave.
Vancouver, BC V6J1H3
Project#: 2023-10
Contact: Samantha Hunt-Weeks

Name: Weiler Smith Bowers
Address: 118-3855 Henning Dr.
Burnaby, BC V5C6N3
Phone: 604.294.3753
Contact: Jeff Bugg

Name: Rocky Point Engeineering Address: #208 - 20171 92A Ave Langley, BC V1M3A5 Phone: 604388.7779 Contact: Richard Corra

Fire Suppression Name: Address: Phone: Project#: Contact:

Electrical Name: Address: Project#: Contact:

CORNERSTONE architecture

www.cornerarch.com tol. 604-253-8800

Prior to commencement of the Work, it is the Contractor responsibility to review and verify drawing dimensions, datums and levels. Discrepancies between information this drawing and actual site conditions and / or the remaining Contract Document shall be brought to the attention of the Architect for clarification prior to proceed with the Work. DO NOT SCALE THE DRAWINGS.

rawing List:	
0.0	Cover / Statistics
1.0	Site Plan
1.1	Building Survey
2.1	Lovel 1
22	Level 1 Mezzanire
2.3	Level 2 Parking Level 3
	Level 4
2.0	Level 5
2.6	Level 6
2.8	Boof
2.9	Upper Roof
3.1	North Elevation
3.2	East Elevation
3.3	South Elevation
3.4	West Elevation
4.1	Building SectionA
4.2	Building Section B
4.3	Building Section C
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4.5	Building Section E
4.6	Building Section F Building Section G
4.8	Section Context G
5.1	Shadow Analysis
5.2	Level 1 Code
5.3	Level 1 Mezzanne Code
5.4	Level 2 Code
5.5	Level 3 Code
5.6	Level 4 Code
5.7	Level 5 Code
5.8	Level 6 Code
5.9	Roof Code
5.10	Section Code
6.0 6.1	Material Board
6.2	Site Photos
6.3	Perspective view
6.4	Perspective view
	Perspective view
6.6	Perspective view

3 2023-04-19 Issue for Review 2 2022-11-07 Issue for Preliminary DP Application
1 2022-08-05 Issue to: Review Num. YY MM DD ▲ISSUE / REVISION▼

PROJECT	
Bosa Foods	
2335 St Johns St	

BUILDING CODE BCBC 2018 ZONING DEVELOPMENT PERMIT # BUILDING PERMIT #

DRAWING Cover Sheet and Statistics

DRAWING NO


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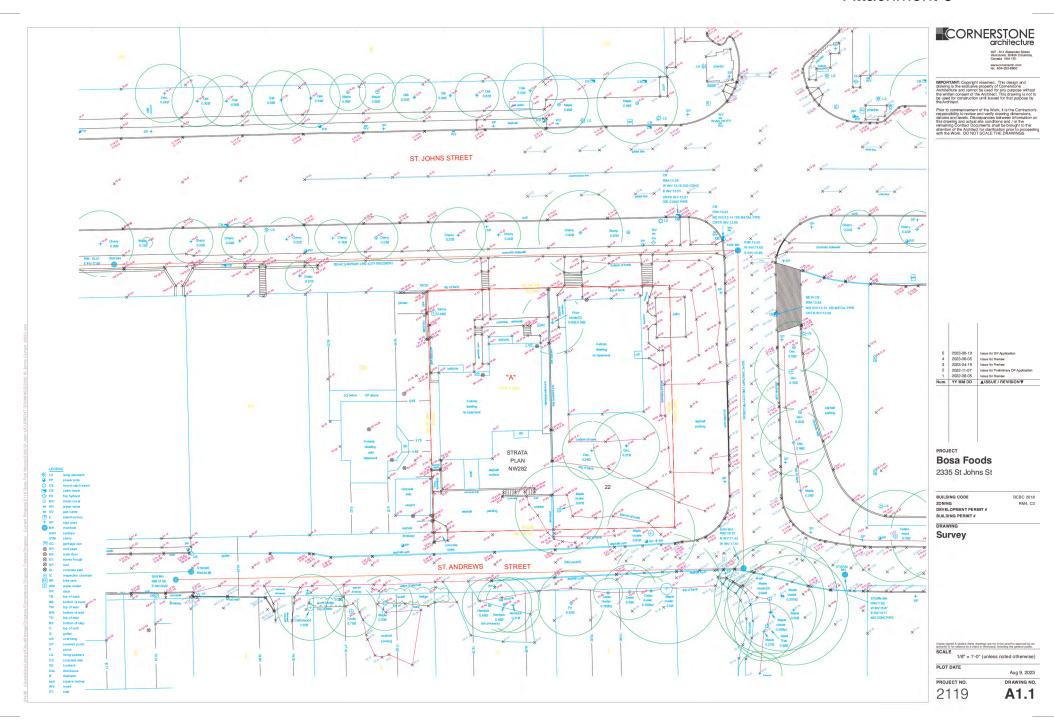
2119 A0.0


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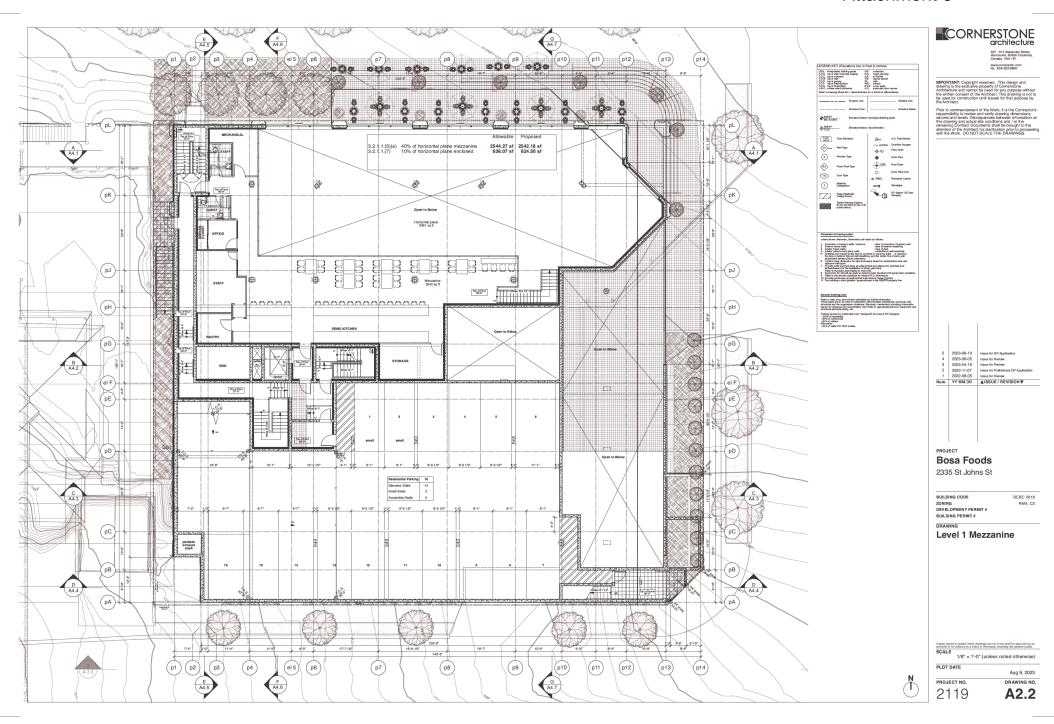
0:1- 01		
Site Contour		
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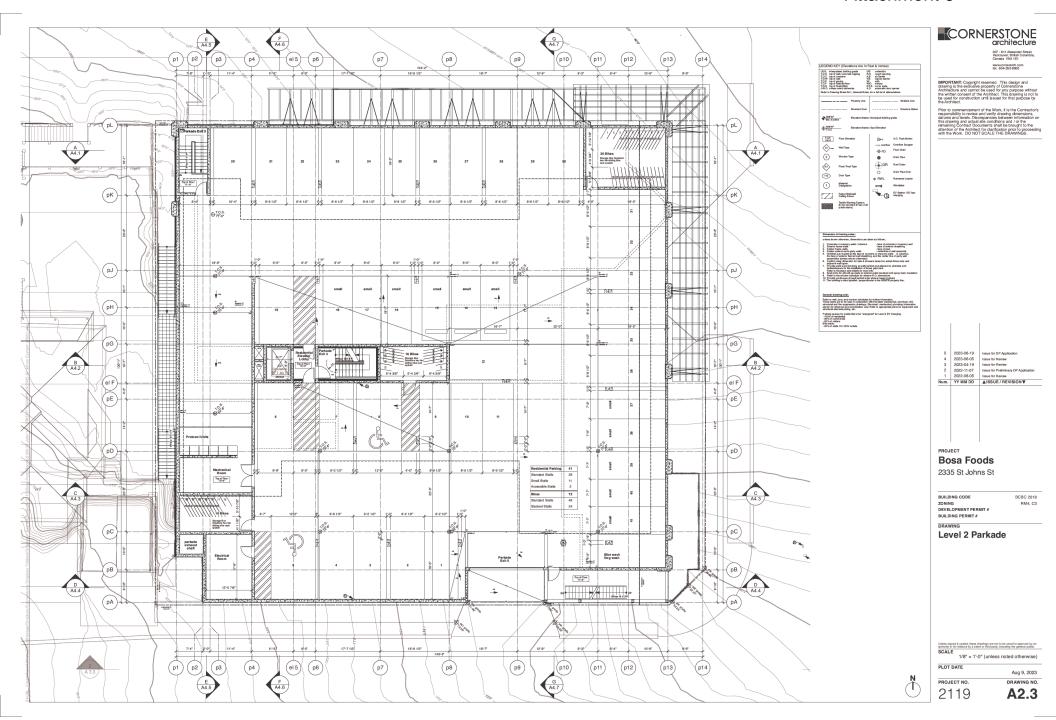
Martin M	Uni Count	77	18							Accessible	Accessible	
Martin M							Vehicles				Provided	
Mary							Residential				2	
Substitution Subs	1 Bed Adaptable	20	42%				Visitor	10	0			6.8.2-0.2 visitor per 100 units, 0.1 after
Part	2 Bed	12	25%				Total	80	79	3	3	6.4.1-3 accessible for 75-124 total stalls
Teal							Dikas	Doguland	Drawledged			Mates
Table Part												
Total Part			50%				Short term					6.10.3- € spaces per 50 Dwelling units
							5.3.4.(b)(iii)	5.3.4.(b)(vi)	5.3.4.(b)(v)	5.3.4.(b)(i)	5.3.4.(b)(viii	
Cent Commercial Commercia												
Company Comp		% of gross	100.0%	17.2%	67.2%	15.5%	2.0%	0.5%	2.5%		0.4%	93.7%
Comparison	Level 1 Conmercial	Unit type	Area (sqft)	Commercia	Residential	Common	Wall exclusion	Garbage exclusion	Amenity	Adaptable exclusion	HRV	1
Dept		Circulation		17								
Methanical Common	G1		299.85	6939.27				299.85				
Montanical Boar Foods 194.21 194.11 19	Level 1 Mezzanine	Unit type	Area (sqft)	Commercial	Residential	Common	Wall					
Part		Circulation	1419.56	45		1419.56						
Petrol	Mezzanine	Bosa Foods										
		Bosa Foods	77.92	77.92								
	Level 2 Parcade	Unit type	Area (sqft)	Commercia	Residential	Common	Wall exclusion					
Start Application	C2	Circulation	370.86			370.86						
Social				Commercial		Common	exclusion					
Tele Adaptable Common Co	302	Studio	400.00		400.00))	7.22			0.00	5.00	
1866 Alapsible 720.66 72	303	1 Bed Adaptable	621.16		621.16		11.38			21.53	5.00	
1866 Alapsible 720.56 72	304 305	1 Bed Adaptable Studio	621.16		621.16 401.23		11.38 6.81			21.53	5.00	
100 2 Bed Aspipable 991-36 99	306	1 Bed Adaptable	726 56		726.56		17.77			21.53	5.00	
1866 Alapstolic 744-25	307	2 Bed	991.07		991.07		34.80			0.00	5.00	
1	309	1 Bed Adaptable	734.25		734.25		22.47			21.53	5.00)
	310	1 Bed	730.20		730.20					0.00	5.00	
Test Common Test Common Test Tes	311	1 Bed Adaptable 2 Red	621.81		621.81		13.06			21.53		
			1368.52		1093.60	1368.52	7.37				5.00	,
400			1	Commercia		Common						
Head Adaptable General Head Adaptable General	401	3 Bed Adaptable	1146.69		1146.69		39.56			21.53	5.00	
401 22	403		400.00 621 16		400.00 621 16		11.38			21.53	5.00	
1 Bot Adaptable 725.89 7	404	1 Bed Adaptable	621.16		621.16							
407 2 Bool 980.06 980.06 980.06 940.07 94	405	Studio	401.22		401.22		6.81			0.00	5.00	
408	406	2 Bad	989 06		989.06		34.80			0.00	5.00	,
409 1 Bed Adaptable 729 A7 729	408	2 Bed	989.36		989.36		34.78			0.00	5.00	5
Art 1 Bed Anaptable 615.84 61	409	1 Bed Adaptable	729.47		729.47		22.47			21.53	5.00	
Area 1972												
Common	412	3 Bed	1378.36				52.51			0.00	5.00	5
Standard	C4	Circulation	960.00			960.00	0.00					
				Commercial			exclusion					
100 100		3 Bed Adaptable	1146.69		1146.69						5.00	
Section Sect	503	1 Bed Adaptable	621.16		621.16		11.38			21.53	5.00	
	504	1 Bed Adaptable	621.16		621.16		11.38			21.53	5.00	
507 2 Bed	505											
Second Company Compa	507	2 Bed	989.06		989.06		34.80			0.00	5.00	
Second S	508	2 Bed	989.08		989.08		34.78			0.00	5.00	
1	510	2 Bed	864.03		864.03		16.65			0.00	5.00	
Comparison Com	511	1 Bed Adaptable	615.84		615.84		13.06			21.53	5.00)
601 3 Bed Adaptable 1146.69 1146.69 39.66 21.53 5.00		3 Bed Circulation	1378.36 960.00		1378.36	960.00					5.00)
601 3 Bed Adaptable 1146.69 1146.69 39.66 21.53 5.00	Level 6 Residential	Unit type	Area (sqft)	Commercia	Residential	Common	Wall			Adaptable	HRV	, n
603 1 Red Asignable 621 16 621 16 11 38 2 1.53 5.00 665 5 804 665 5 804 665 5 804 665 6 804 6 80	601	3 Bed Adaptable	1146.69		1146.69		39.56			21.53	5.00)
604 1 Bed-Adappable 62.1 6 621.16 11.36 21.53 5.00 655 3.	602	Studio 1 Red Adentable	400.00		400.00		7.22			0.00		
605 Studio 401.14 401.14 6.81 0.00 5.00 606 Blad Adaptable 728.33 728.23 17.77 21.53 5.00 607 2 Back 991.07 991.07 34.80 0.00 5.00 609 1 Berl Adaptable 728.59 738.59 22.47 21.53 5.00 610 2 Berl 844.05 884.05 16.65 0.00 5.00 611 Black Adaptable 615.34 615.84 13.06 22.13 5.00 612 3 Berl 1378.36 1378.36 32.1 0.00 5.00 CG Crisition 960.08 960.08 0.00 0.00 0.00	604	1 Bed Adaptable	621.16		621.16		11.38			21.53	5.00	
607 2 Bed 91.07 991.07 34.90	605	Studio	401.14		401.14		6.81			0.00	5.00	
608 2 Bed 986.97 34.78 0.00 5.00 609 1 Bed Adaptable 735.59 735.59 22.47 21.53 5.00 610 2 Bed Adaptable 894.05 684.05 16.65 0.00 5.00 611 1 Bed Adaptable 615.34 615.84 13.06 21.53 5.00 612 3 Bed Adaptable 1376.98 32.21 0.00 5.00 C6 Circulation 960.08 960.08 9.00 0.00 0.00	606	1 Bed Adaptable	726.33		726.33		17.77			21.53	5.00	
608 1 Bed-Marphibe 758.59 738.59 22.47 21.53 5.00 1 1 1 1 1 1 1 1 1 1 1 1 1 1 1 1 1 1	608	2 Bed			986.97					0.00	5.00	S
610 2 Bed Adaptable 615.46 615.65 10.65 0.00 5.00 612 2 Bed Adaptable 615.48 615.48 13.06 22.1.33 5.00 62.2 3 Bed C 1573.58 1376.36 12.2 0.00 5.00 62.00 62.00 60.	609	1 Bed Adaptable	736,59		736.59		22.47			21.53	5.00)
612 3 Bed 1378.36 1378.36 52.51 0.00 5.00 C6 Circulation 960.08 960.08 0.00 0.00												
	612	3 Bed	1378.36				52.51			0.00		
Roof Unit type Area (sqft) Commercial Residential Common Wall Gerbage Amenity Adaptable HRV Residential common exclusion exclusion exclusion exclusion		Circulation	960.08			960.08						
	Roof Residential	Unit type	Area (sqft)	Commercial	Residential	Common	Wall exclusion	Garbage	Amenity	Adaptable exclusion	HRV exclusio	n










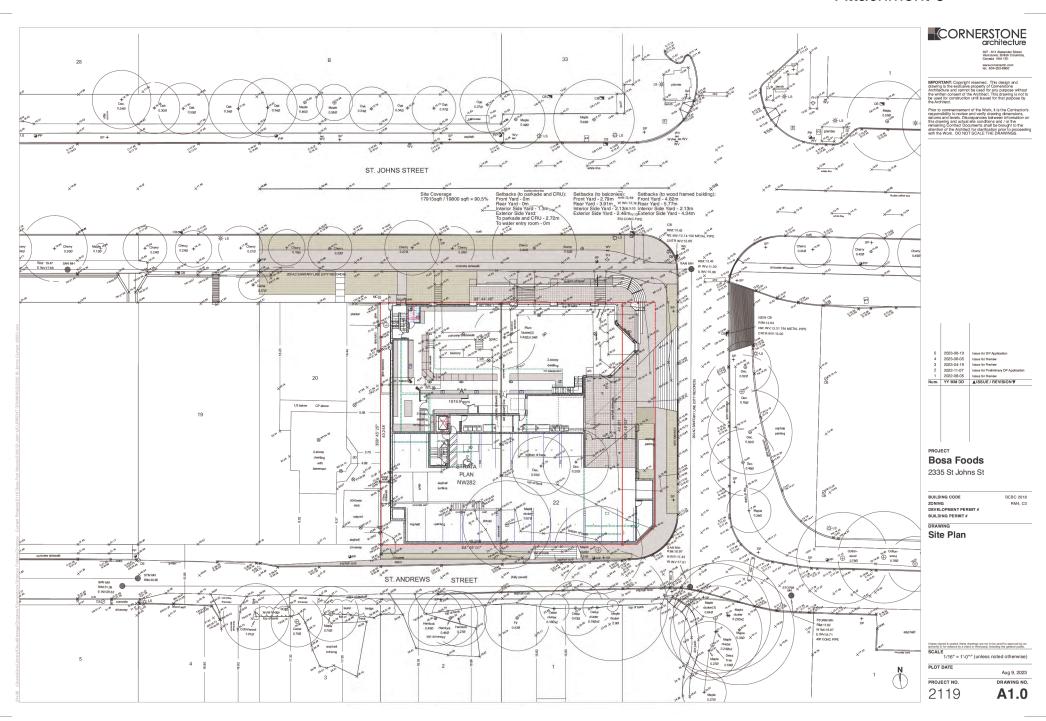


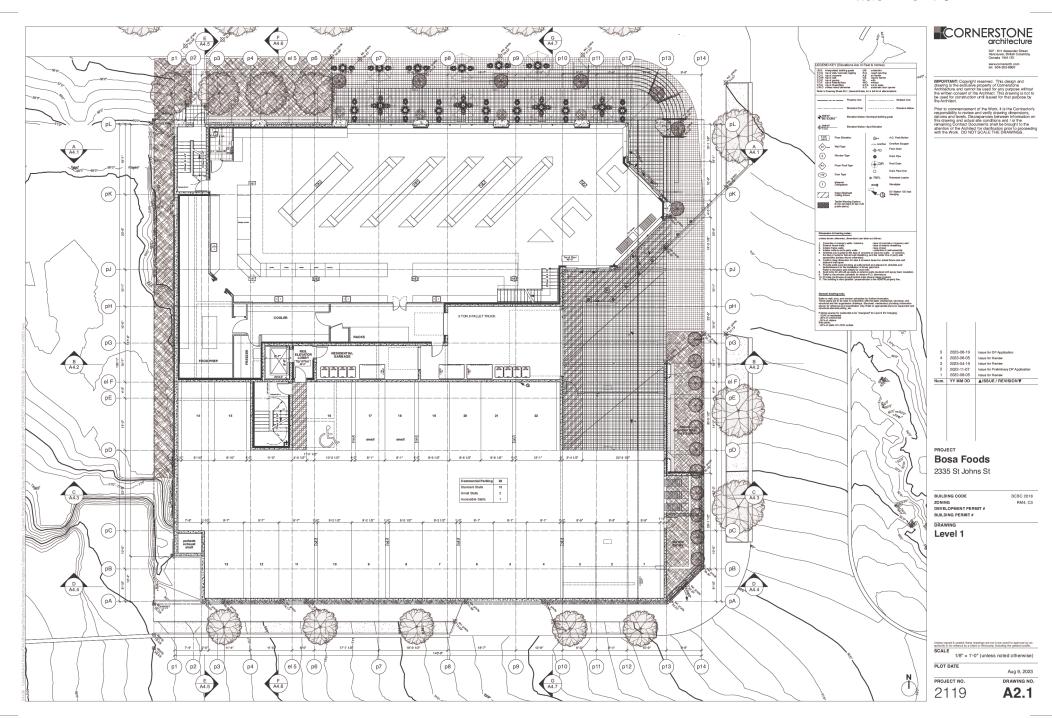


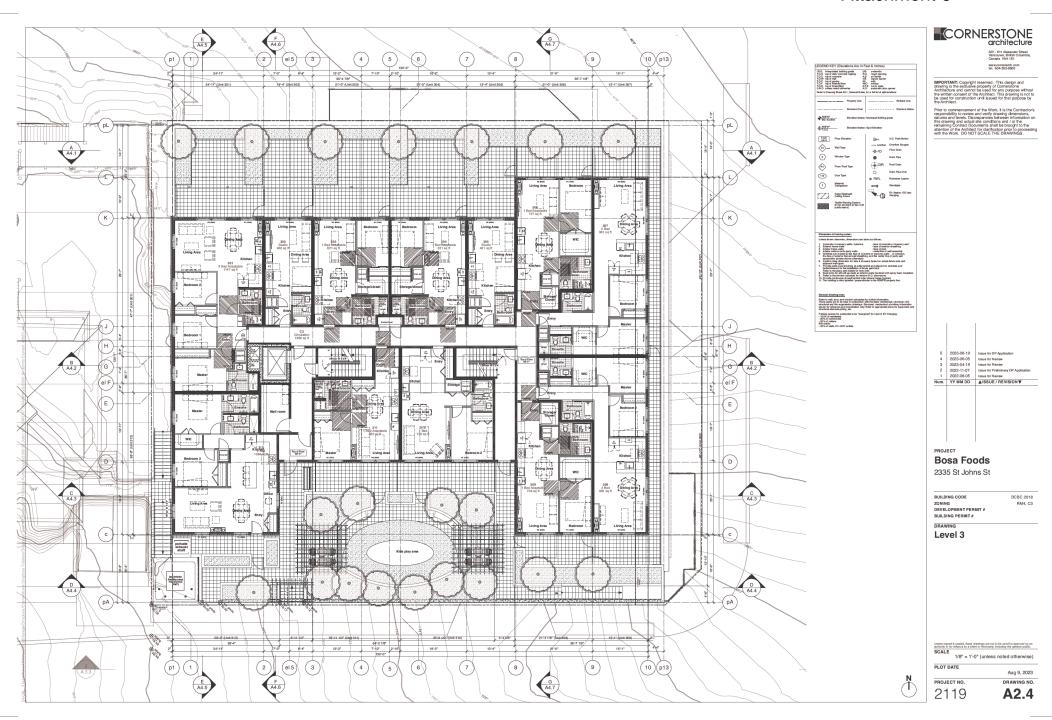


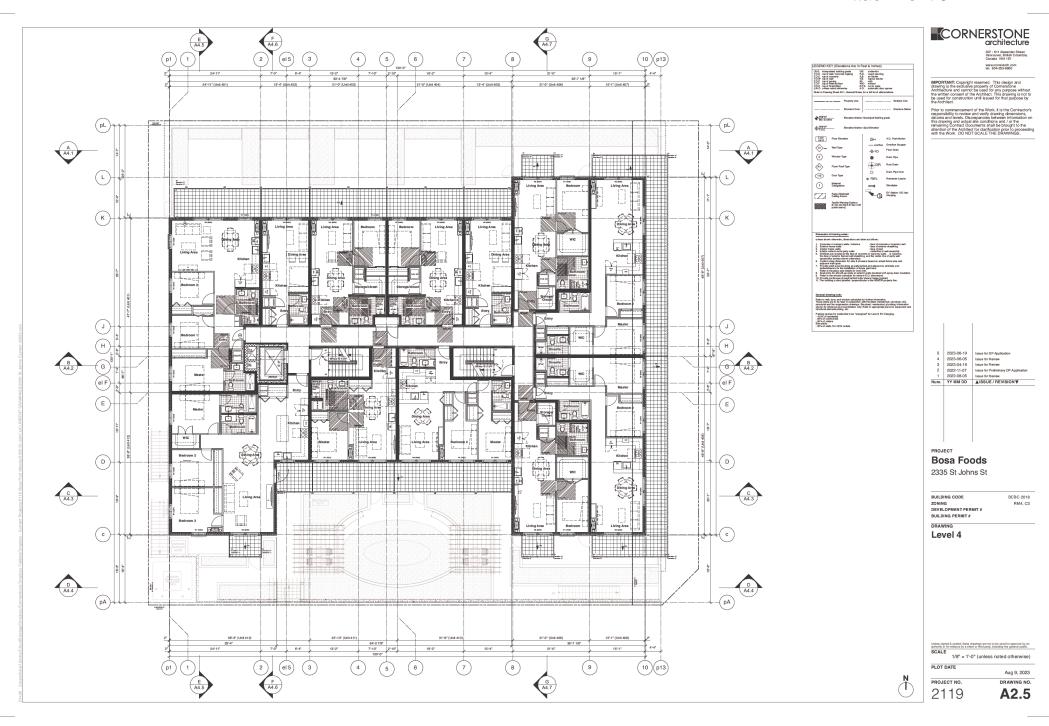


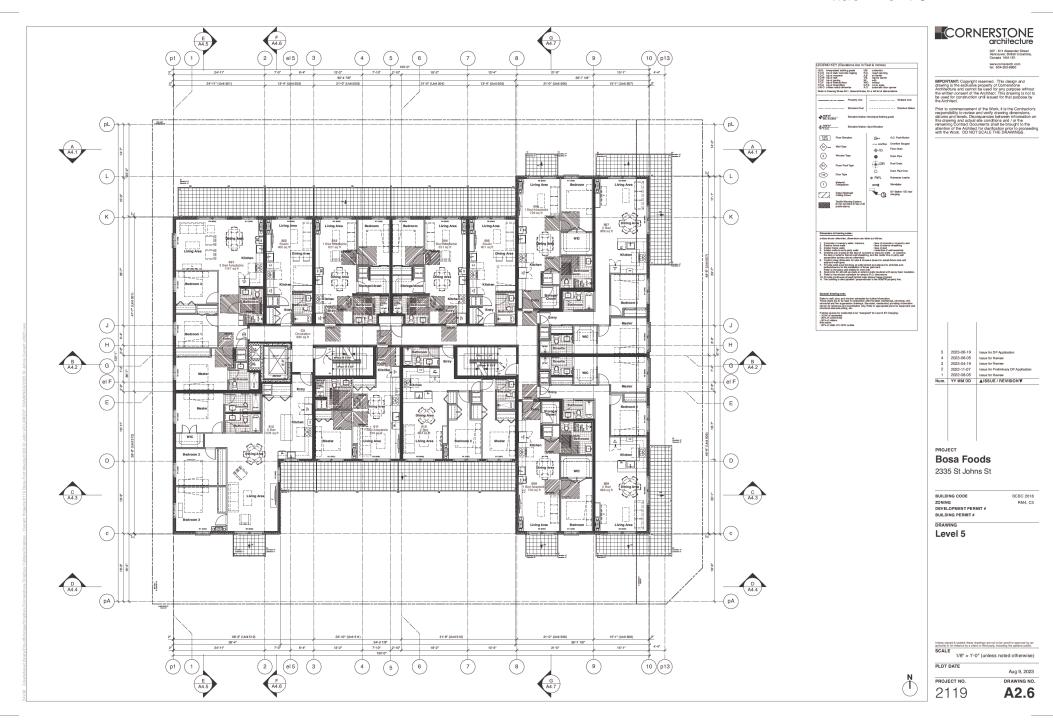

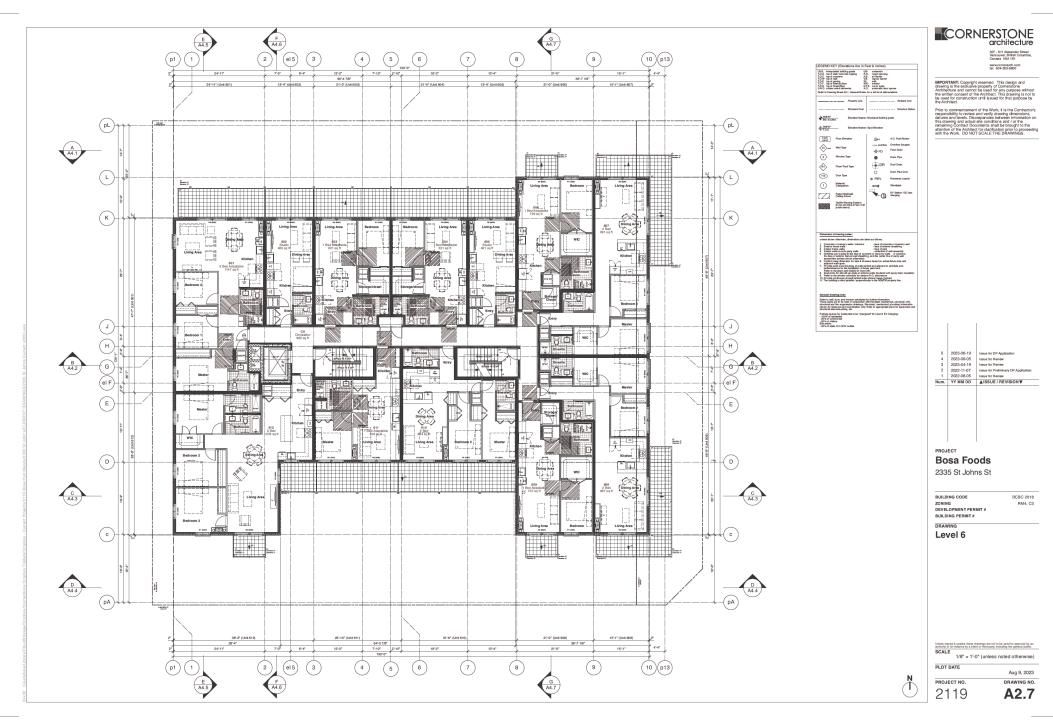

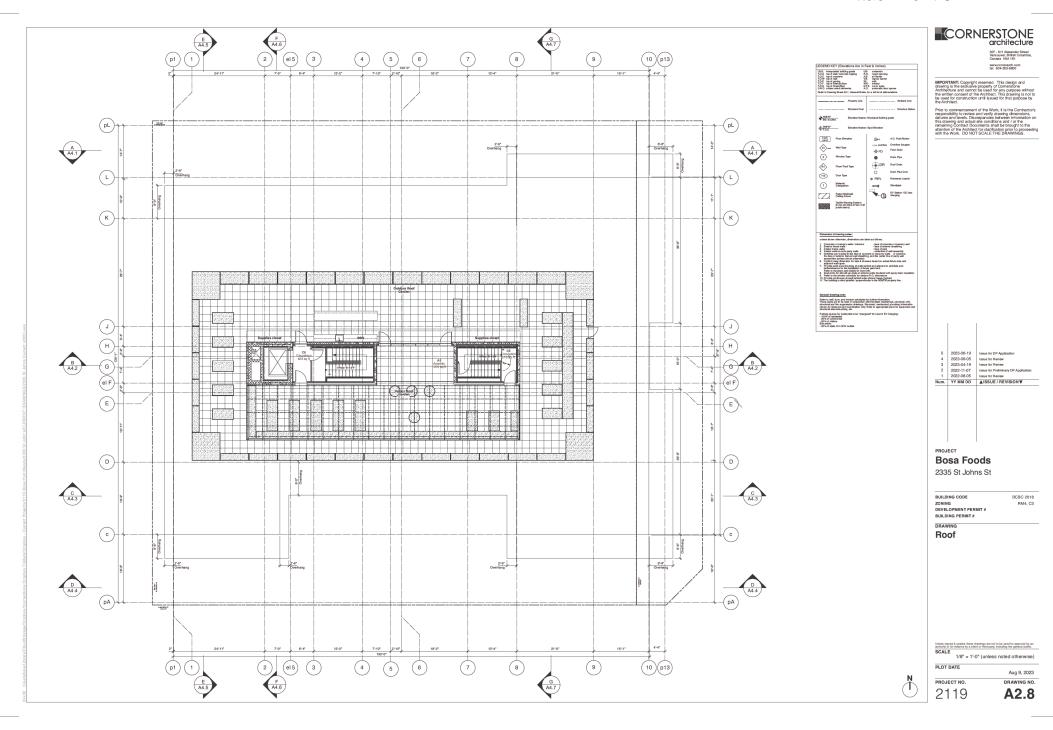

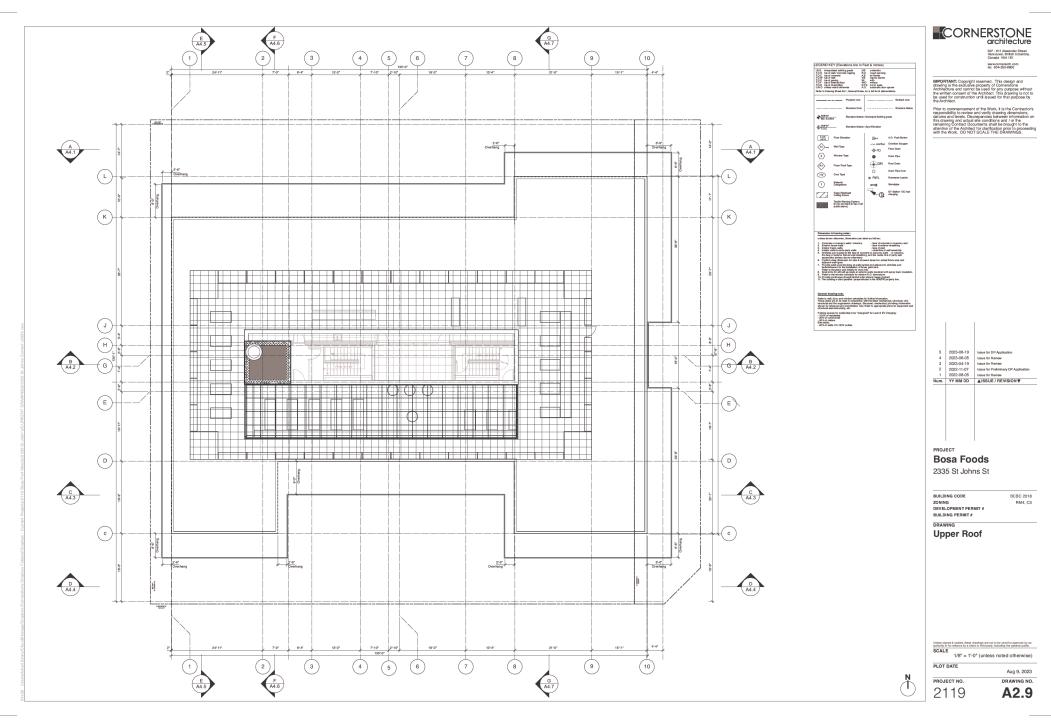

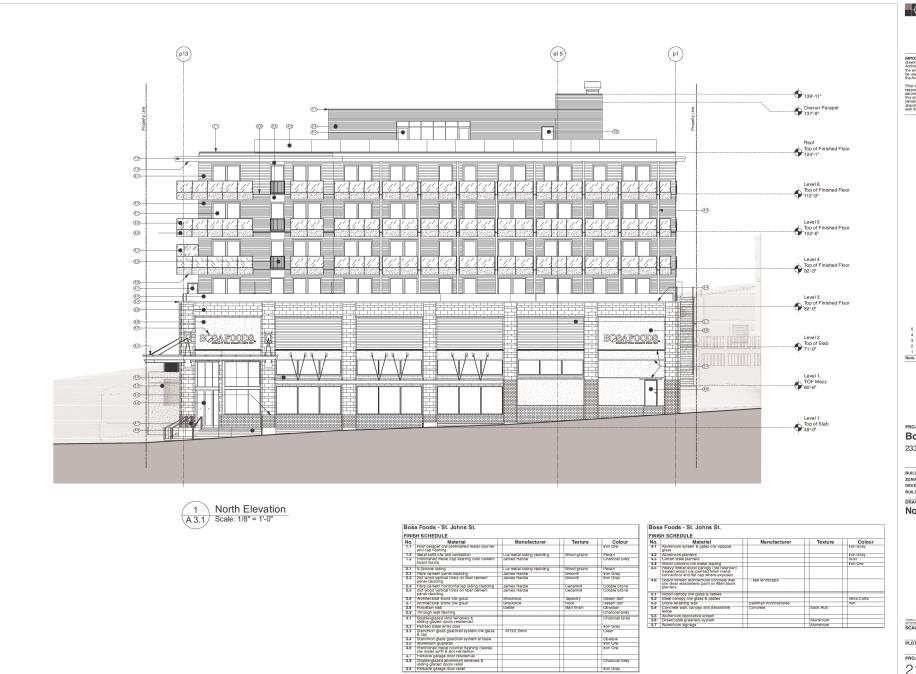

Iron Gray

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PROJECT Bosa Foods 2335 St Johns St

BUILDING CODE

BUILDING PERMIT#

DRAWING

North Elevation

Unless signed & sealed, these drawings are not to be used for approval by an authority or for reliance by a client or third park, including the general public.

SCALE

1/8" = 1'-0" (unless noted otherwise)

PROJECT NO. DRAWING NO

2119

A3.1

BCBC 2018



1 East Elevation A 3.2 Scale: 1/8" = 1'-0"

No.	Material	Г	Manufacturer	Т	Texture	Color
1.1	Roof parapet c/w prefinished metal counter and cap flashing	t		t		Iron Ore
1.2	Metal soffit c/w slot ventialtion	H	Lux metal siding cladding	+	Wood grains	Pecan
1.3	Prefinished metal cap flashing over cement board fascia	Ī	James Harcie	T		Charcoal Gr
2.1	V-Groove siding	F	Lux metal siding cladding	Ŧ	Wood grains	Pecan
2.2	Fibre cement panel cladding	H	James Hardie	+	Smooth	Iron Gray
2.3	2x2 wood vertical trims on fiber cement panel cladding		James Hardie	T	Smooth	Iron Gray
2.4	Fibre cement horizontal lap siding cladding	H	James Harcie	+	Cedarmill	Cobble Stor
2.5	2x2 wood vertical trims on fiber cement panel cladding		James Hardie	Т	Cedarmill	Cobble Stor
2.6	Architectural stone c/w graut	H	Shouldice	+	Tapestry	Desert Buff
2.7	Architectural stone c/w graut	H	Shouldice	+	HOCK	Desert Buff
2.8	Porcelain slab	H	Daltile	+	Matt finish	Obsidian
2.9	Through wall flashing					Charcoal Gr
3.1	Double-glazed vinyl windows & sliding-glazed doors residential			T		Charcoar Gr
3.2	Painted Steel entry door	H		+		Iron Gray
3.3	Stanchion glass guardrail system c/w glass & cap	T	AFGD 5mm	T		Clear
3.4	Stanchion glass guardrail system at base	T				Opaque
3.5	Aluminium guardrail	H		+		Iron Ore
3.6	Prefinished metal counter flashing (fascia) c/w metal soffit & slot ventialtion			Т		Iron Ore
3.7	Parkade garage door residential	Т		1		
3.8	Double-glazed aluminium windows & sliding-glazed doors retail	T		T		Charcoal Gr
3.9	Parkade garage door retail	т		1		Iron Gray

	H SCHEDULE	_					
No.	Material		Manufacturer		Texture		Colour
4.1	Aluminium screen & gates c/w opaque glass	Г				Т	Iron Gray
4.2	Aluminium planters	Т					Iron Gray
4.3	Corten steel planters	т					Hust
4.4	Wood columns c/w metal clading	т					Iron Ore
4.5	Heavy timber wood canopy (fire retardant treated wood) c/w painted finish metal connectors and flat cap where exposed					T	
4.6	Soard formed architectural concrete wall c/w clear elastomeric paint or Allen block planters		- see landscape			T	
5.1	Wood canopy c'w class & caples	-					
5.2	Steel canopy c/w glass & cables	Н		_		+	Terra Cotta
5.3	Stone retaining wall	+	Barkman Architextures			_	Ash
5.4	Concrete wall, canopy and decorative ledge	T	Concrete		Sack Hub	Т	
5.5	Aluminium decorative screen	т					
5.6	Greencable greenery system	т		-	Aluminium	_	
5.7	Aluminium signage	+		_	Aluminium	-	

CORNERSTONE architecture

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PROJECT **Bosa Foods** 2335 St Johns St

BUILDING CODE ZONING DEVELOPMENT PERMIT # BUILDING PERMIT #

DRAWING

East Elevation

Unless signed is sealed, these drawings are not to be used for approval by an authority or for reliance by a client or third party, including the general public.

SCALE

1/8" = 1'-0" (unless noted otherwise)


PLOT DATE

PROJECT NO. DRAWING NO.

2119

A3.2

BCBC 2018 RM4, C3

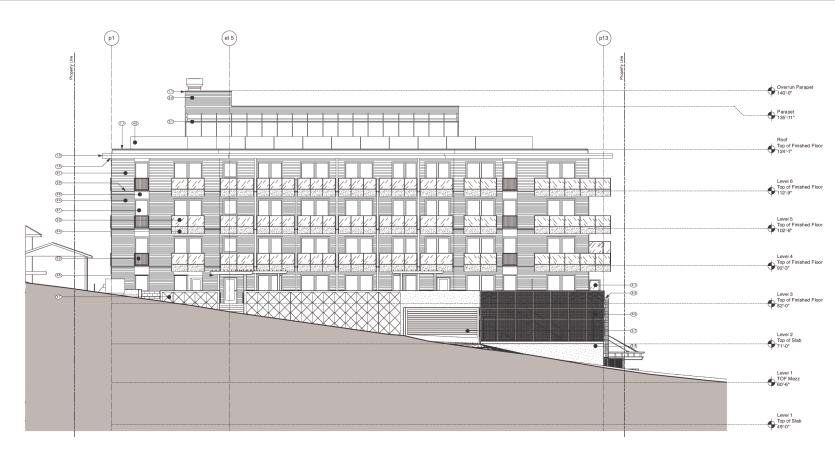

South Elevation A 3.3 Scale: 1/8" = 1'-0"

No.	Material	П	Manufacturer	П	Texture	Colou
1.1	Roof parapet c/w prefinished metal counter and cap flashing	П		П		Iron Ore
1.2	Metal soffit c/w slot ventialtion		Lux metal siding cladding	$^{-}$	Wood grains	Pecan
1.3	Prefinished metal cap flashing over cement board fascia	П	James Harcie	П		Charcoal Gre
2.1	V-Groove siding		Lux metal siding cladding		Wood grains	Pecan
2.2	Fibre cement panel cladding		James Hardie	$^{-}$	Smooth	Iron Gray
2.3	2x2 wood vertical trims on fiber cement panel cladding	Ш	James Hardie	П	Smooth	Iron Gray
2.4	Fibre cement horizontal lap siding cladding		James Hardie	$^{-}$	Cedarmill	Cobble Stone
2.5	2x2 wood vertical trims on fiber cement panel cladding	П	James Hardie	П	Cedarmill	Cobble Stone
2.6	Architectural stone c/w graut	Н	Shouldice	$^{-}$	Tapestry	Desert Buff
2.7	Architectural stone c/w graut	Н	Shouldide	-	HOCK	Desert Buff
2.8	Porcelain slab	Н	Daltile	\top	Matt finish	Obsidian
2.9	Through wall flashing	Н				Charcoal Gre
3.1	Double-glazed vinyl windows & sliding-glazed doors residential	П		П		Charcoar Gre
3.2	Painted Steel entry door	Н		$^{+}$		Iron Gray
3.3	Stanchion glass guardrail system c/w glass & cap	П	AFGD 5mm	П		Clear
3.4	Stanchion glass guardrail system at base	П		\top		Opaque
3.5	Aluminium guardrail	Н		$^{-}$		Iron Ore
3.6	Prefinished metal counter flashing (fascia) c/w metal soffit & slot ventialtion	П		П		Iron Ore
3.7	Parkade garage door residential	П		\Box		
3.8	Double-glazed aluminium windows & sliding-glazed doors retail	П		П		Charcoal Gre
3.9	Parkade garage door retail	н		-		Iron Gray

	SH SCHEDULE			
No.	Material	Manufacturer	Texture	Colour
4.1	Aluminium screen & gates c/w opaque glass			Iron Gray
4.2	Aluminium planters			Iron Gray
4.3	Corten steel planters			Hust
4.4	Wood columns c/w metal clading			Iron Ore
4.5	Heavy timber wood canopy (fire retardant treated wood) c/w painted finish metal connectors and flat cap where exposed			
4.6	Soard formed architectural concrete wall c/w clear elastomeric paint or Allen block planters	- see landscape		
5.1	Wood canopy c/w glass & cables			
5.2	Steel canopy c/w glass & cables			Terra Cotta
5.3	Stone retaining wall	Barkman Architextures		Ash
5.4	Concrete wall, canopy and decorative ledge	Concrete	Sack Rub	
5.5	Aluminium decorative screen			
5.6	Greencable greenery system		Aluminium	
5.7	Aluminium signage		Aluminium	

CORNERSTONE architecture

responsibility to review and verify drawing dimensions, datums and levels. Discrepancies between information of this drawing and actual site conditions and / or the remarking Contract Documents shall be brought to the attention of the Arbitect for clarification prior to proceed with the Work. DO NOT SCALE THE DRAWINGS.

	l	I
5	2023-06-19	Issue for DP Application
4	2023-06-05	Issue for Review
3	2023-04-19	Issue for Review
2	2022-11-07	Issue for Preliminary DP Application
1	2022-08-05	Issue for Review
Num.	YY MM DD	▲ISSUE / REVISION▼
Num.	YY MM DD	▲ISSUE / REVISION♥
Num.	YY MM DD	▲ISSUE / REVISION▼
Num.	YY MM DD	▲ISSUE/REVISION♥
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Num.	YY MM DD	AISSUE / REVISION♥
Num.	YY MM DD	AISSUE / REVISION♥

PROJECT Bosa Foods 2335 St Johns St

BUILDING CODE ZONING DEVELOPMENT PERMIT # BUILDING PERMIT #

DRAWING South Elevation


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SCALE

1/8" = 1'-0" (unless noted otherwise)

PROJECT NO. 2119 DRAWING NO. A3.3

BCBC 2018 RM4, C3

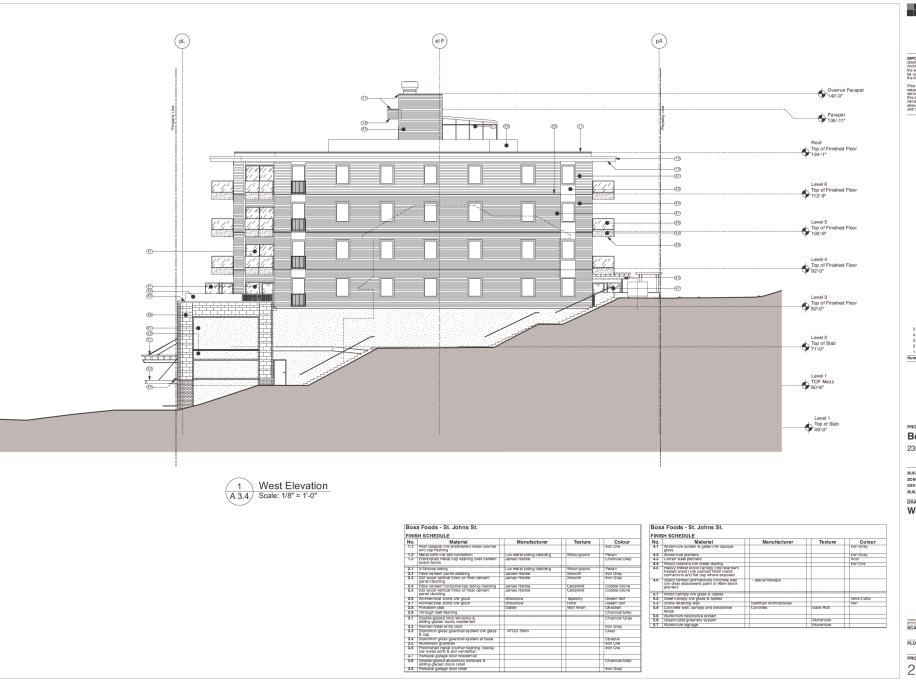

Iron Gray

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Num.	YY MM DD	▲ISSUE / REVISION▼
Num.	YY MM DD	▲ISSUE / REVISION▼
Num.	YY MM DD	▲ISSUE / REVISION▼
Num.	YY MM DD	▲ISSUE / REVISION♥
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Num.	YY MM DD	▲ISSUE/REVISION♥
Num.	YY MM DD	▲ISSUE / REVISION ▼
Num.	YY MM DD	<u>A</u> ISSUE / REVISION ▼

PROJECT Bosa Foods 2335 St Johns St

BUILDING CODE

BUILDING PERMIT#

DRAWING

West Elevation

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SCALE

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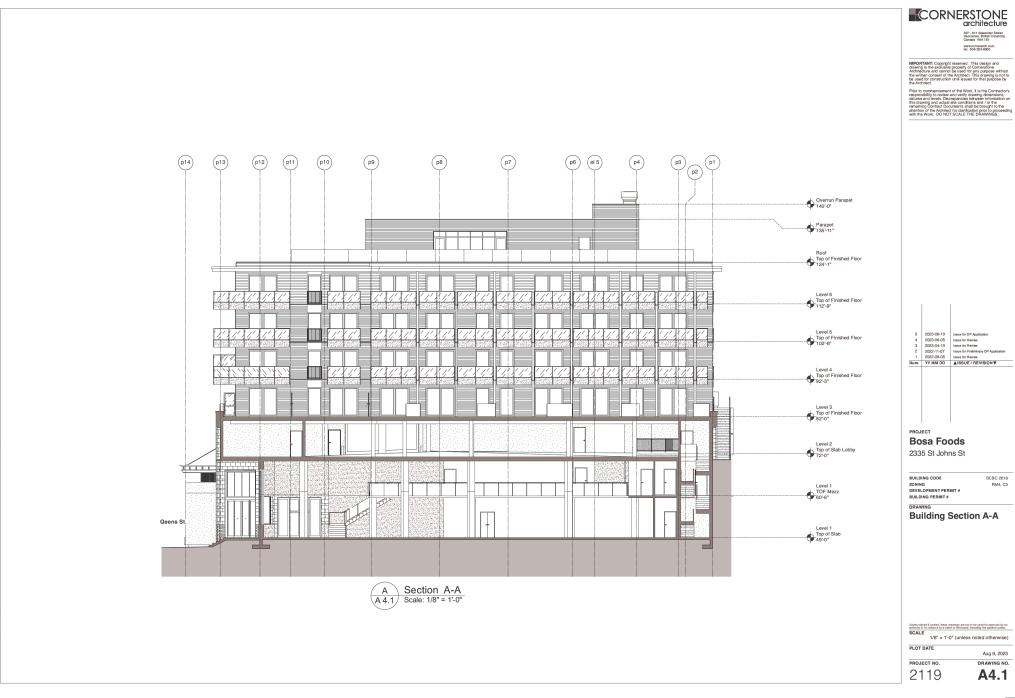
PLOT DATE

PROJECT NO. DRAWING NO


2119

A3.4


BCBC 2018




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4	2023-06-05	Issue for Review
3	2023-04-19	Issue for Review
2	2022-11-07	Issue for Preliminary DP Application
1	2022-08-05	Issue for Review
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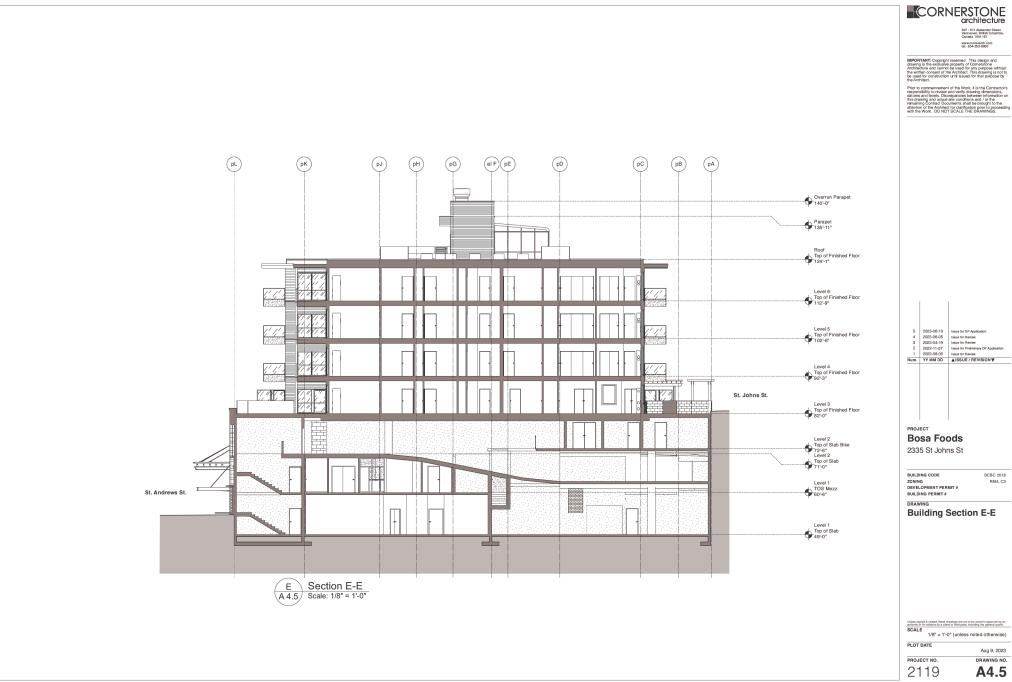
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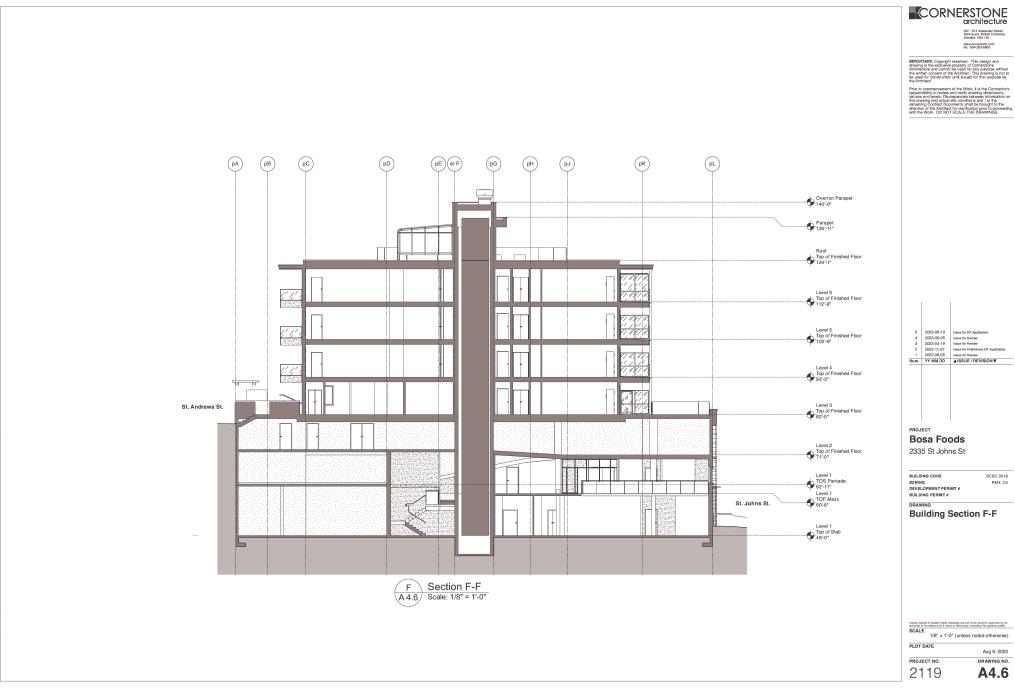
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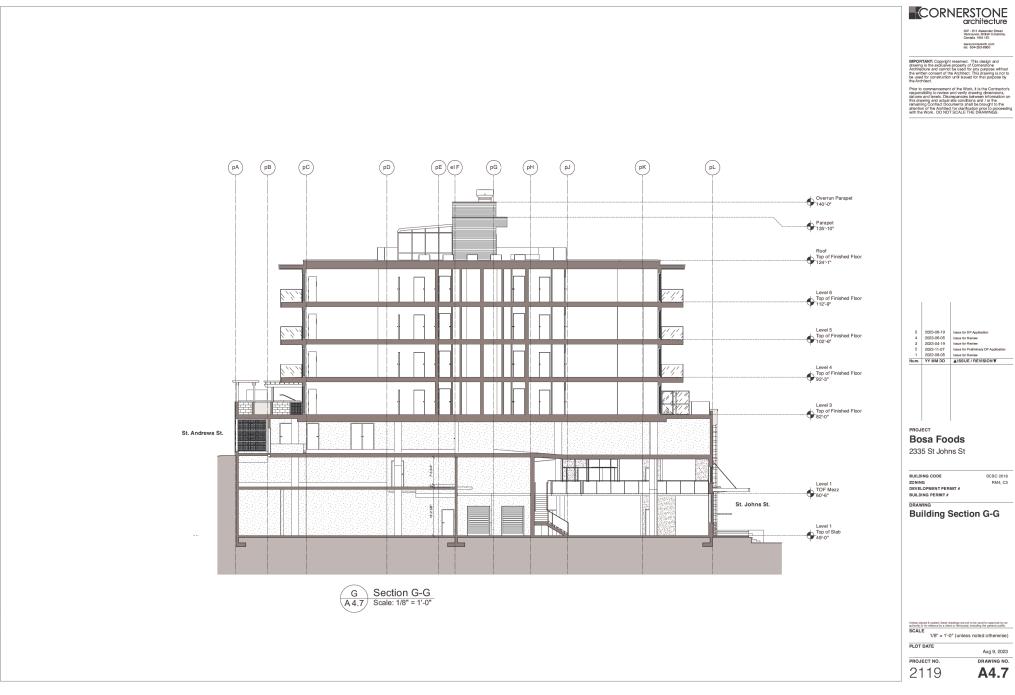
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1	2022-08-05	Issue for Review
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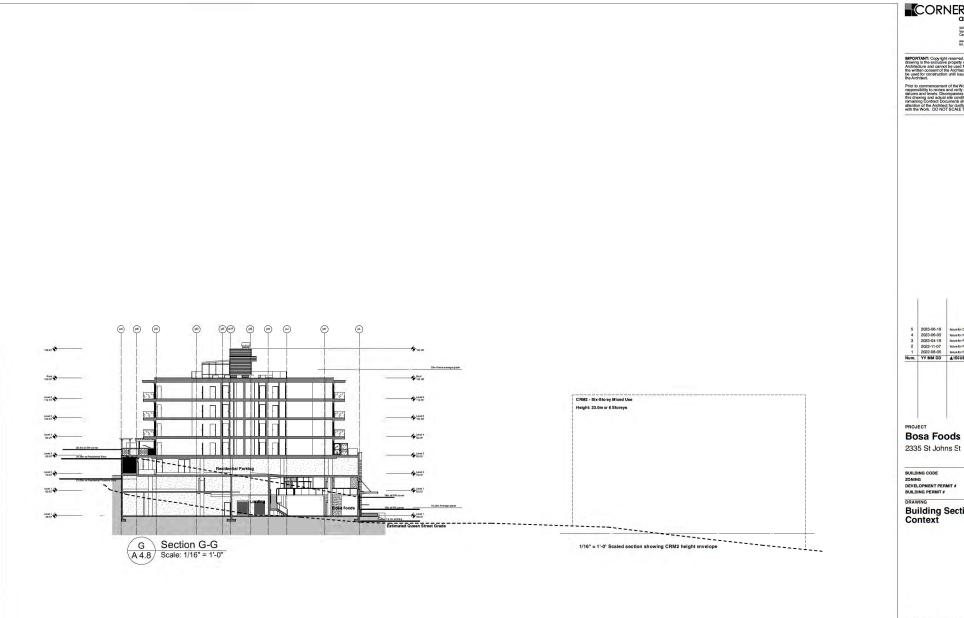


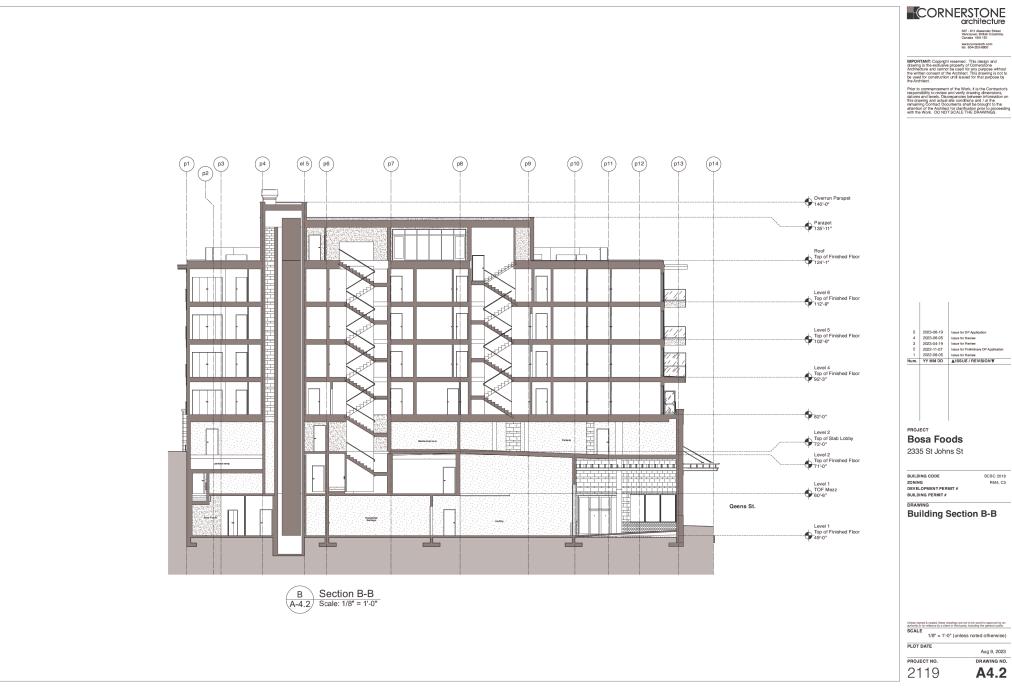

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Bosa Foods

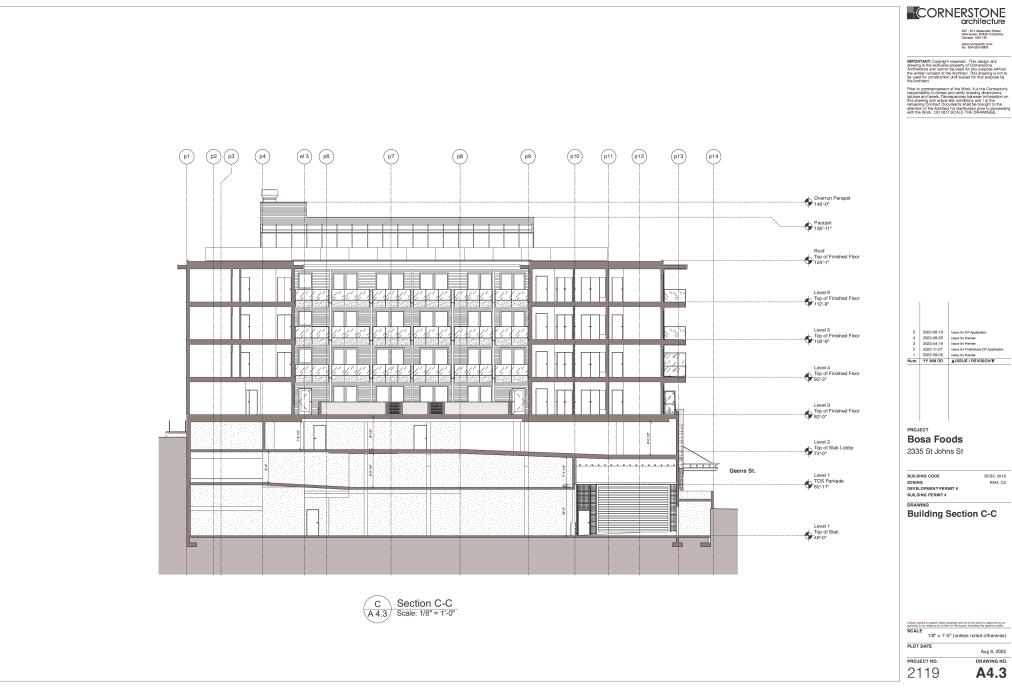Building Section G-G Context

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SCALE

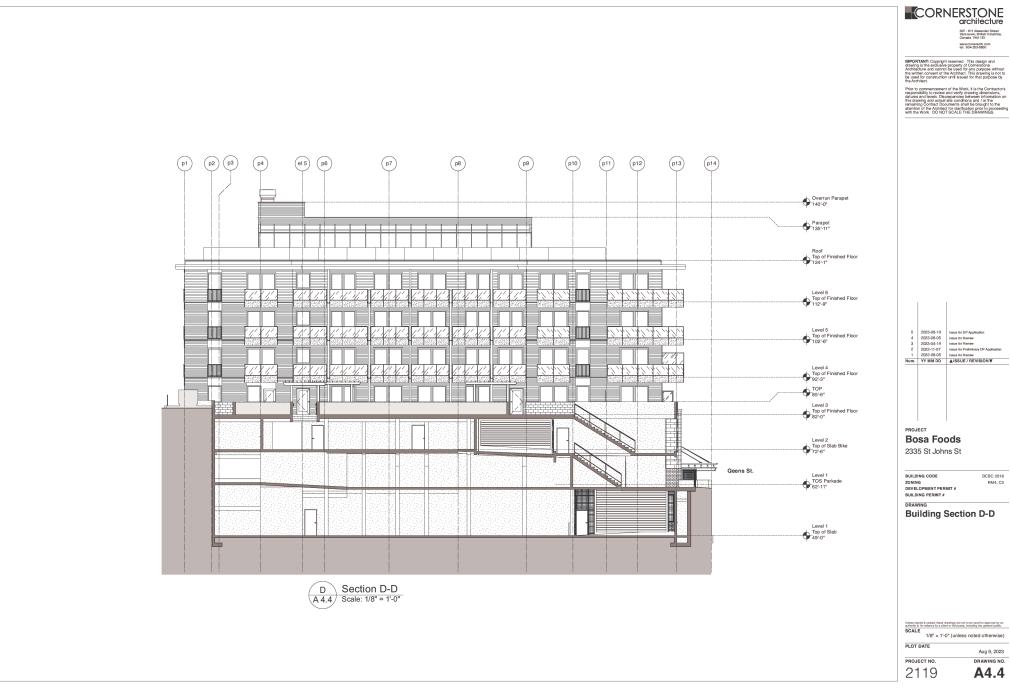1/8" = 1'-0" (unless noted otherwise)

PLOT DATE

PROJECT NO.

DRAWING NO.

2119

A4.8


BCBC 2018 RM4, C3



Top down view of the site



Northeast aerial view

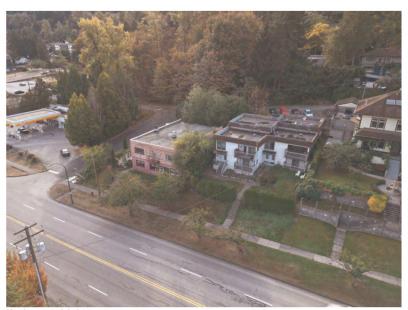

Northwest aerial view



Southeast aerial view

CORNERSTONE architecture

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-04-19 -11-07	Issue for Review Issue for Review Issue for Preliminary DP Application Issue for Review
-04-19	Issue for Review
-06-05	Issue for Review
-06-19	Issue for DP Application
	-06-19

PROJECT

Bosa Foods 2335 St Johns St

BUILDING CODE ZONING DEVELOPMENT PERMIT # BUILDING PERMIT #

Site Photos

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SCALE

1/9" — 11 0" (uniform ported of the province)

PLOT DATE

PROJECT NO.

2119 **A6.1**

DRAWING NO.



View across the Northwest intersection from the proposed podium level



View towards the West from the proposed level 6 deck



View towards the East from the proposed level 6 deck



View towards the North from the proposed level 6 deck

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	2022-08-05	Issue for Review
2 :	2022-11-07	Issue for Preliminary DP Application
	2023-04-19	Issue for Review
	2023-06-05	Issue for Review
	2023-06-19	Issue for DP Application

Bosa Foods 2335 St Johns St

BUILDING CODE ZONING DEVELOPMENT PERMIT # BUILDING PERMIT # DRAWING

Site Photos

PLOT DATE

PROJECT NO. 2119

A6.2

DRAWING NO.



Northeast View
| Scale: 1/4" = 1'-0"



CORNERSTONE architecture

5 2023-06-19 Issue for DP Application
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3 2023-04-19 Issue for Review
2 2022-11-07 Issue for Preview
1 2022-08-05 Issue for Preview PApplic
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PROJECT **Bosa Foods**

2335 St Johns St

BUILDING CODE ZONING DEVELOPMENT PERMIT # BUILDING PERMIT #

DRAWING

Perspective view

PROJECT NO. DRAWING NO.

2119

A6.3

Southeast View
A 6.3 Scale: 1/4" = 1'-0"



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5 2023-06-19 Issue for DP Application
4 2023-06-05 Issue for Review
3 2023-04-19 Issue for Review
2 2022-11-17 Issue for Preview
1 2022-08-05 Issue for Review
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PROJECT **Bosa Foods**

2335 St Johns St

BUILDING CODE ZONING DEVELOPMENT PERMIT # BUILDING PERMIT #

DRAWING

Perspective view

DRAWING NO.

2 Southwest View A 6.4 Scale: 1/4" = 1'-0"

Northwest View
Scale: 1/4" = 1'-0"



PROJECT NO.

2119

A6.4



CORNERSTONE architecture

1 Main Entry View Scale: 3/16" = 1'-0"



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2 2022-11-07 Issue for Preliminary DP Applica
1 2022-08-05 Issue for Preliminary DP Applica
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PROJECT **Bosa Foods**

2335 St Johns St

BUILDING CODE ZONING DEVELOPMENT PERMIT # BUILDING PERMIT # DRAWING

Perspective view

BCBC 2018 RM4, C3

DRAWING NO.

A6.5

PROJECT NO.

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2 Retail Parking Entry A 6.5 Scale: 3/16" = 1'-0"



CORNERSTONE architecture

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	2023-04-19	Issue for Review
4	2023-06-05	Issue for Review
5	2023-06-19	Issue for DP Application

PROJECT **Bosa Foods**

2335 St Johns St

BUILDING CODE ZONING DEVELOPMENT PERMIT # BUILDING PERMIT #

DRAWING

Perspective View

PLOT DATE

PROJECT NO.

2119

DRAWING NO. A6.6